
COUNTY OF LOS ANGELES PUBLIC WORKS DEPARTMENT OF ANIMAL CARE AND CONTROL HEADQUARTERS FENCING PROJECT

5898 Cherry Ave, Long Beach, CA 90805

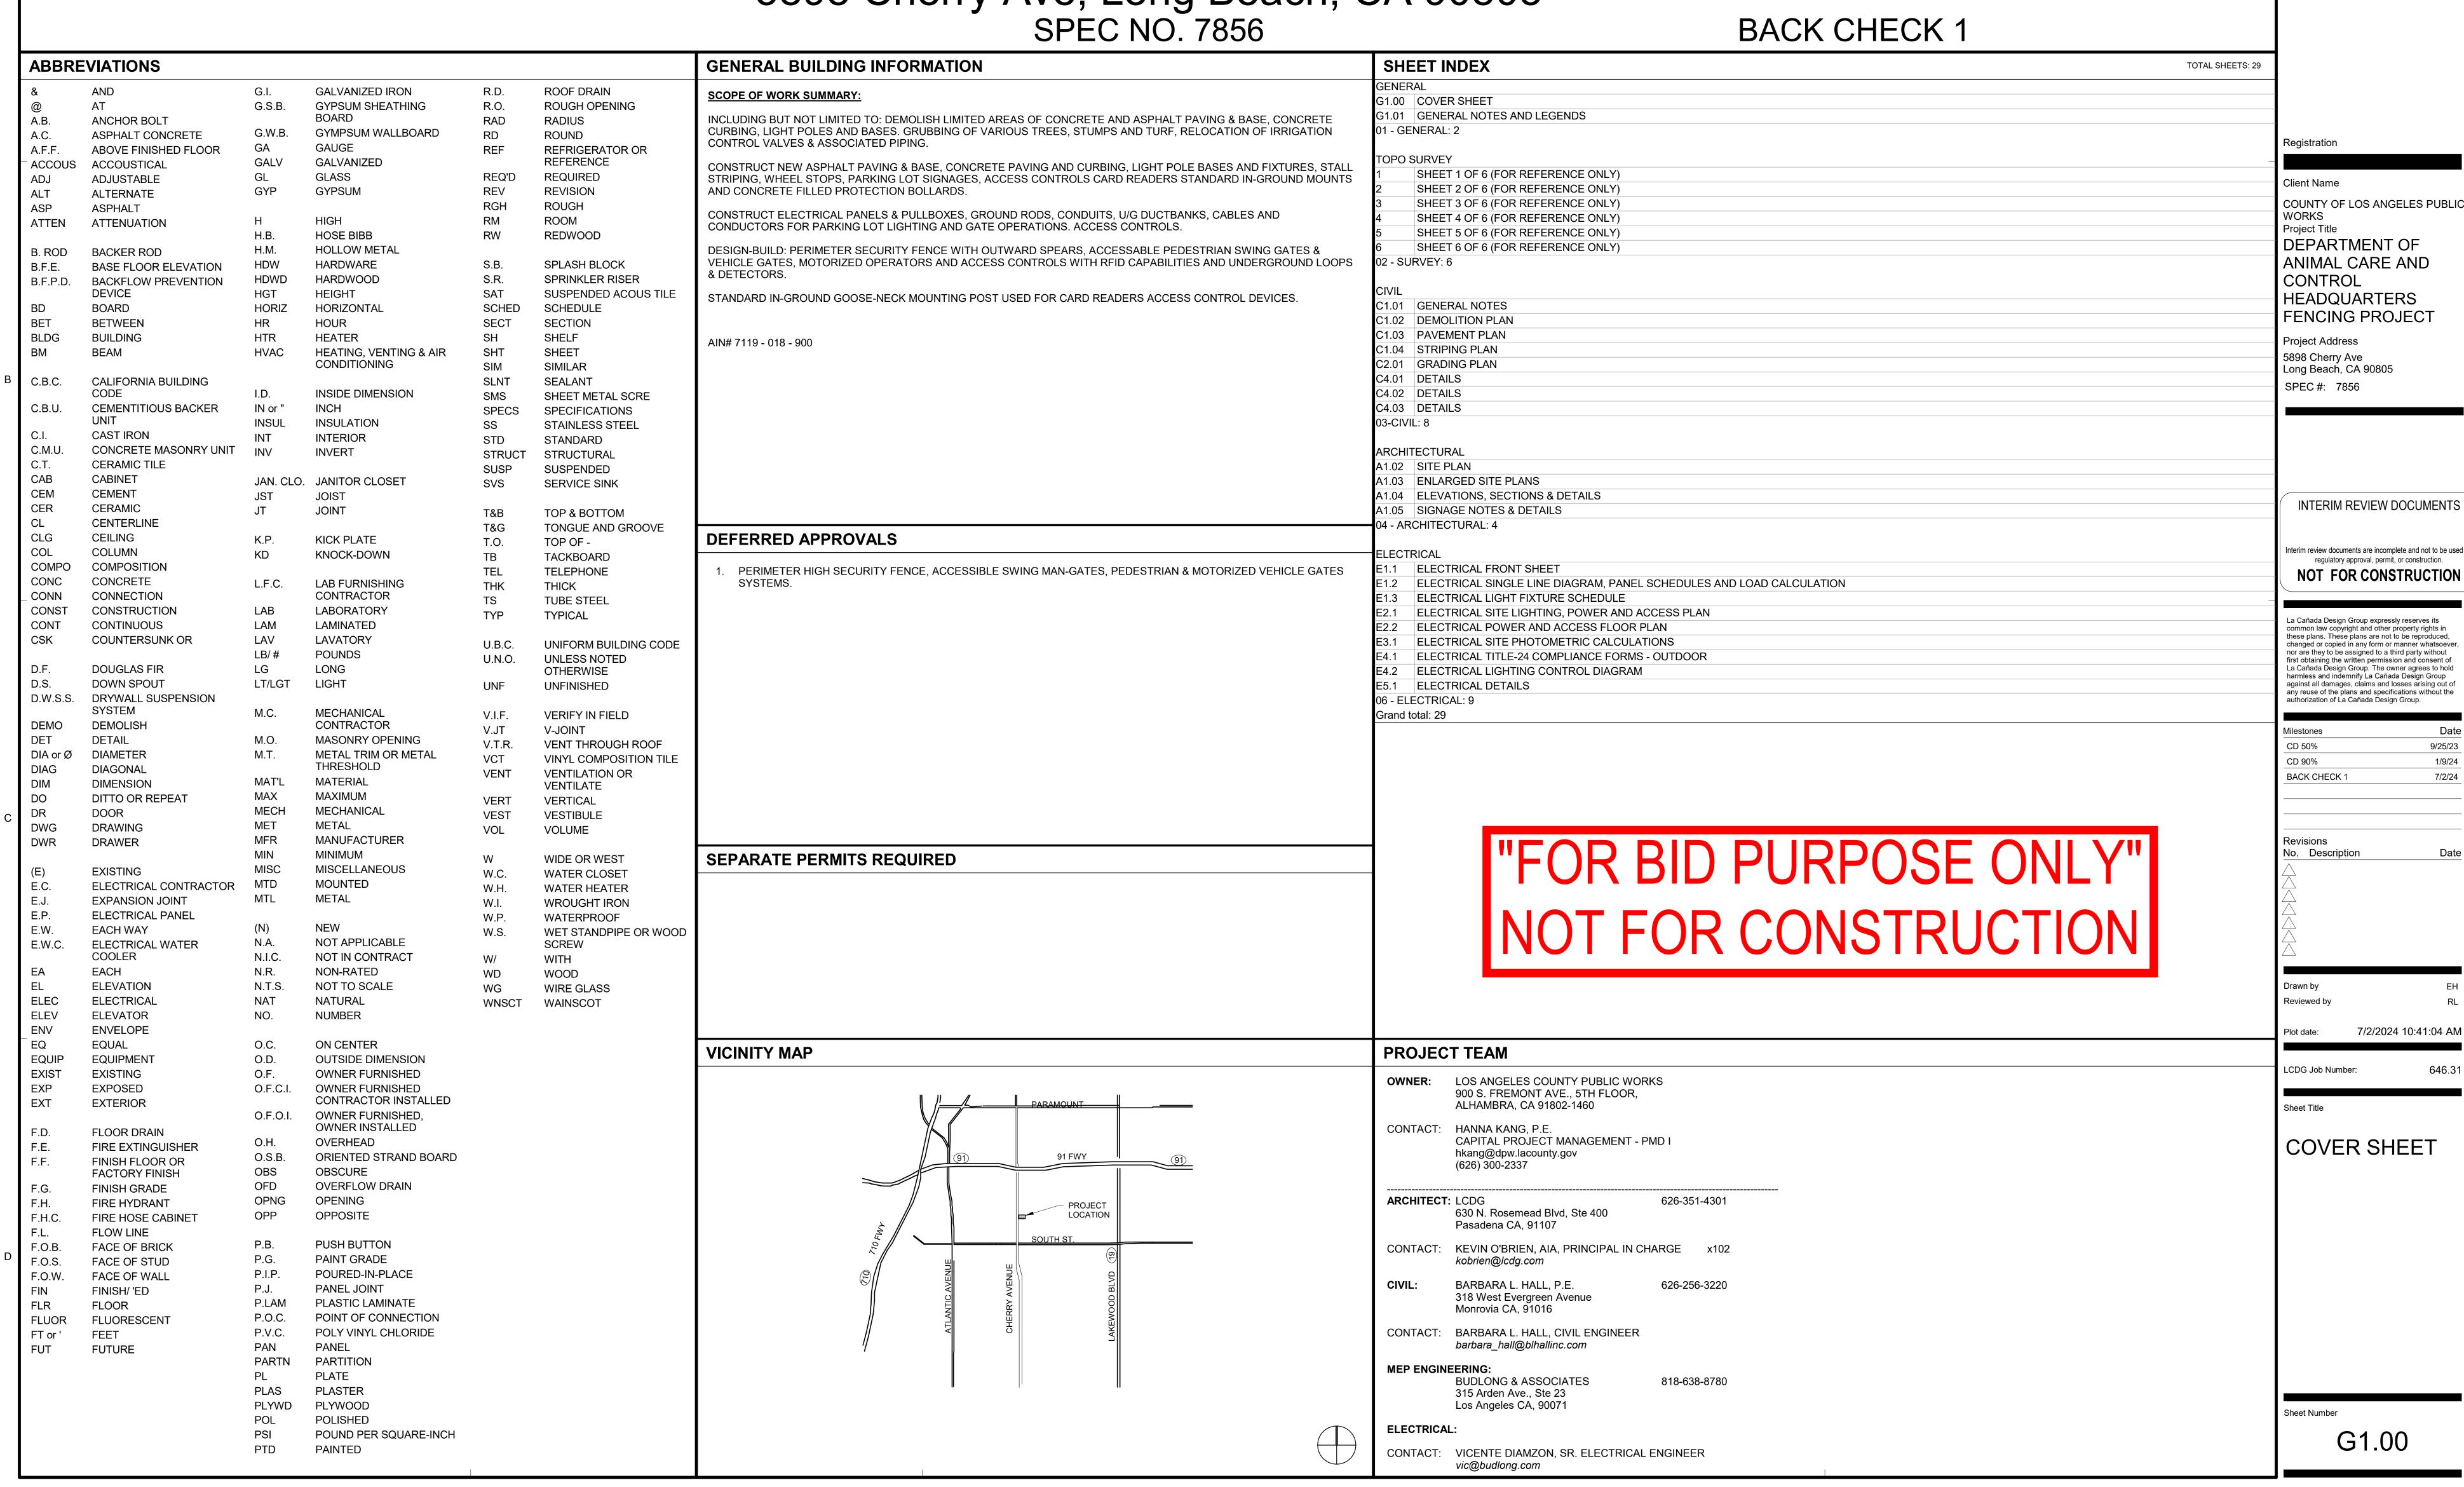

La Cañada Design Group **Architecture**

630 N. Rosemead Boulevard, Suite 400 Pasadena, California 91107 (626) 351-4301 FAX (626)351-4302 www.lcdg.com

Planning Interiors

nterim review documents are incomplete and not to be used for regulatory approval, permit, or construction.

9/25/23 1/9/24 7/2/24

7/2/2024 10:41:04 AM

INTERIOR ELEVATION

SHEET WHERE DRAWN

CASEWORK DESCRIPTION

BENCH MARK/WORK POINT

REFERRED DRAWING VIEW

ELEVATION NUMBER

UNIT HEIGHT

MATCHLINE

NORTH ARROW

WI UNIT NUMBER

 $X \langle (AX.XX) \rangle X_{--}$

XX XXX XX

A1/AX.XX

WIDTH -

WINDOW

(E) WINDOW

(E) LAVATORY

(E) URINAL

(E) WATER CLOSET

 \bigcirc

LAVATORY, REF PLUMBING DRAWINGS

URINAL, PER PLUMBING DRAWINGS

WATER CLOSET, REF PLUMBING DRAWINGS

9/25/23

Sheet Number

G1.01

WOOD CEILING, FINISH AS SCHEDULED


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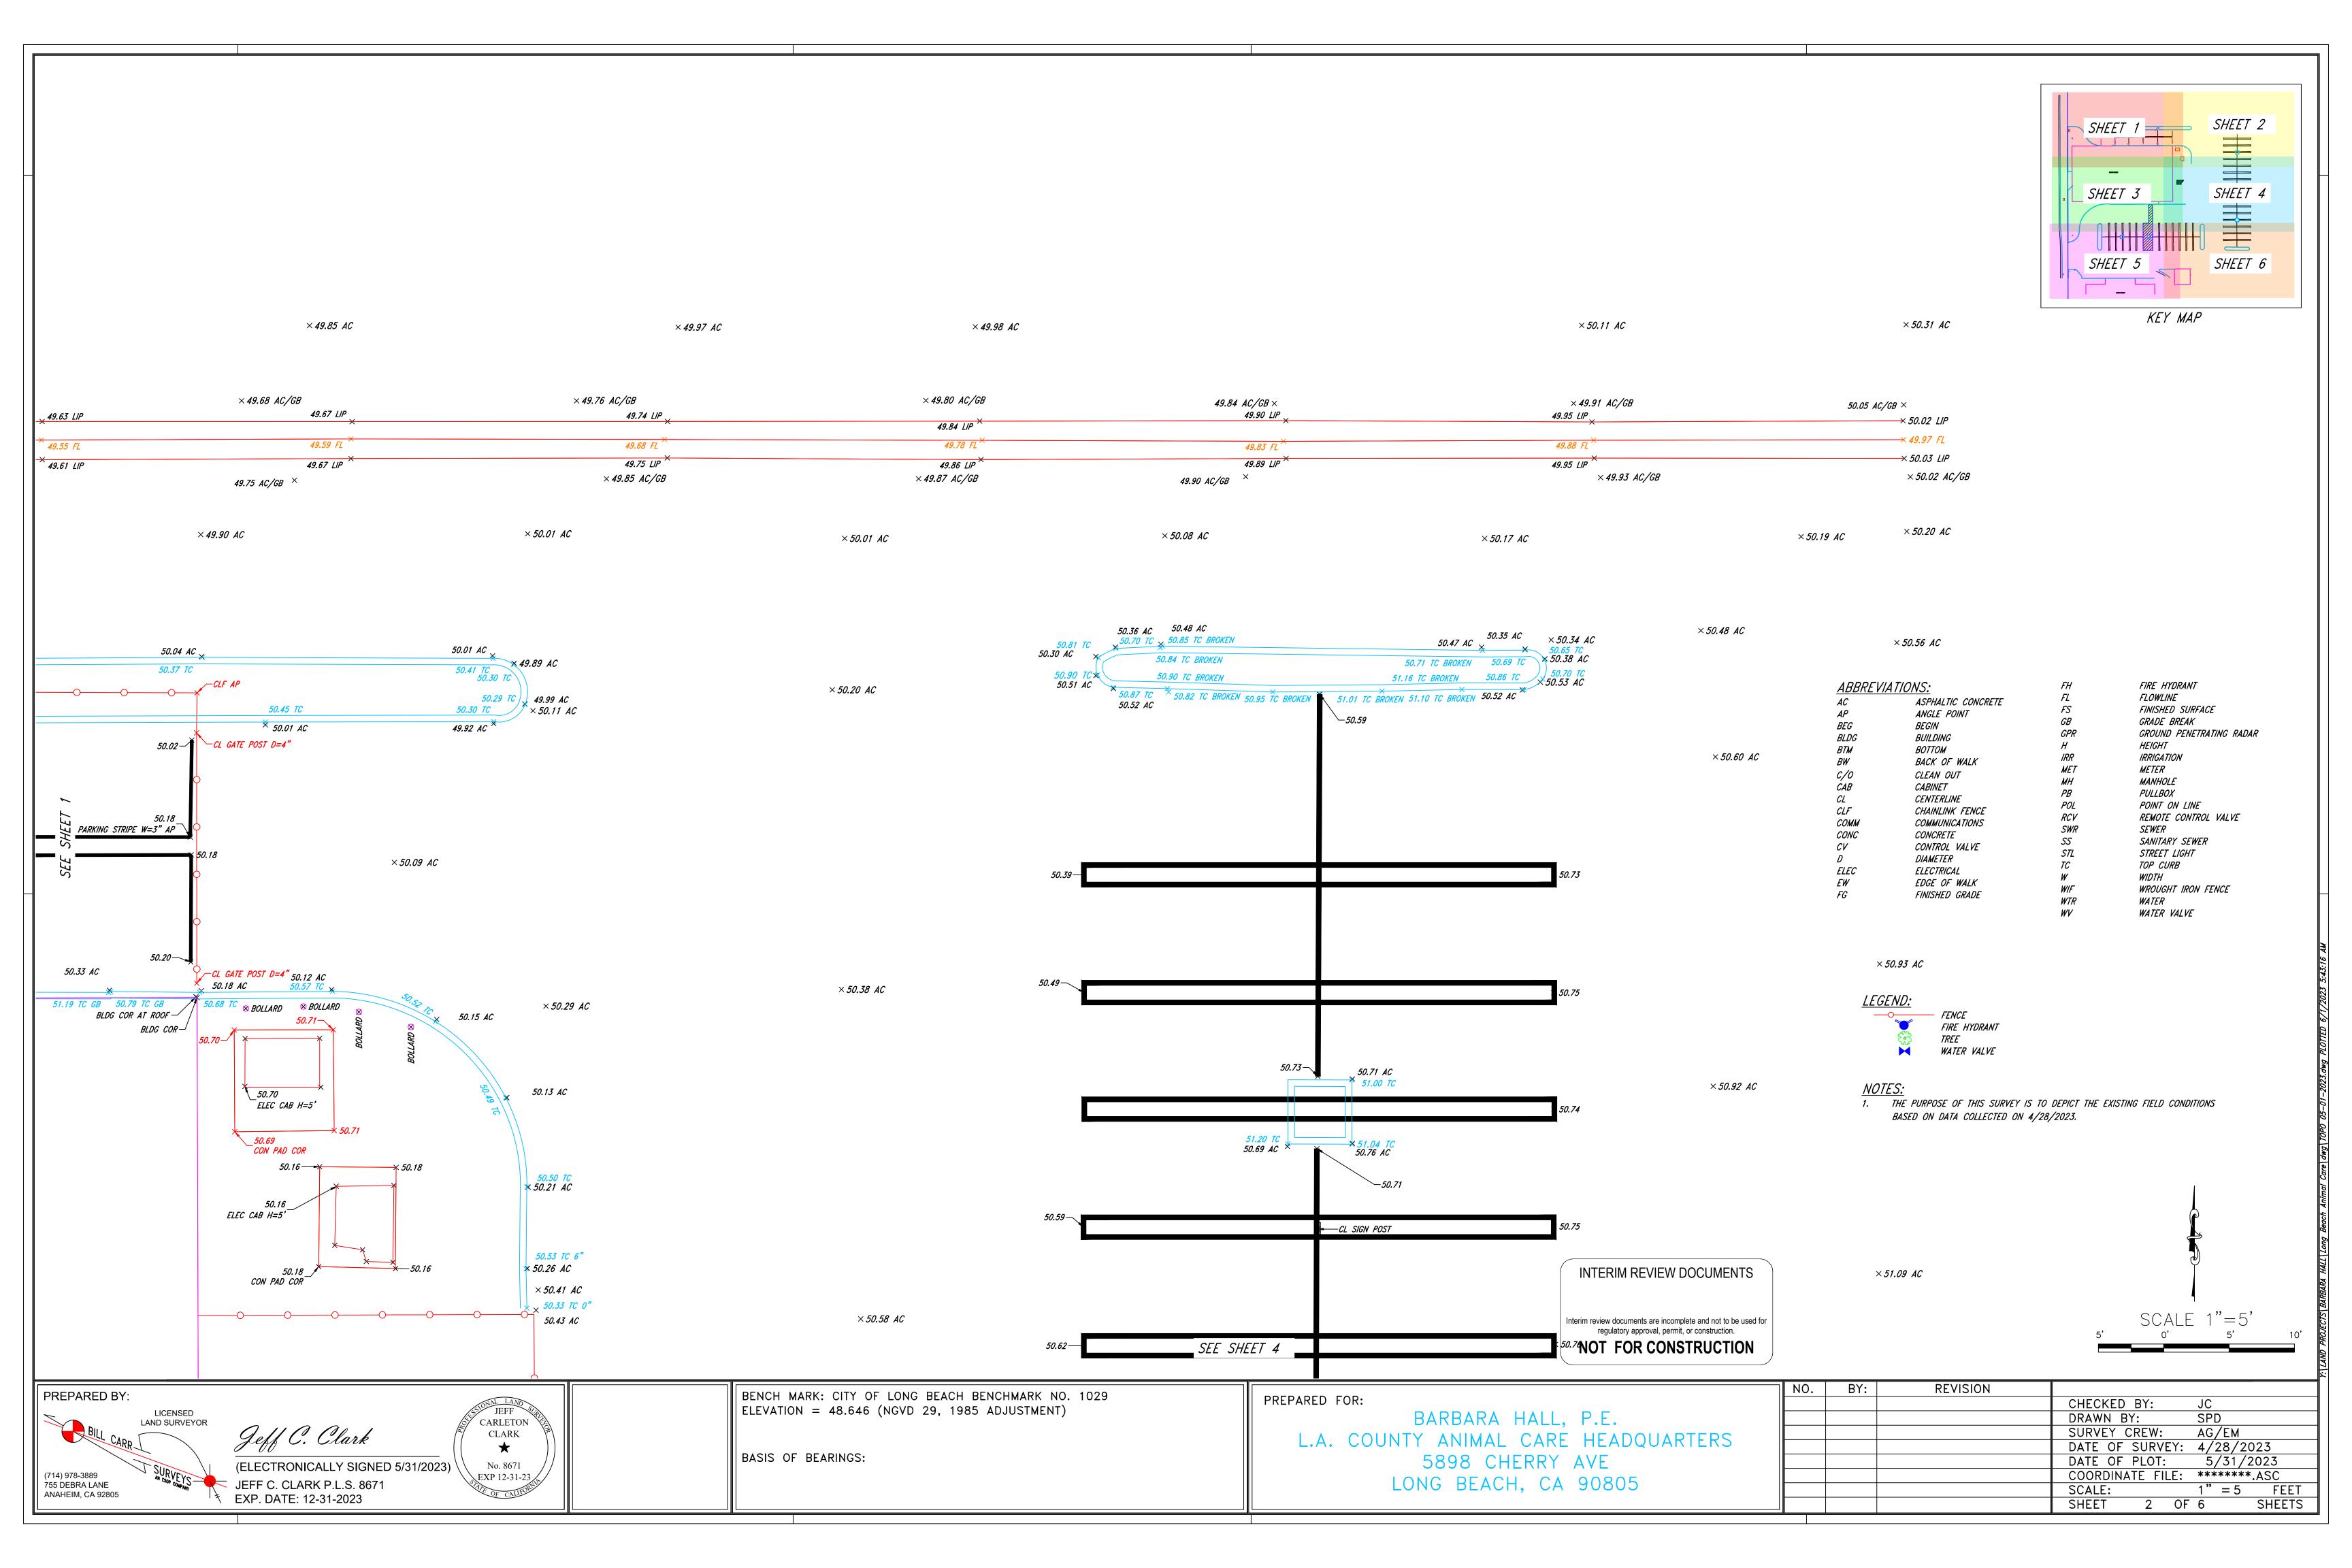
CEILING ACCESS HATCH


III - 6. MINIMUM THICKNESS OF UNREINFORCED CONC. WALKS AND SLABS IS 4". PROVIDE CONTROL JOINTS AS SHOWN. WHERE CONTROL JOINTS ARE NOT SHOWN PROVIDE JOINTS IN SQUARES SAME WIDTH OF WALK. PROVIDE COLD JOINTS IN CONCRETE PAVED AREAS WHERE SHOWN OR AT MAXIMUM SPACING OF 20'-0", SEE SPECS. EXTERIOR SLAB AND WALKS SHALL HAVE EXPANSION JOINTS ONLY WHERE SHOWN ON DRAWINGS. CONCRETE CURBS SHALL HAVE EXPANSION JOINTS AT 40'-0" O.C. MAX AND ALIGNED WITH WALK CONSTRUCTION JOINTS TYPICALLY.


III - 7. FIELD VERIFY THE EXACT LOCATION OF BELOW GROUND PIPING AND UTILITIES IN THE IMMEDIATE VICINITY OF THE WORK, WHETHER SHOWN ON DRAWINGS OR NOT. MARK ALL EXISTING PIPING AND UTILITIES AFFECTED BY THE WORK USING AN UNDERGROUND PIPE LOCATOR TO LOCATE POSITION OF PIPES AND CONDUITS AND BY SPRAY PAINTING OF PIPES AND CONDUITS ON THE SURFACE. THE CONTRACTOR SHALL ADD THE EXISTING UNDERGROUND UTILITIES FOUND DURING BLUESTAKING TO DRAWINGS FOR RECORD. CONTRACTOR SHALL RESPONSIBLE FOR ANY DAMAGE THAT MIGHT BE OCCASIONED BY THE CONTRACTOR'S FAILURE TO EXACTLY LOCATE ANY AND ALL UNDERGROUND UTILITIES.


III - 8. FOR CABINETS THAT REQUIRED LOCKS, ALL SUCH LOCKS SHALL BE KEYED ALIKE.




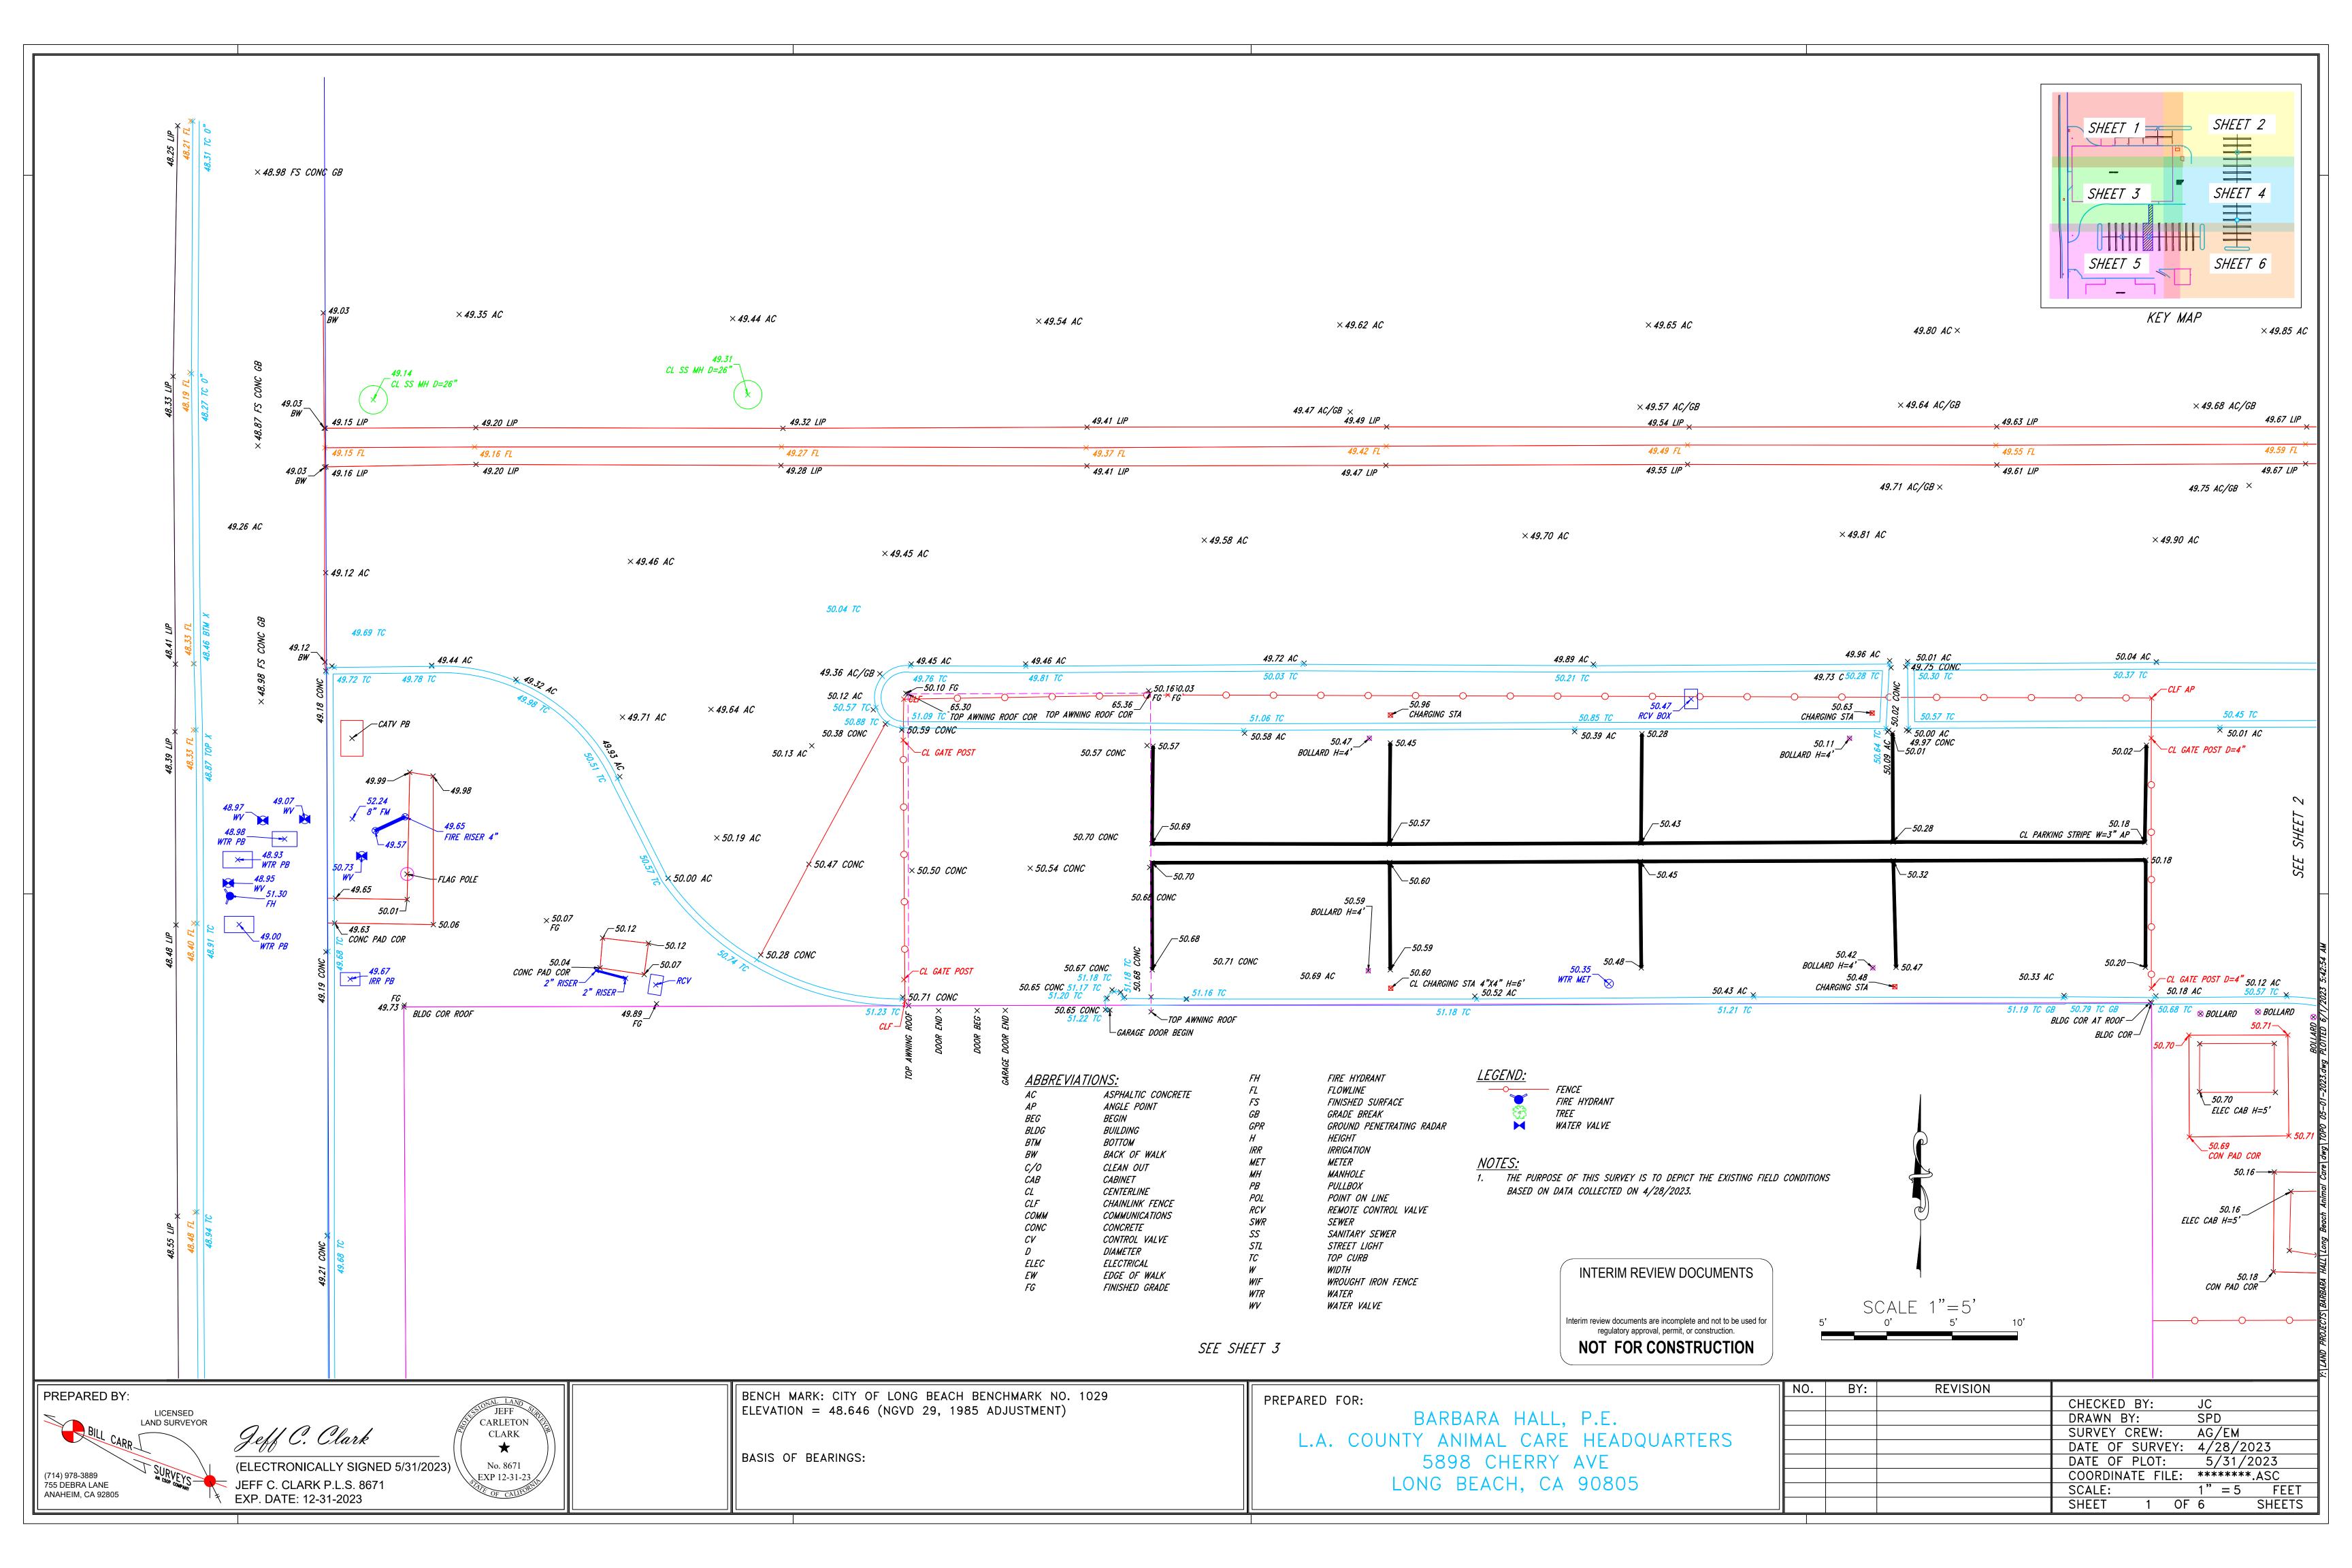

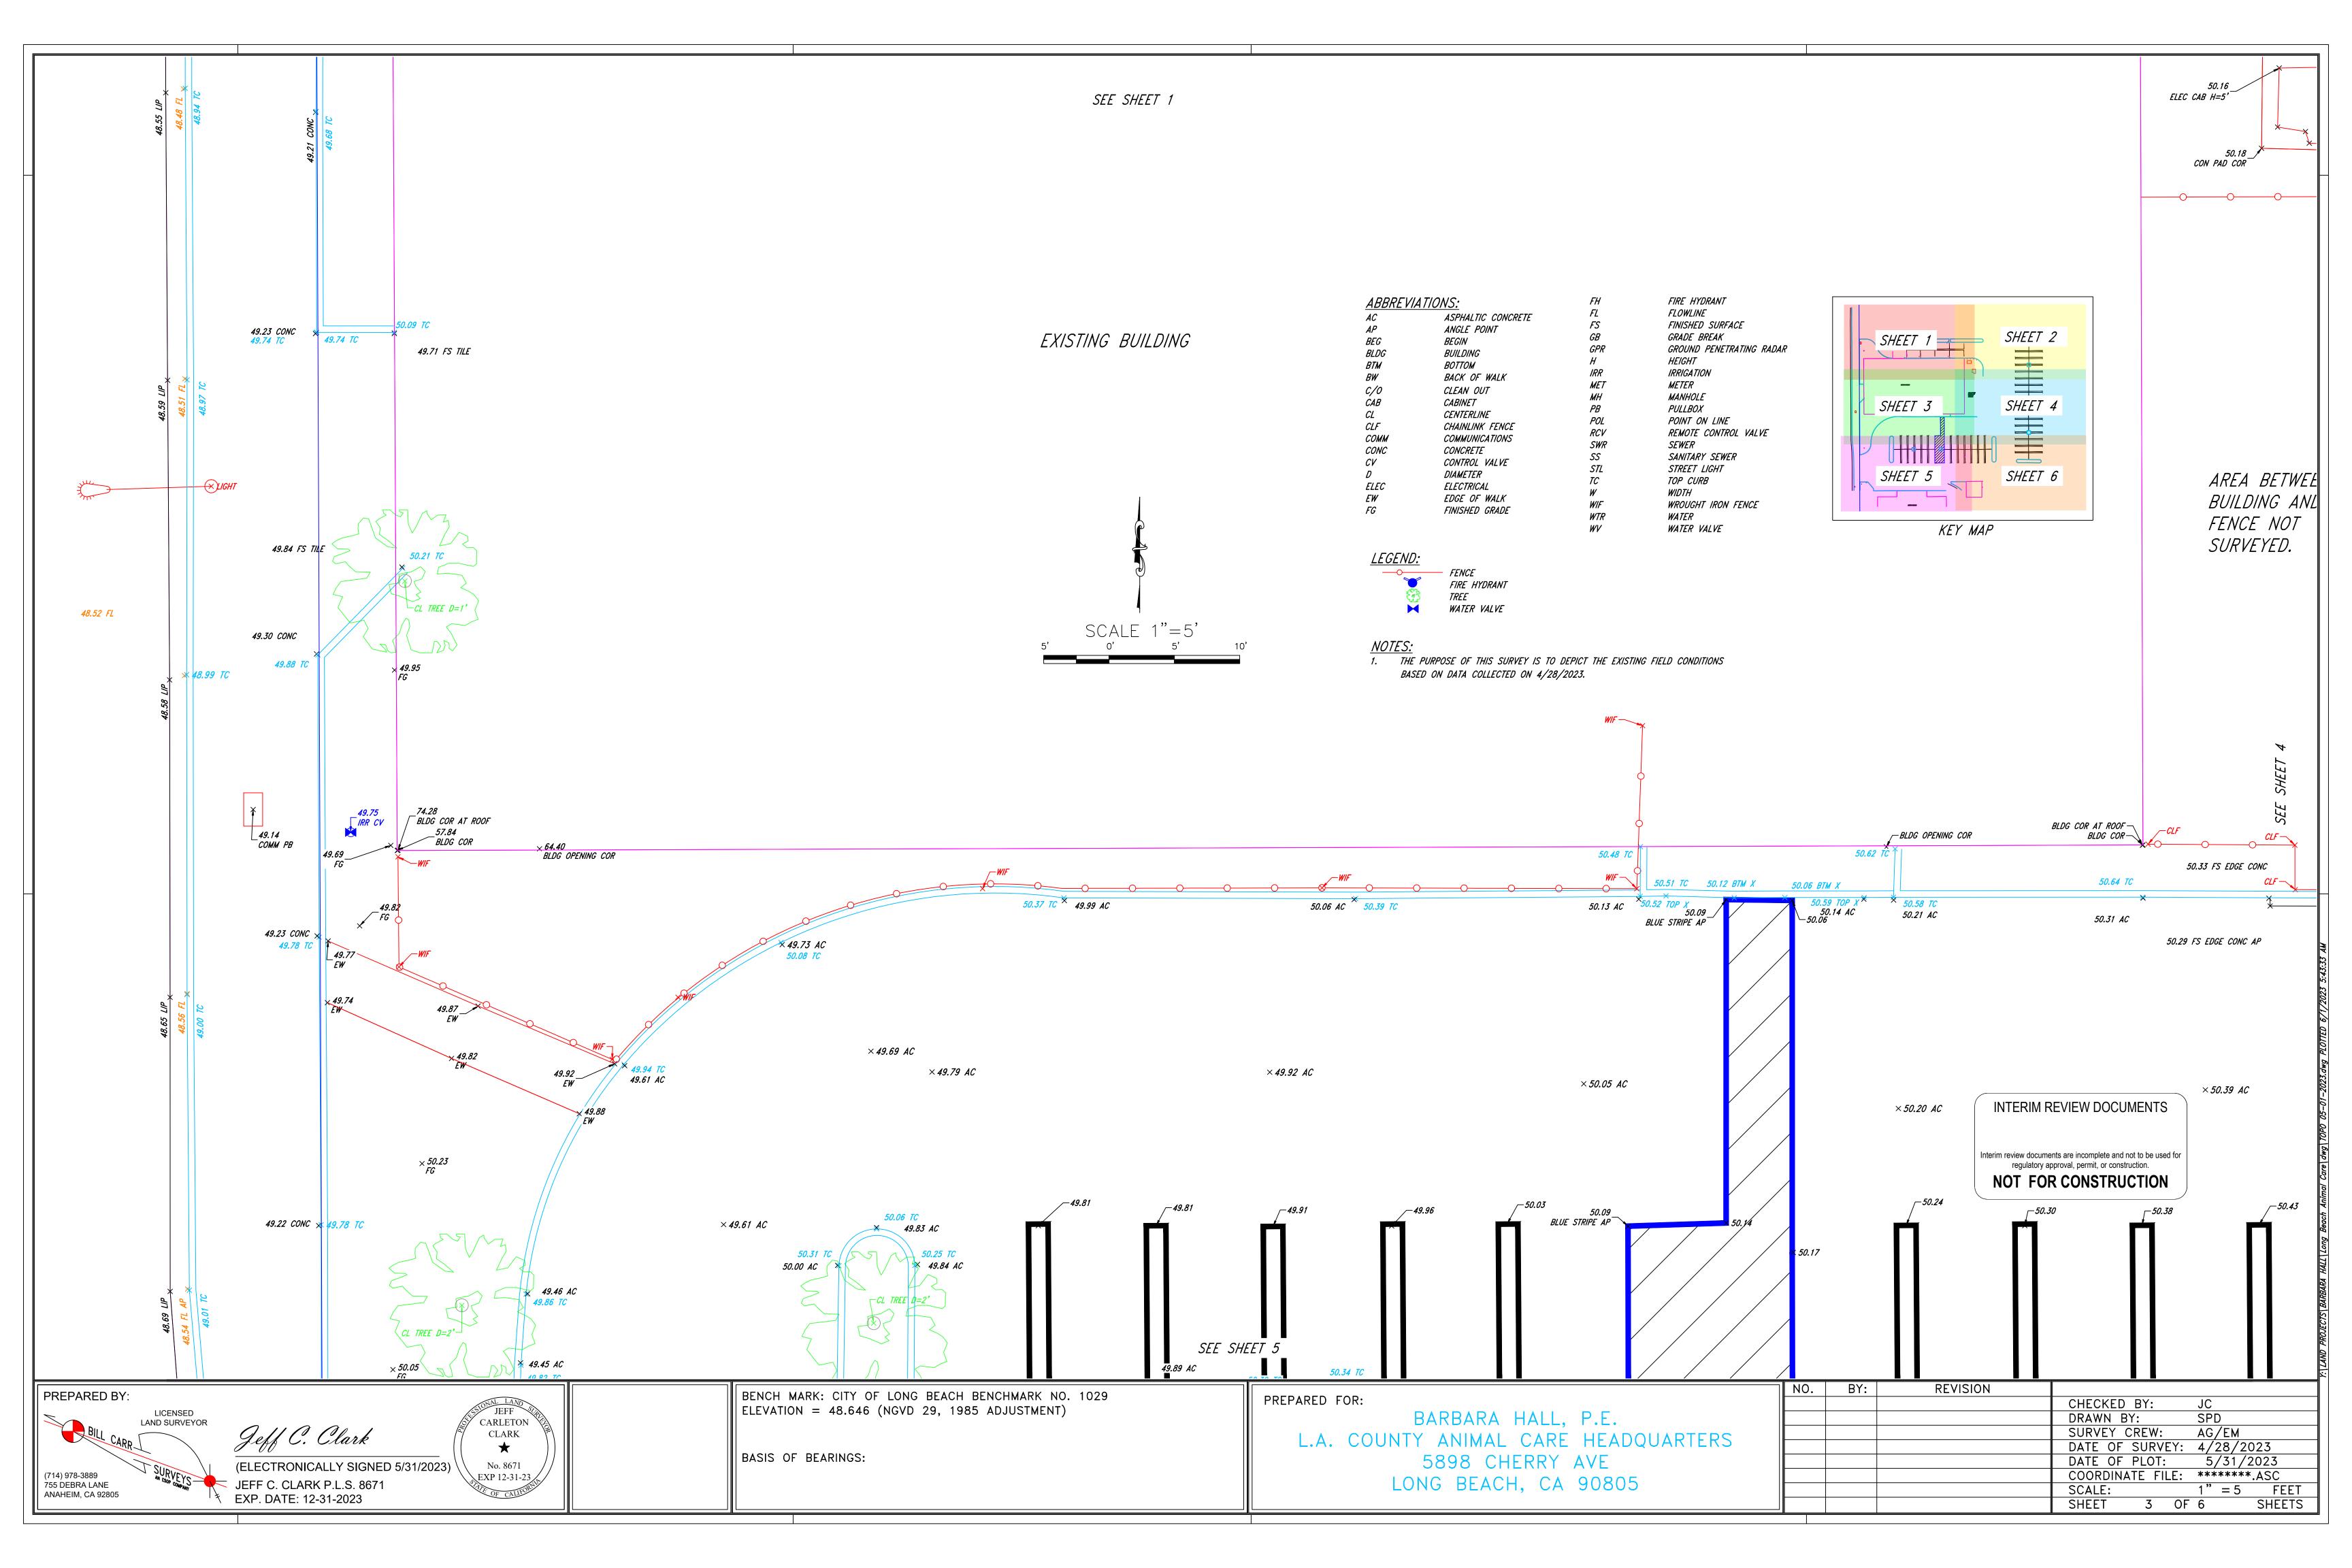

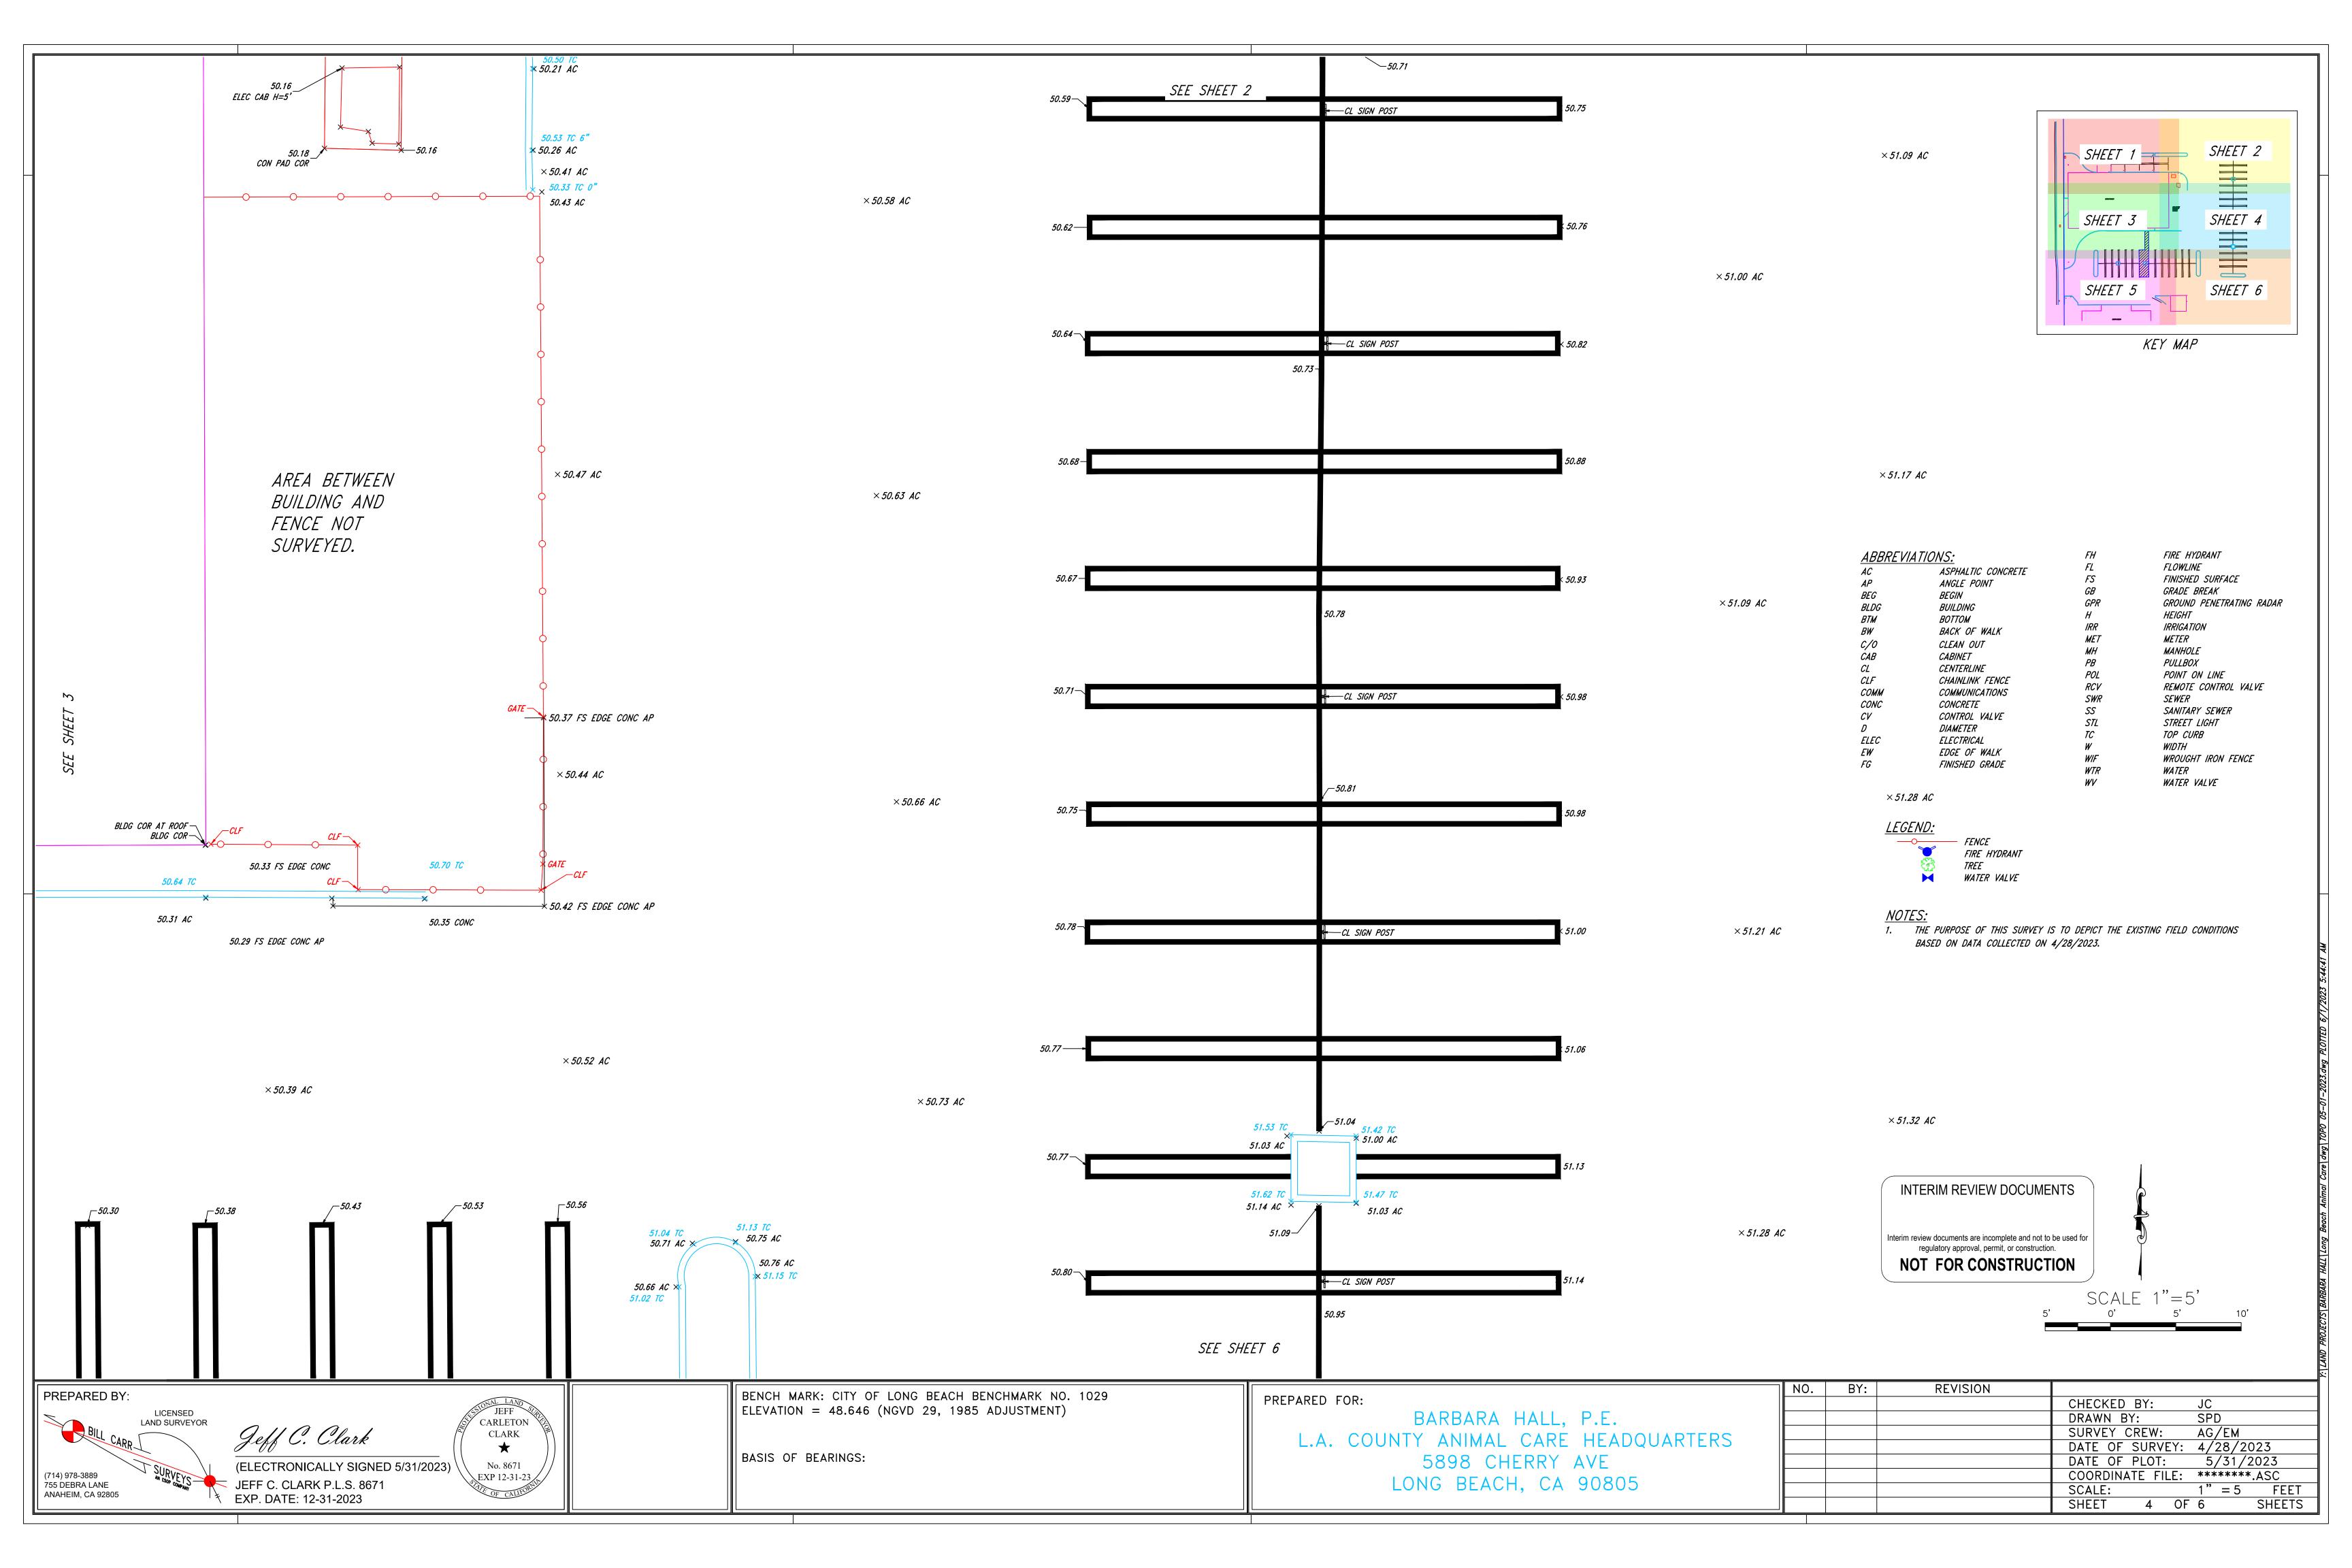

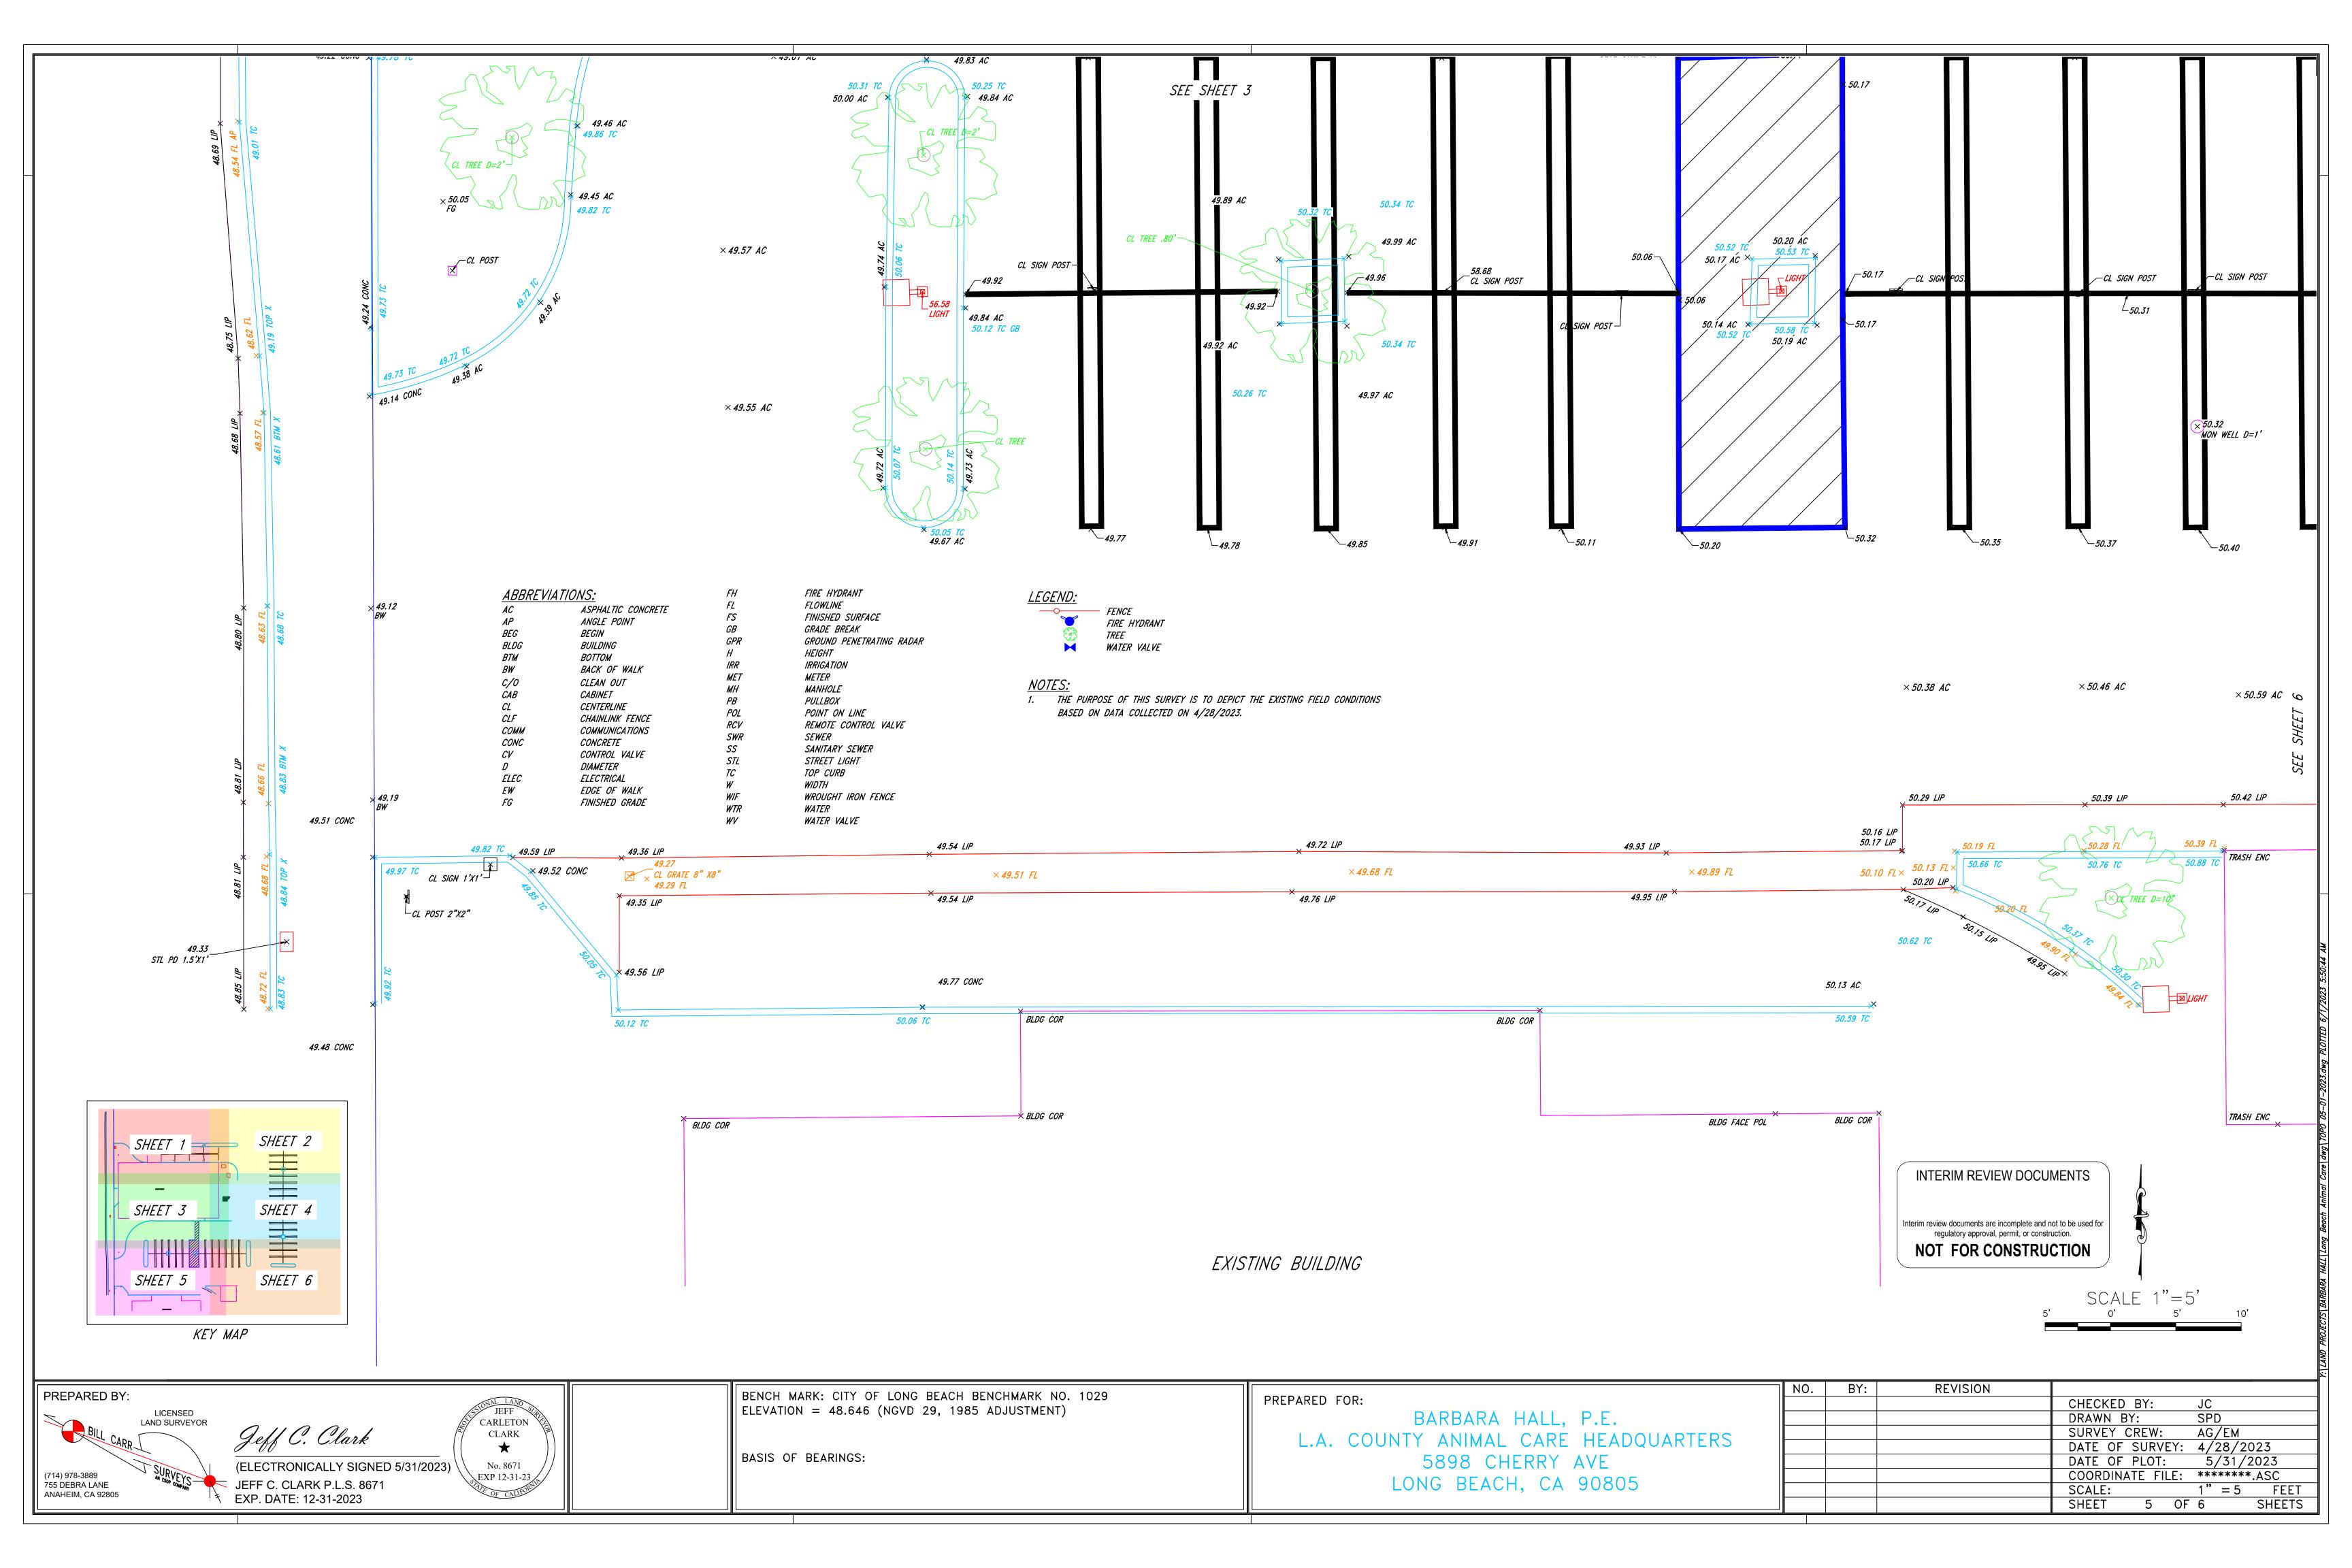

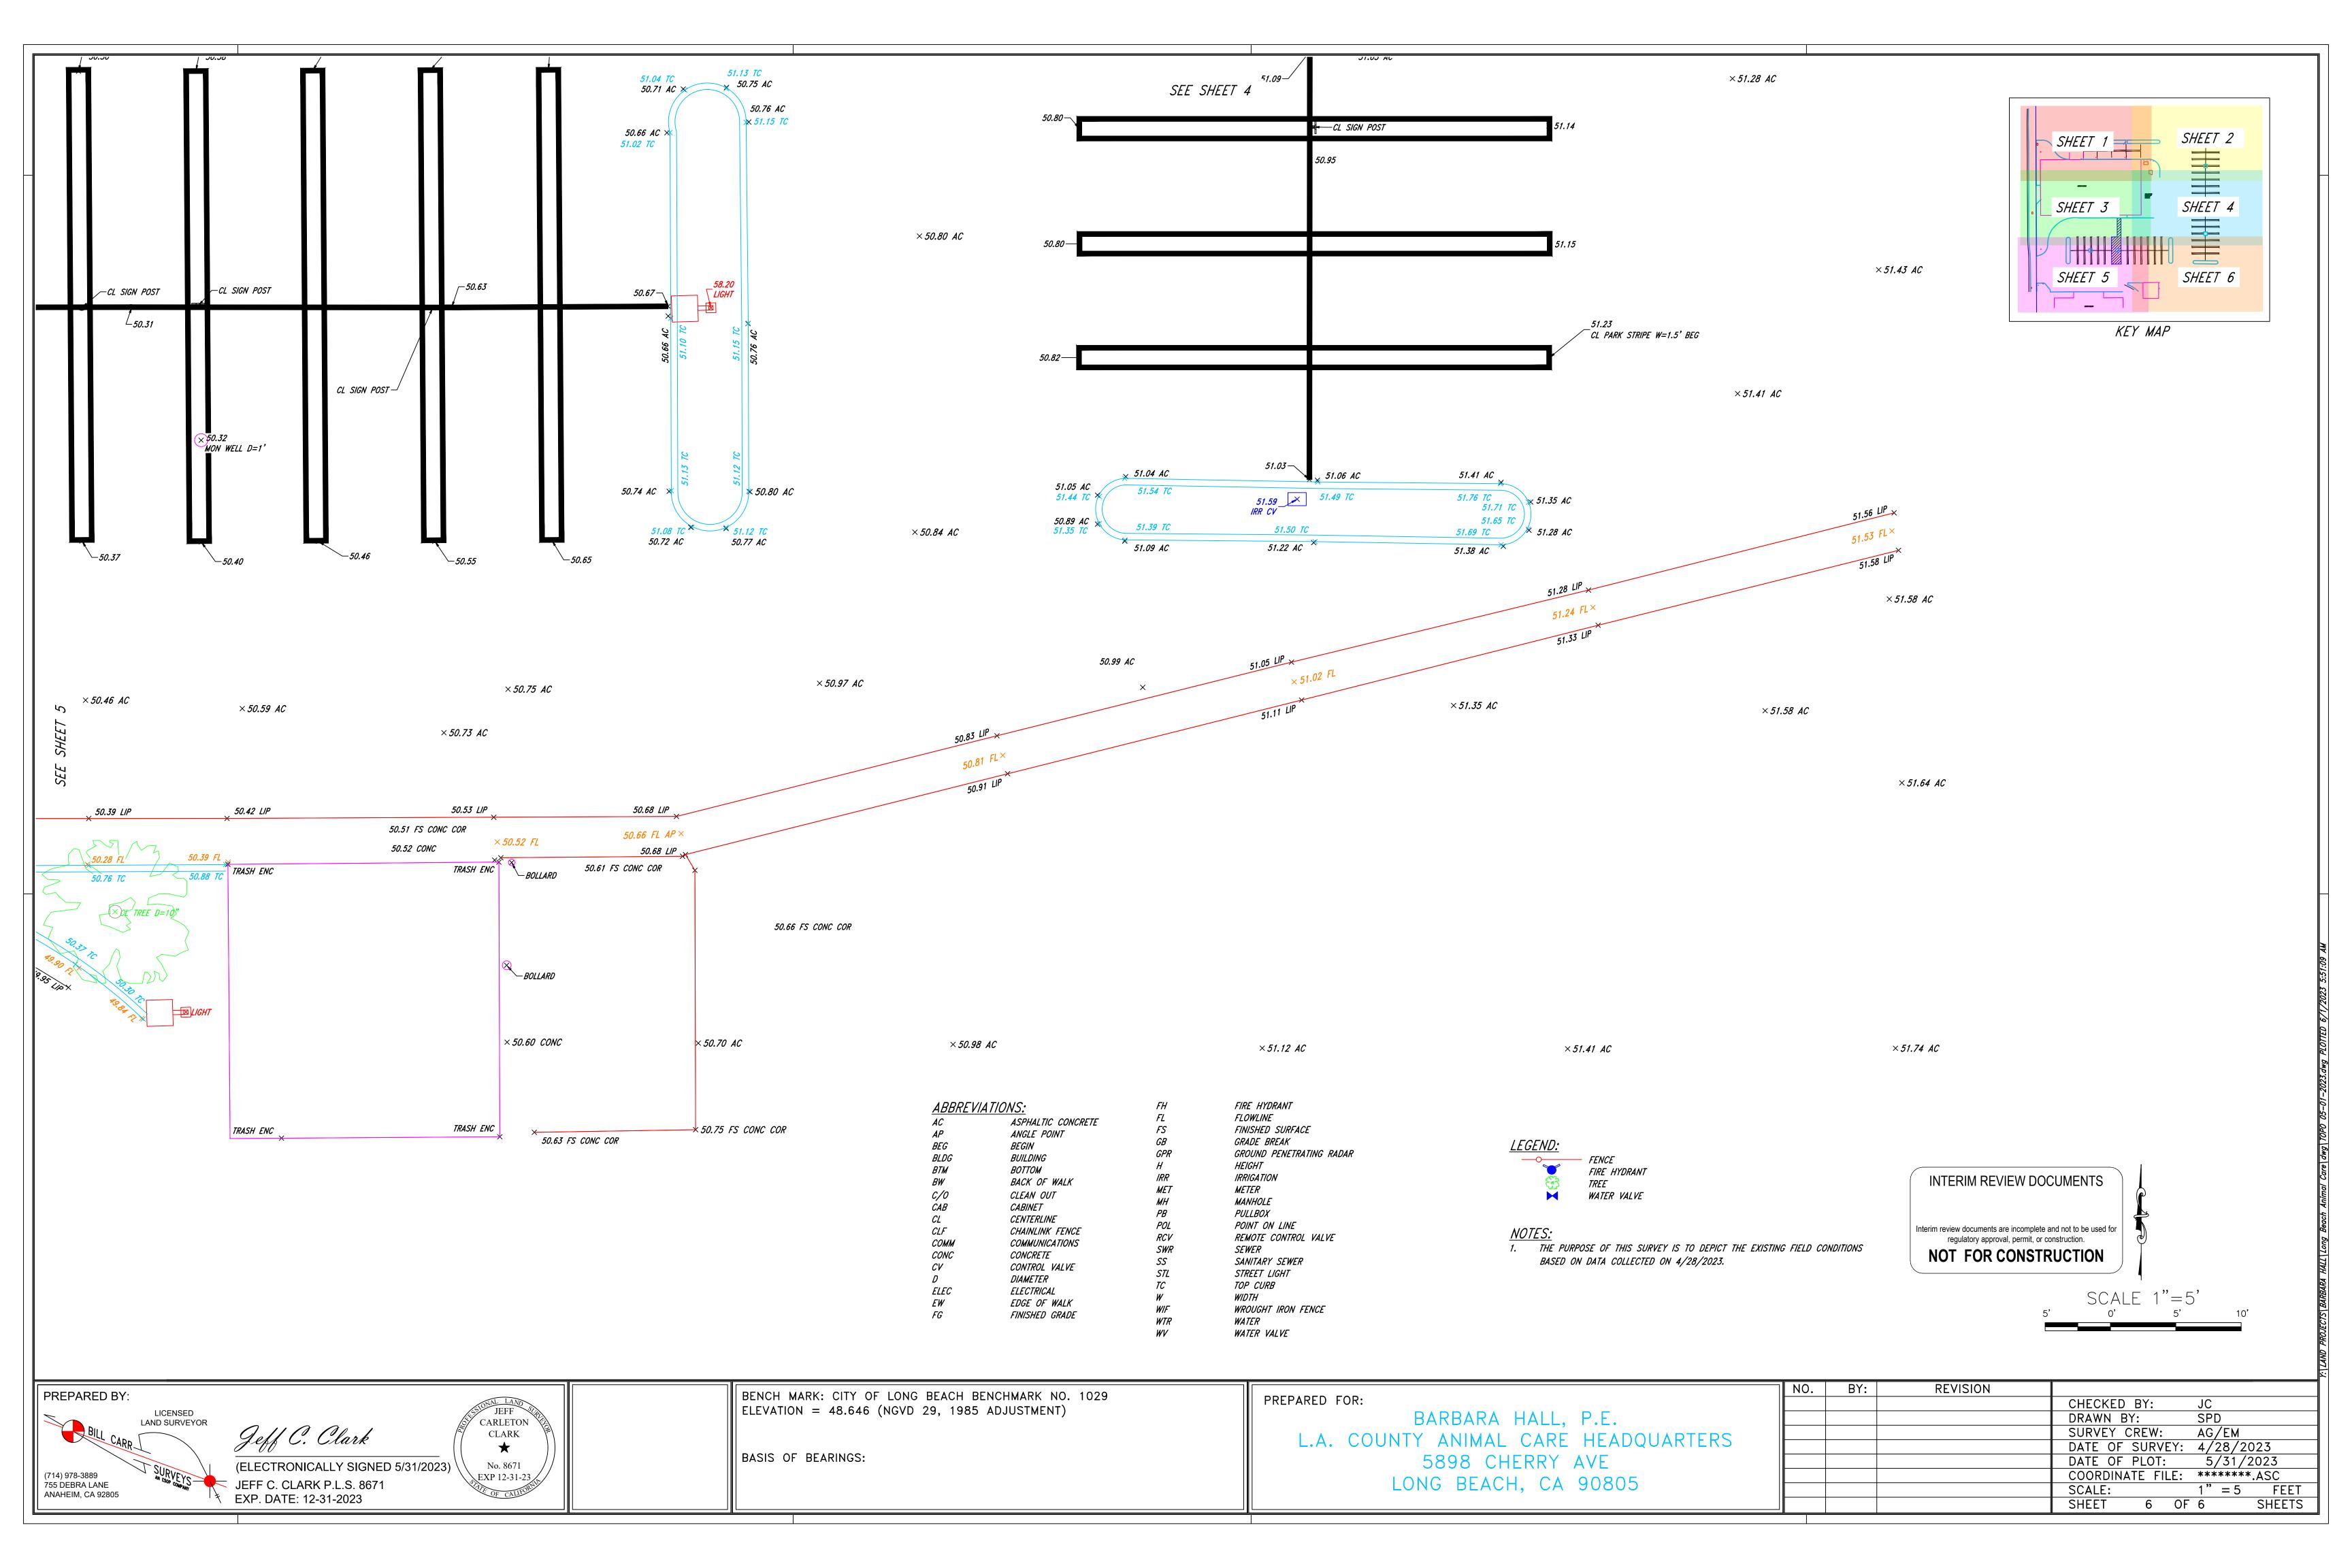

GENERAL INFORMATION GRADING PERMIT APPLICATION NO. BLDC 240131000110 EARTHWORK VOLUMES CUT <u>6</u> (CY), FILL <u>4</u> (CY) OVER EXCAVATION/ ALLUVIAL REMOVAL & COMPACTION N/A (CY) EXPORT <u>2</u> (CY), EXPORT LOCATION: TOTAL DISTURBED AREA <u>0.0166</u> (ACRES) TOTAL PROPOSED LANDSCAPE AREA ______SQUARE FEET PRE-DEVELOPMENT IMPERVIOUS AREA <u>0.0111</u> (ACRES) POST-DEVELOPMENT IMPERVIOUS AREA <u>0.0166</u> (ACRES) Waste discharge identification number (wdid #) <u>N/A</u> CONSTRUCTION & DEMOLITION DEBRIS RECYCLING AND REUSE PLAN (RPP ID) POST-CONSTRUCTION BMP FEATURE(S) GPS COORDINATES X 33.086147, Y -118.1687350 PROPERTY INFORMATION PROPERTY ADDRESSES <u>5898 CHERRY AVENUE, LONG BEACH, CA</u> TRACT/PARCEL MAP NO. 26555, MB 782-25-27 LOT/PARCEL NO. POR. LOT 1 PROPERTY OWNER LOS ANGELES COUNTY DEPT. OF ANIMAL CARE & CONTROL ASSESSORS ID NUMBER(S) 7119-018-900 ZONING, REGIONAL PLANNING, AND OTHER AGENCY INFORMATION PROPERTY ZONING: CHW INTENDED LAND USE: OFFICE CERTIFICATE OF COMPLIANCE: CC NO. <u>N/A</u> PLOT PLAN NUMBER: PP NO. <u>N/A</u> CONDITIONAL USE PERMIT: CUP NO. N/A EXPIRATION DATE: _____ OAK TREE REMOVAL PERMIT NUMBER: OTP NO. N/A EXPIRATION DATE: _____ COMMUNITY STANDARDS DISTRICT: N/A CALIFORNIA COASTAL COMMISSION AREA: _____ YES, __X NO APPROVED VOLUME: ____ (CY) EXPIRATION DATE: _____ COASTAL DEVELOPMENT PERMIT CDP <u>N/A</u>

FISH & WILDLIFE, ARMY CORP OF ENGINEERS, REGIONAL WATER CONTROL BOARD, AQMD & OTHER AGENCY PERMITS

SHOULD BE ADDED AS APPLICABLE. (PERMIT NUMBER <u>N/A</u>, EXPIRATION DATE <u>N/A</u>)

BMP TOTAL CAPACITY (CF, CFS)

DATE OF MAINTENANCE			TYPE OF LID PRO	<u>JECT</u>		GPS COO	ORDINATES	DESIGN STORM GREATER OF (CIRCLE ONE) 0.75-INCH 85TH PERCENTILE
AGREEMENT	DESIG	GNATED	NON— DESIGNATED — SMALL SCALE	NON- DESIGNATED -	LARGE SCALE			RAINFALL DEPTH = 0.875 IN
	*COMMERCIAL	*RESIDENTIAL	RESIDENTIAL AND REDEVELOPMENT FOUR UNITS OR LESS	*RESIDENTIAL AND REDEVELOPMENT FOUR UNITS OR MORE	*NON- RESIDENTIAL	LATITUDE	LONGITUDE	STORMWATER QUALITY CONTROL MEASURES (RET, BIO, VEG, T)
TOTAL PROJECT AREA (SF)	770							
% IMPERVIOUS AREA	100%							
TRIBUTARY AREA TO SITE (AC)	0.0166							
% IMPERVIOUSNESS OF TRIBUTARY AREA	100%							
*REDEVELOPEMENT-≤ 50% (CHECK)	_							
*REDEVELOPEMENT-≥ 50% (CHECK)	V							
SITE SPECIFIC SOURCE CONTROL LID TABLE 5—1	S-1, S-8					33.086147,	-118.168350	DRYWELL, RET–4
INFILTRATE/HARVEST (Y OR N)	Υ		X					
SWQDV 100% RETAINED ON—SITE (Y OR N)	N/A							
DELTA SWQDV (CF)	Υ							
*DISCHARGE TO NATURAL DRAINAGE SYSTEM (Y OR N)	N							
HYDROMODIFICATION REQUIRED (Y1) LID SECT 8.2 EXEMPTION CRIETERIA	N							
PEAKFLOW RATE (CFS)	0.0019							
REQUIRED SWQDV (CF):	13.9							

BEST MANAGEMENT PRACTICES MINIMUM REQUIREMENTS FOR CONSTRUCTION PROJECTS

- 1. ERODED SEDIMENTS AND OTHER POLLUTANTS MUST BE RETAINED ON SITE AND MAY NOT BE TRANSPORTED FROM THE SITE VIA SHEET FLOW, SWALES, AREA DRAINS, NATURAL DRAINAGE COURSE OR WIND.
- 2. STOCKPILES OF EARTH AND OTHER CONSTRUCTION—RELATED MATERIALS MUST BE PROTECTED FROM BEING TRANSPORTED FROM THE SITE BY WIND OR WATER.
- 3. FUELS. OILS. SOLVENTS AND OTHER TOXIC MATERIALS MUST BE STORED IN ACCORDANCE WITH THEIR LISTING AND ARE NOT TO CONTAMINATE THE SOIL NOR THE SURFACE WATERS. ALL APPROVED STORAGE CONTAINERS ARE TO BE PROTECTED FROM THE WEATHER. SPILLS MUST BE CLEANED UP IMMEDIATELY AND DISPOSED OF IN A PROPER MANNER. SPILLS MAY NOT BE WASHED INTO THE DRAINAGE SYSTEM.
- 4. EXCESS OR WASTER CONCRETE MAY NOT BE WASHED INTO THE PUBLIC WAY OR ANY OTHER DRAINAGE SYSTEM. PROVISIONS SHALL BE MADE TO RETAIN CONCRETE WASTES ON—SITE UNTIL THEY CAN BE DISPOSED OF AS SOLID WASTE.
- 5. TRASH AND CONSTRUCTION—RELATED SOIL WASTES MUST BE DEPOSITED INTO A COVERED RECEPTACLE TO PREVENT CONTAMINATION OF RAINWATER AND DISPERSAL BY WIND.
- 6. SEDIMENTS AND OTHER MATERIALS MAY NOT BE TRACKED FROM THE SITE BY VEHICLE TRAFFIC. THE CONSTRUCTION ENTRANCE ROADWAYS MUST BE STABILIZED TO INHIBIT SEDIMENTS FROM BEING DEPOSITED INTO THE PUBLIC WAYS. ACCIDENTAL DEPOSITIONS MUST BE SWEPT UP IMMEDIATELY AND MAY NOT BE WASHED DOWN BY RAIN OR BY ANY OTHER MEANS.
- 7. DEWATERING OPERATIONS: REMOVE SEDIMENTS FROM GROUND WATER.
- 8. PAVING OPERATIONS: REDUCE DISCHARGE OF POLLUTANTS FROM PAVING OPERATIONS.
- 9. STRUCTURE CONSTRUCTION AND PAINTING: PREVENT AND REDUCE DISCHARGE FROM CONSTRUCTION SITES AND PAINTING PROJECTS.
- 10. MATERIAL DELIVERY AND STORAGE: PREVENT AND REDUCE DISCHARGE OF POLLUTANTS TO STORM WATER FROM MATERIAL USE.
- 11. MATERIAL USE: PREVENT AND REDUCE DISCHARGE OF POLLUTANTS TO STORM WATER FROM MATERIAL USE.
- 12. SPILL PREVENTION AND CONTROL: PREVENT AND REDUCE DISCHARGE OF POLLUTANTS TO STORM WATER SYSTEMS WITH GOOD HOUSEKEEPING.
- 13. SOLID WASTE MANAGEMENT: PREVENT REDUCE DISCHARGE OF POLLUTANTS TO STORM WATER SYSTEMS FROM SOLID WASTE OR CONSTRUCTION.
- 14. HAZARDOUS WASTE MANAGEMENT: PREVENT AND REDUCE DISCHARGE OF POLLUTANTS TO STORM WATER FROM TOXIC MATERIALS.
- 15. CONTAMINATED SOIL MANAGEMENT: PREVENT AND REDUCE DISCHARGE OF POLLUTANTS TO STORM WATER FROM CONTAMINATED SOIL.
- 16. CONCRETE WASTE MANAGEMENT: PREVENT AND REDUCE DISCHARGE OF POLLUTANTS TO STORM WATER FROM CONCRETE WASTE.
- 17. SANITARY/SEPTIC WASTE MANAGEMENT: PREVENT AND REDUCE DISCHARGE OF POLLUTANTS TO STORM WATER FROM SANITARY AND SEPTIC SYSTEMS.
- 18. VEHICLE AND EQUIPMENT CLEANING: PREVENT AND REDUCE DISCHARGE OF POLLUTANTS TO STORM WATER FROM CLEANING OF VEHICLES AND EQUIPMENT.
- 19. VEHICLE AND EQUIPMENT FUELING: PREVENT AND REDUCE DISCHARGE OF POLLUTANTS TO STORM WATER
- FROM FUELING OF VEHICLES AND EQUIPMENT.
- 20. VEHICLE AND EQUIPMENT MAINTENANCE: PREVENT AND REDUCE DISCHARGE OF POLLUTANTS TO STORM WATER FROM MAINTENANCE OF VEHICLES AND EQUIPMENT.
- 21. EMPLOYEE/SUBCONTRACTOR TRAINING: SWPPP STORM WATER POLLUTION PREVENTION PLAN.
- 22. SCHEDULING: SEQUENCING THE CONSTRUCTION PROJECT TO REDUCE THE AMOUNT OF SOIL EXPOSED TO
- 23. PRESERVATION OF EXISTING VEGETATION: MINIMIZE DAMAGE AND EROSION BY PRESERVING THE EXISTING
- 24. SEEDING AND PLANTING: MINIMIZE EROSION WITH SEEDING AND PLANTING.
- 25. MULCHING: FOR STABILIZING CLEARED AND FRESHLY SEEDED AREAS.
- 26. GEOTEXTILES AND MATS: FOR STABILIZATION OF SOILS.
- 27. DUST CONTROLS: REDUCE DUST AND SOIL EROSION.
- 28. TEMPORARY STREAM CROSSING: RECOMMENDATIONS FOR INSTALLING A TEMPORARY CULVERT, FORD OR
- 29. CONSTRUCTION ROAD STABILIZATION: RECOMMENDATIONS FOR DUST EROSION CONTROL.
- 30. STABILIZED CONSTRUCTION ENTRANCE: RECOMMENDATIONS FOR DUST, SEDIMENT AND EROSION CONTROL FOR PUBLIC STREETS.
- 31. EARTH DIKE: TEMPORARY BERM OR RIDGE OF COMPACTED SOIL.
- 32. TEMPORARY DRAINS AND SWALES: TO DIVERT OFF—SITE RUNOFF AROUND A CONSTRUCTION SITE.
- 33. SLOPE DRAIN: TEMPORARY PIPE TO DIVERT RUNOFF FROM THE TOP OF A SLOPE TO THE BOTTOM WITHOUT CAUSING EROSION.
- 34. OUTLET PROTECTION: INSTALL RIP-RAP TO REDUCE SEDIMENT IN THE SOIL.
- 35. CHECK DAMS: REDUCES VELOCITY OF CONCENTRATED STORM WATER FLOWS AND REDUCES EROSION.
- 36. SLOPE ROUGHENING/TERRACING: CREATES MICROCLIMATES FOR ESTABLISHING VEGETATION.
- 37. SILT FENCE: FOR SEDIMENTATION CONTROL.
- 38. STRAW BALE BARRIERS: FOR SEDIMENTATION CONTROL.
- 39. SAND BAG BARRIER: FOR SEDIMENTATION CONTROL.
- 40. BRUSH OR ROCK FILTER: FOR SEDIMENTATION CONTROL AND VELOCITY REDUCTION.
- 41. STORM DRAIN INLET PROTECTION: DEVICES WHICH DETAIN SEDIMENT LADEN RUNOFF.
- 42. SEDIMENT TRAP: SMALL EXCAVATED OR BERMED AREA FOR SEDIMENTATION.
- 43. SEDIMENT BASIN: POND CREATED TO ALLOW EXCESSIVE SEDIMENT TO SETTLE.
- I AM AWARE OF THE ABOVE REQUIREMENTS AND WILL IMPLEMENT AND MAINTAIN THE REQUIREMENTS.

(OWNER OR AGENT'S SIGNATURE) (DATE) HUNGERFORD ST **LOCATION** SOUTH ST PHILLIPS ST CHERRY INDUSTRIAL

SCALE: 1"=400'

CIVIL ENGINEER

BARBARA L. HALL P.E., INC. 318 W. EVERGREEN AVENUE MONROVIA, CA 91016 TEL.: (626) 256-3220

GEOTECHNICAL ENGINEER:

WSP USA ENVIRONMENTAL & INFRASTRUCTURE 6001 RICKENBACKER ROAD LOS ANGELES, CALIFORNIA TEL.: (323) 889–5300 PROJECT NO.: 4953-23-0012 DATED: 05/02/2023

SURVEY ENGINEER:

BILL CARR 755 DEBRA LANE ANAHEIM, CA 92805 TEL.: (714) 978-3889 DATE OF FIELD SURVEY: 04/28/2023

SHEET INDEX

C4.03

CITY OF LONG BEACH

BENCHMARK NO. 1029

NGVD 29 1985 ADJ.

Know what's below.

Call before you dig.

BRASS DISC FLUSH W/ PVMT; STAMPED "CLB BM 1029

RE 3111 1969" 1.1' W / CURB; 11.1' N / CURB

EL. 48.646 FT

GENERAL NOTES DEMOLITION PLAN PAVEMENT PLAN C1.04 STRIPING PLAN GRADING PLAN DETAILS C4.01 DETAILS

DETAILS

La Cañada Design Group Architecture Planning Interiors 630 N. Rosemead Boulevard, Suite 400

Pasadena, California 91107 (626) 351-4301 FAX (626)351-4302 www.lcdg.com

Registration

Client Name COUNTY OF LOS ANGELES PUBLIC WORKS

Project Title DEPARTMENT OF ANIMAL CARE AND CONTROL **HEADQUARTERS**

FENCING PROJECT **Project Address** 5898 Cherry Ave Long Beach, CA 90805 SPEC #: 7856

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authorization of La Cañada Design Group. Milestones CD 50% 9/25/23 CD 90% 1/9/24 BACK CHECK 1 7/2/24

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LCDG Job Number:

Sheet Title


GENERAL NOTES


BUILDING DRAINAGE PLAN APPROVED jzhang 09/03/2024 10:43:49 AM BUILDING AND SAFETY DIVISION
LA COUNTY DEPARTMENT OF PUBLIC WORKS

Barbara L. Hall, P.E., Inc.

318 West Evergreen Avenue Monrovia, CA 91016 Phone: (626) 256-3220 Fax: (626) 256-3218

Sheet Number C1.01

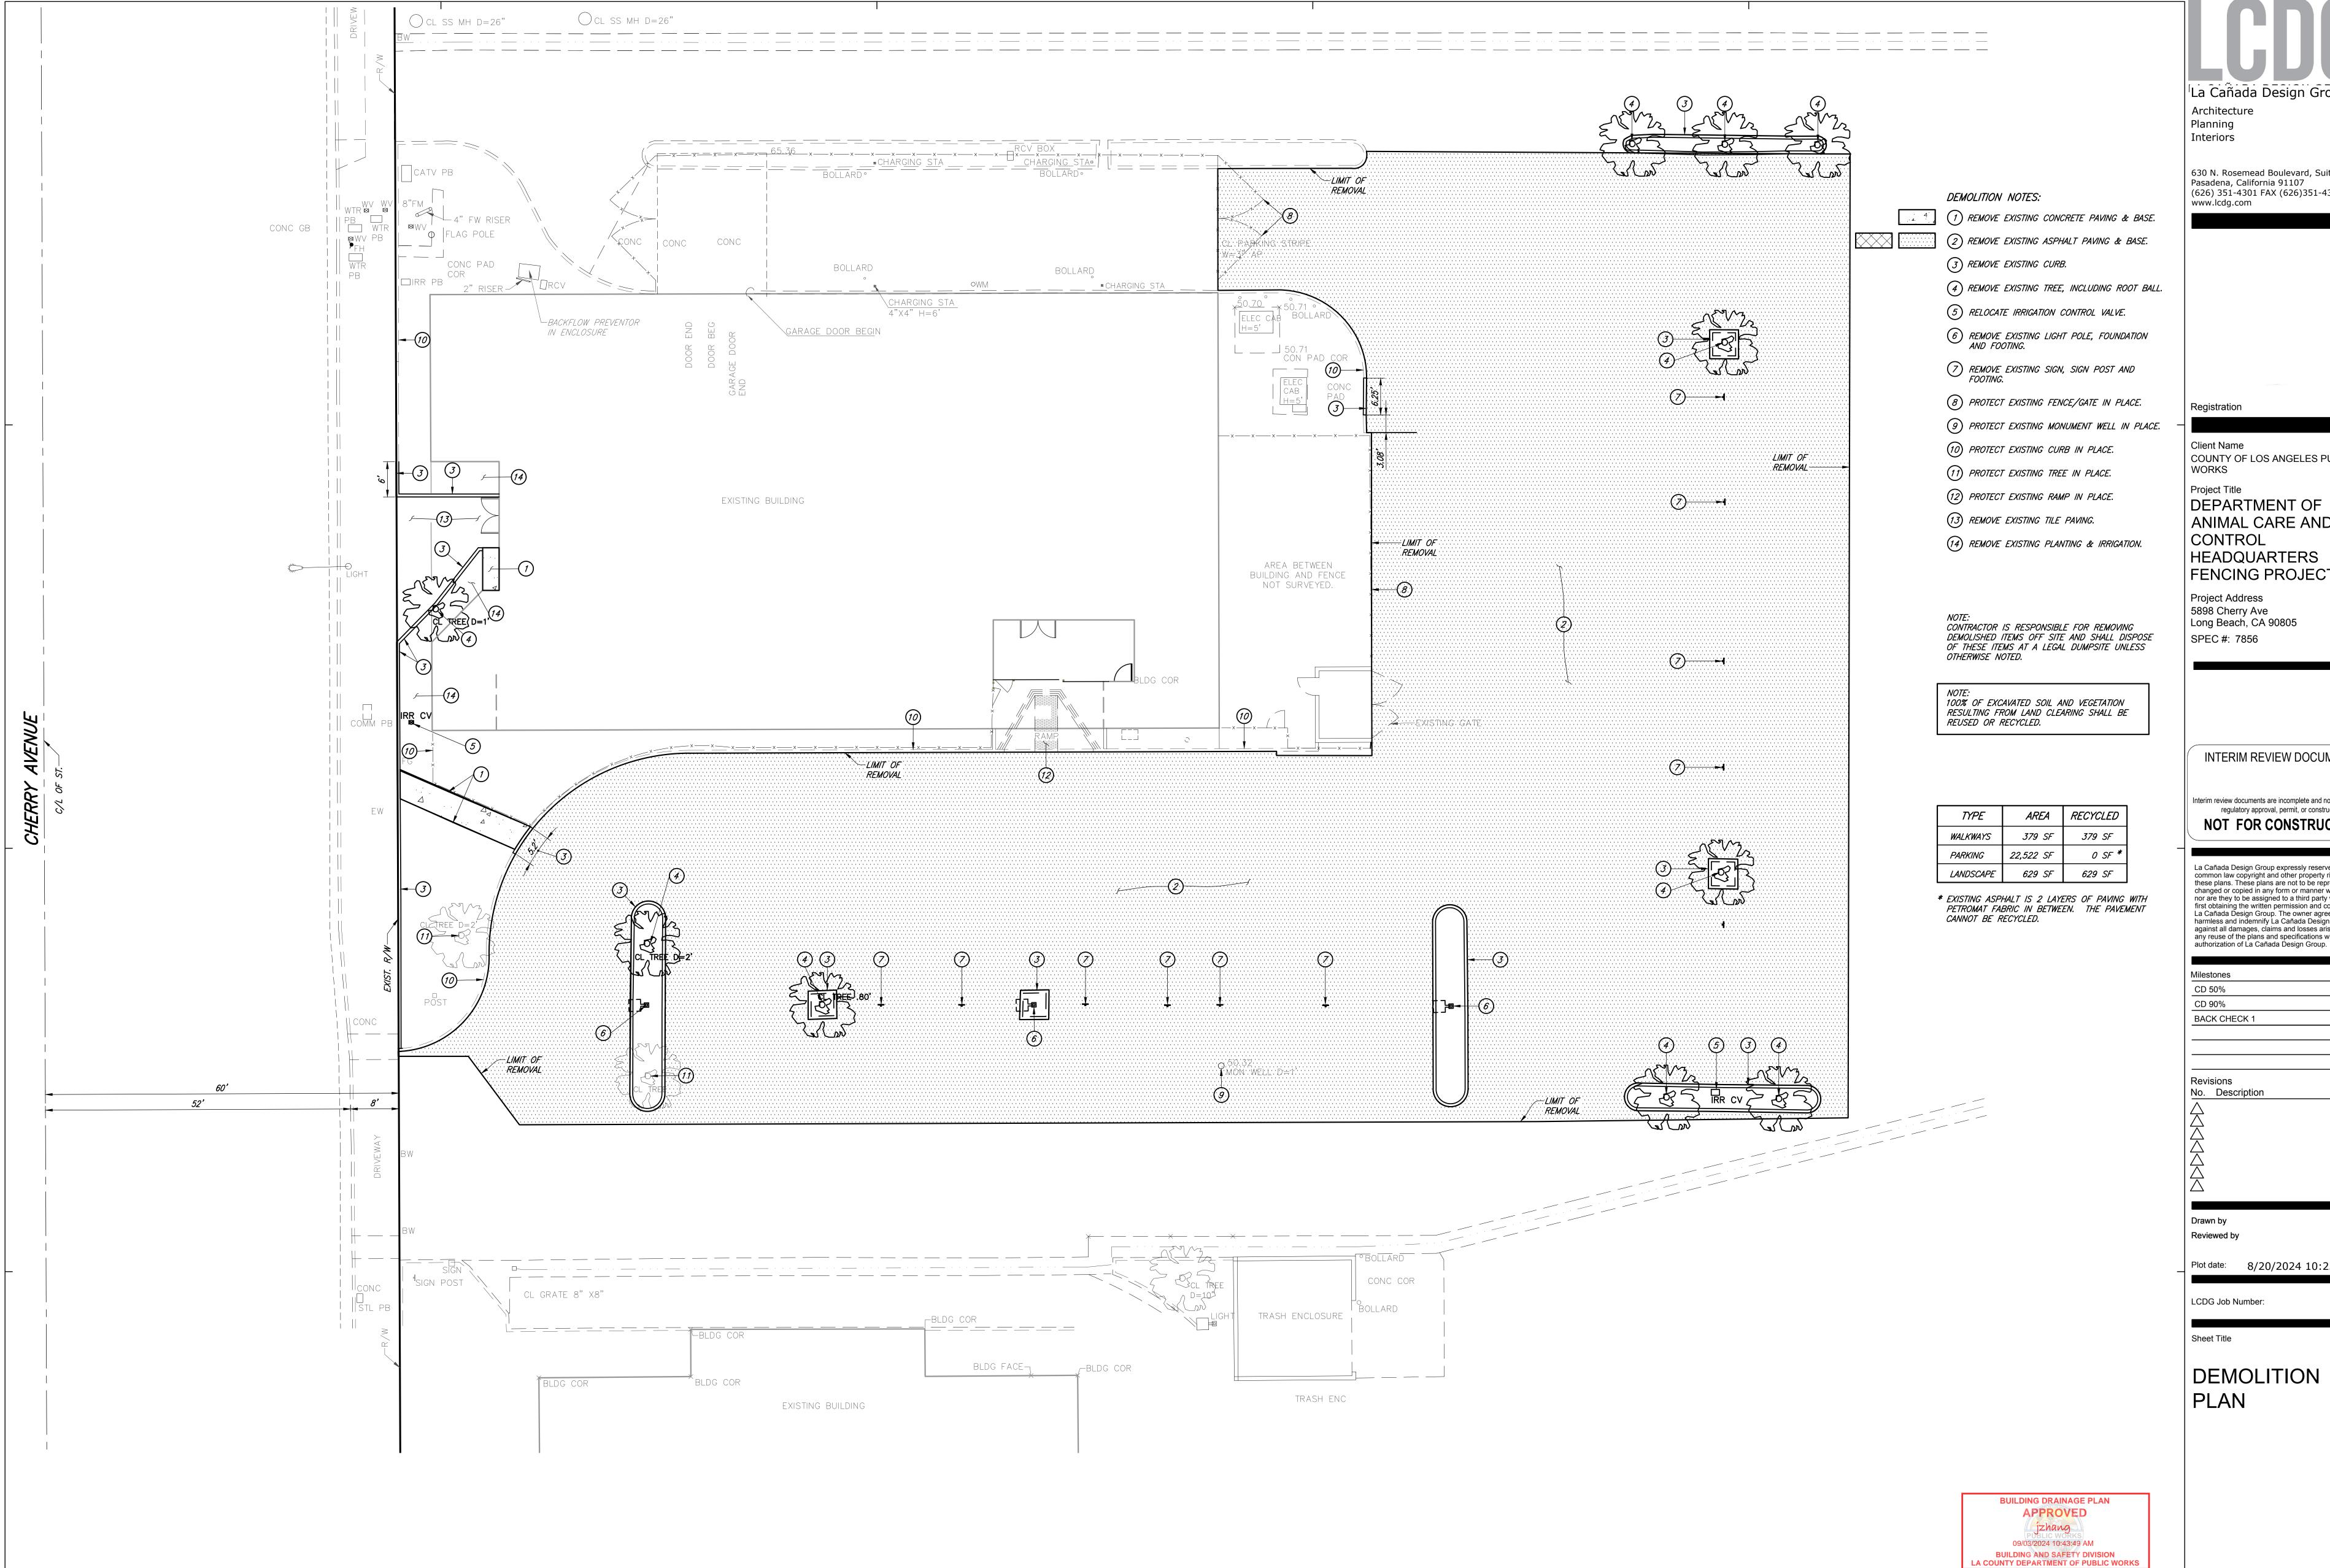

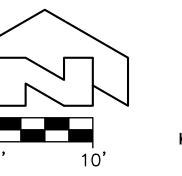



CITY OF LONG BEACH EL. 48.646 FT BENCHMARK NO. 1029 BRASS DISC FLUSH W/ PVMT; STAMPED "CLB BM 1029 RE 3111 1969" 1.1' W / CURB; 11.1' N / CURB NGVD 29 1985 ADJ.

Barbara L. Hall, P.E., Inc. 318 West Evergreen Avenue Monrovia, CA 91016 Phone: (626) 256-3220

Fax: (626) 256-3218

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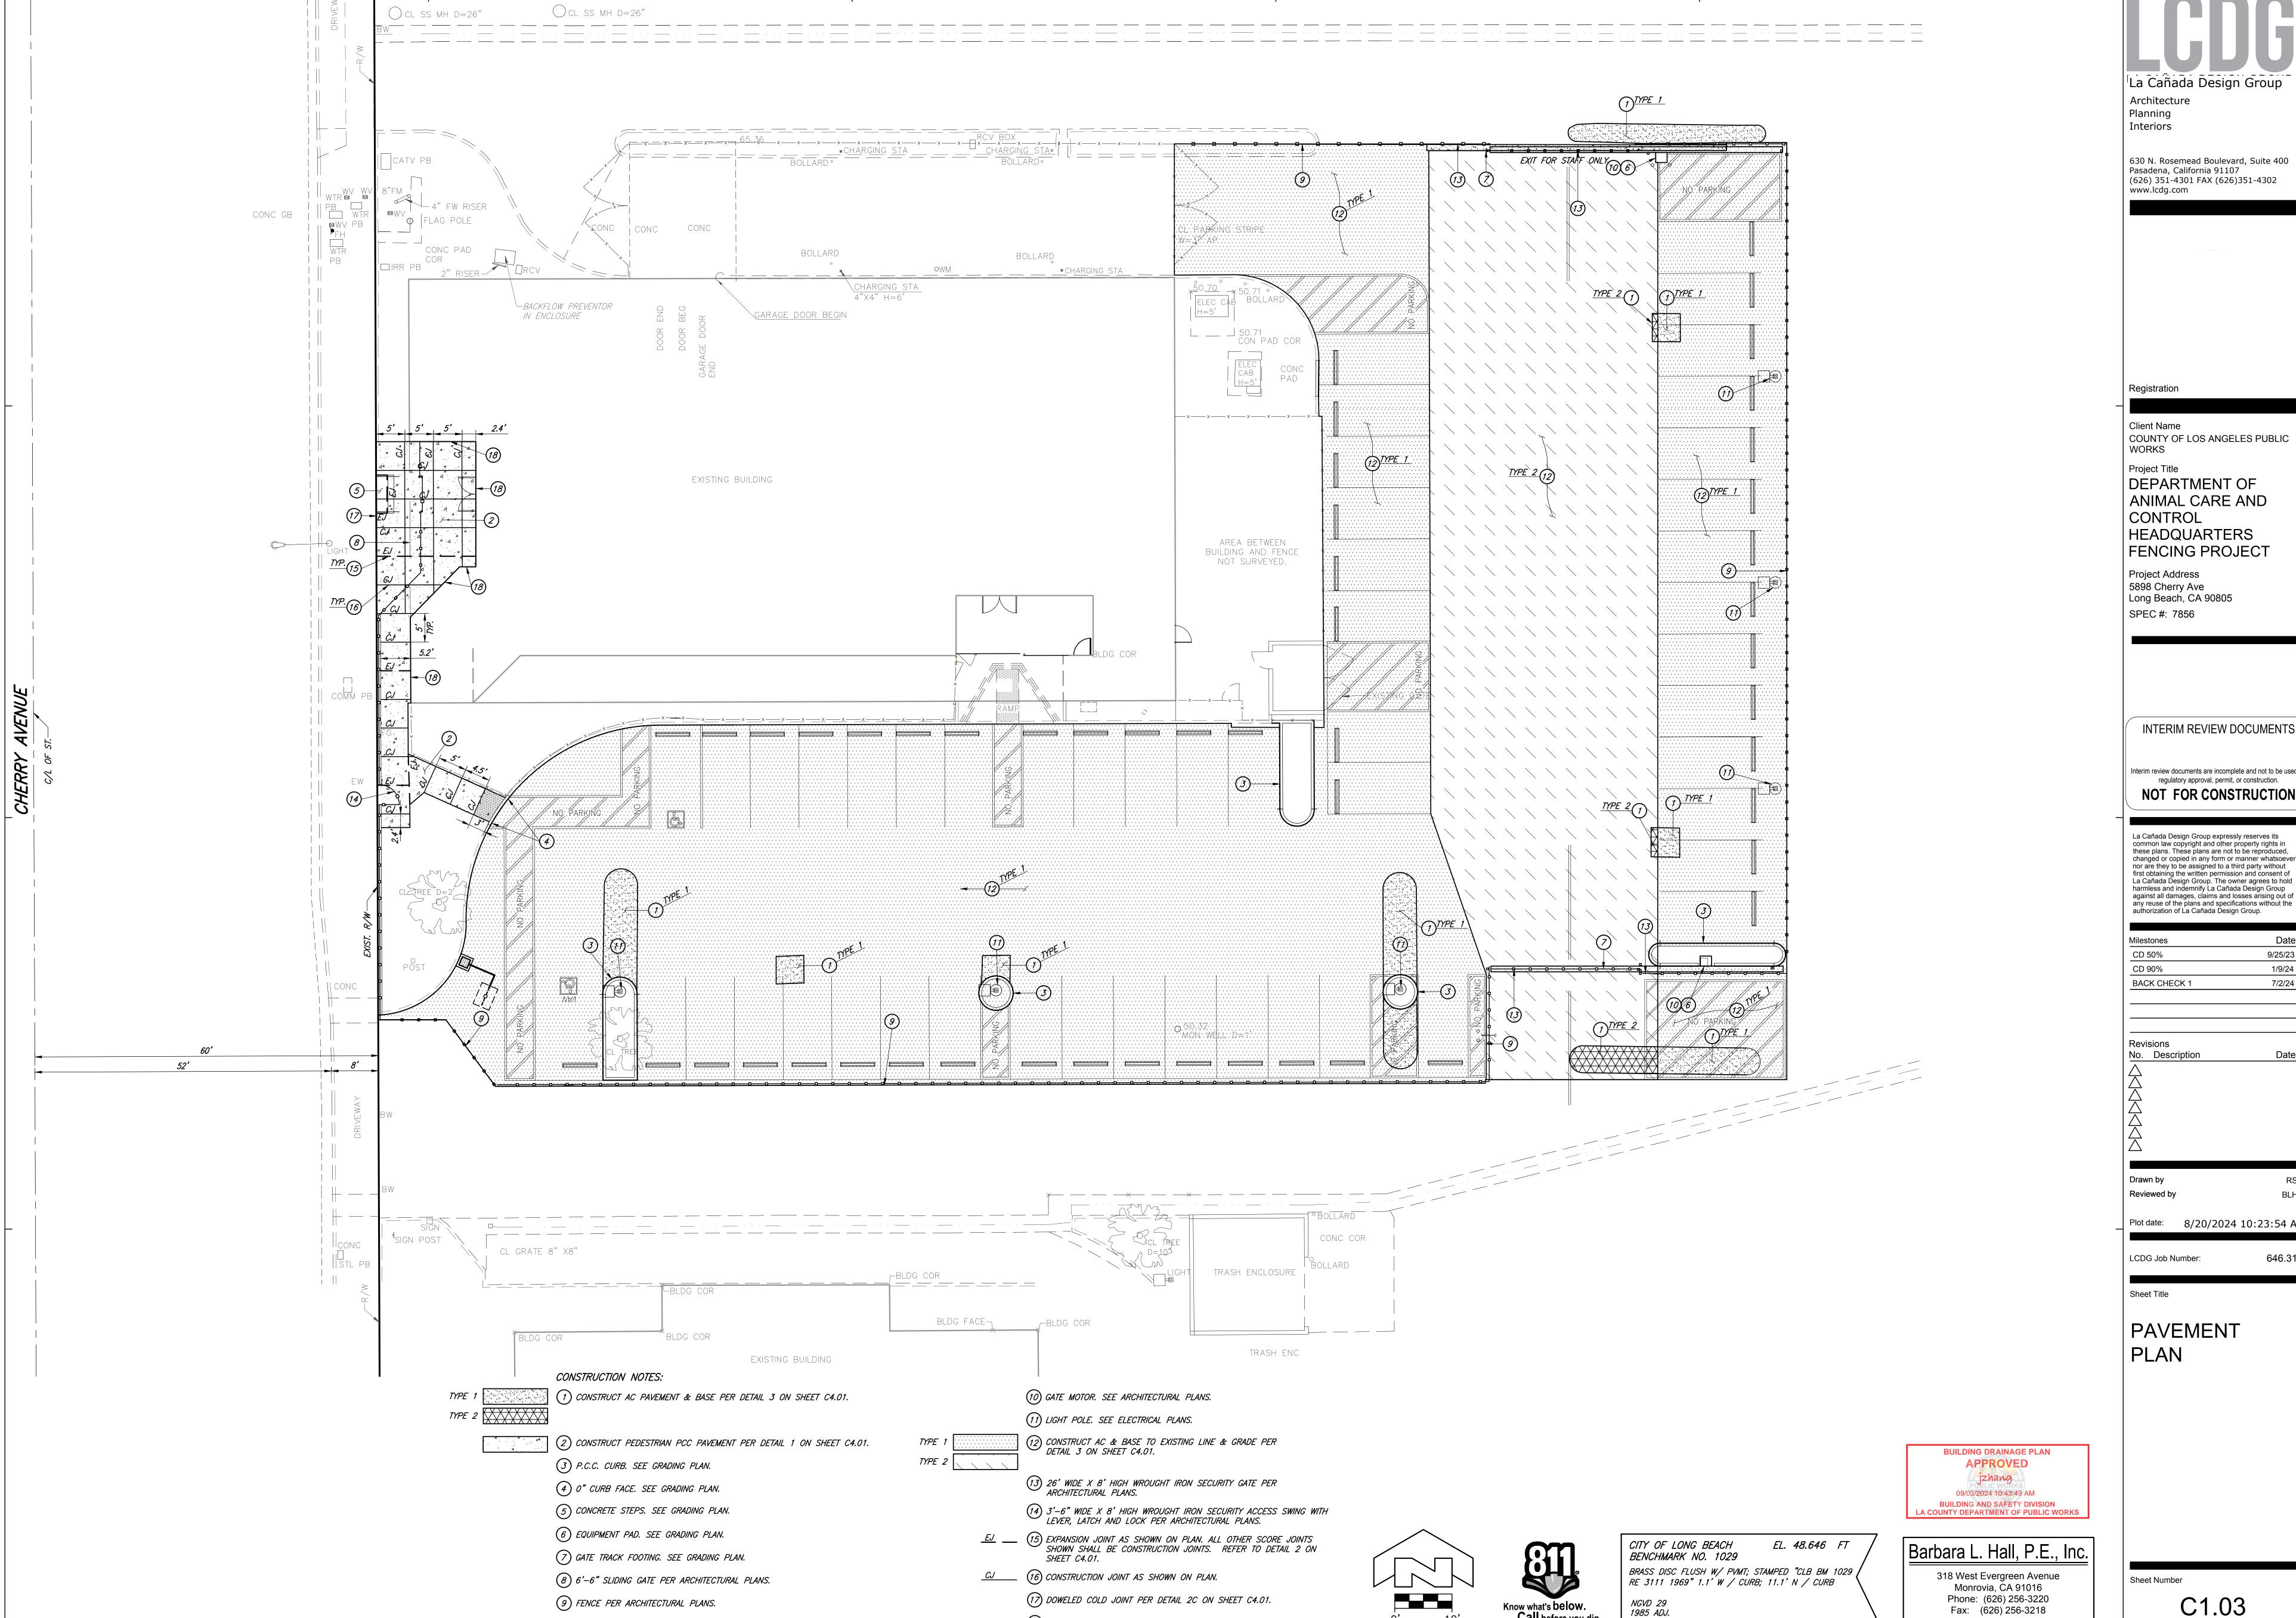
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DEMOLITION PLAN

Sheet Number

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C1.02



(18) CONCRETE PAVEMENT AT BUILDING PER DETAIL 2 ON SHEET C4.01.

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COUNTY OF LOS ANGELES PUBLIC

DEPARTMENT OF ANIMAL CARE AND HEADQUARTERS

Long Beach, CA 90805

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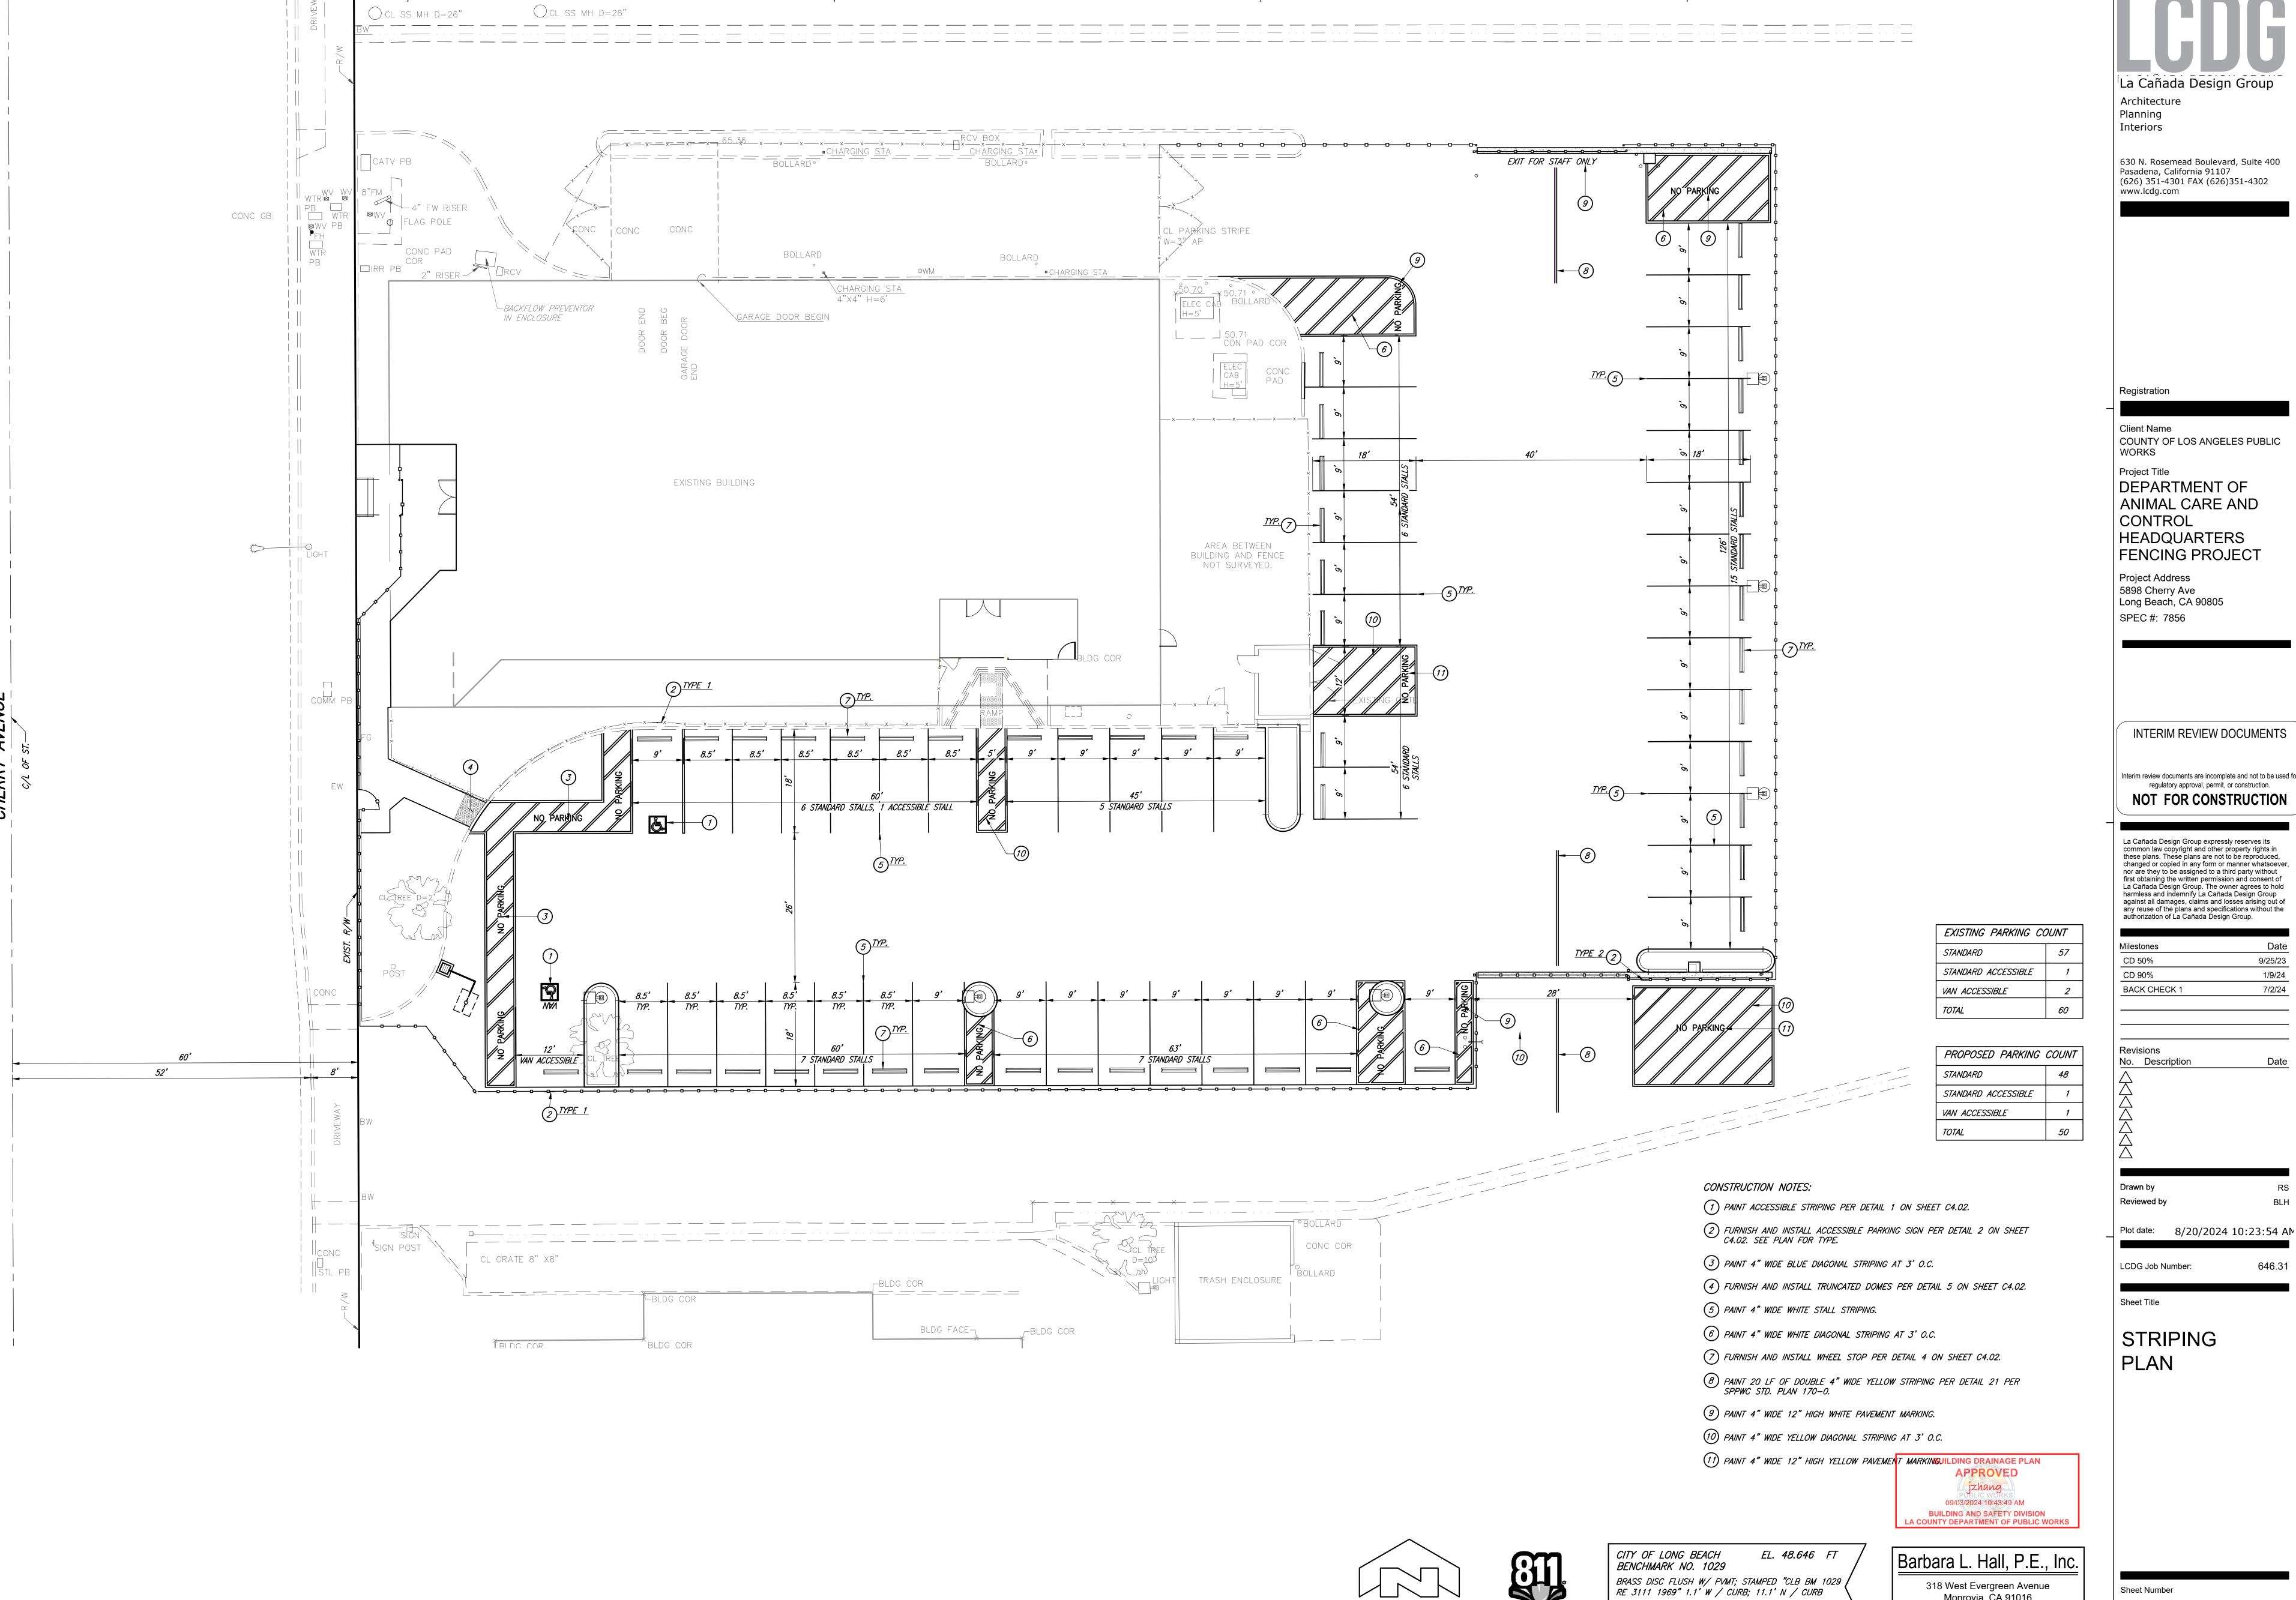
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C1.03

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ilestones	Date
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CD 90%	1/9/24
BACK CHECK 1	7/2/24

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LCDG Job Number:

STRIPING PLAN

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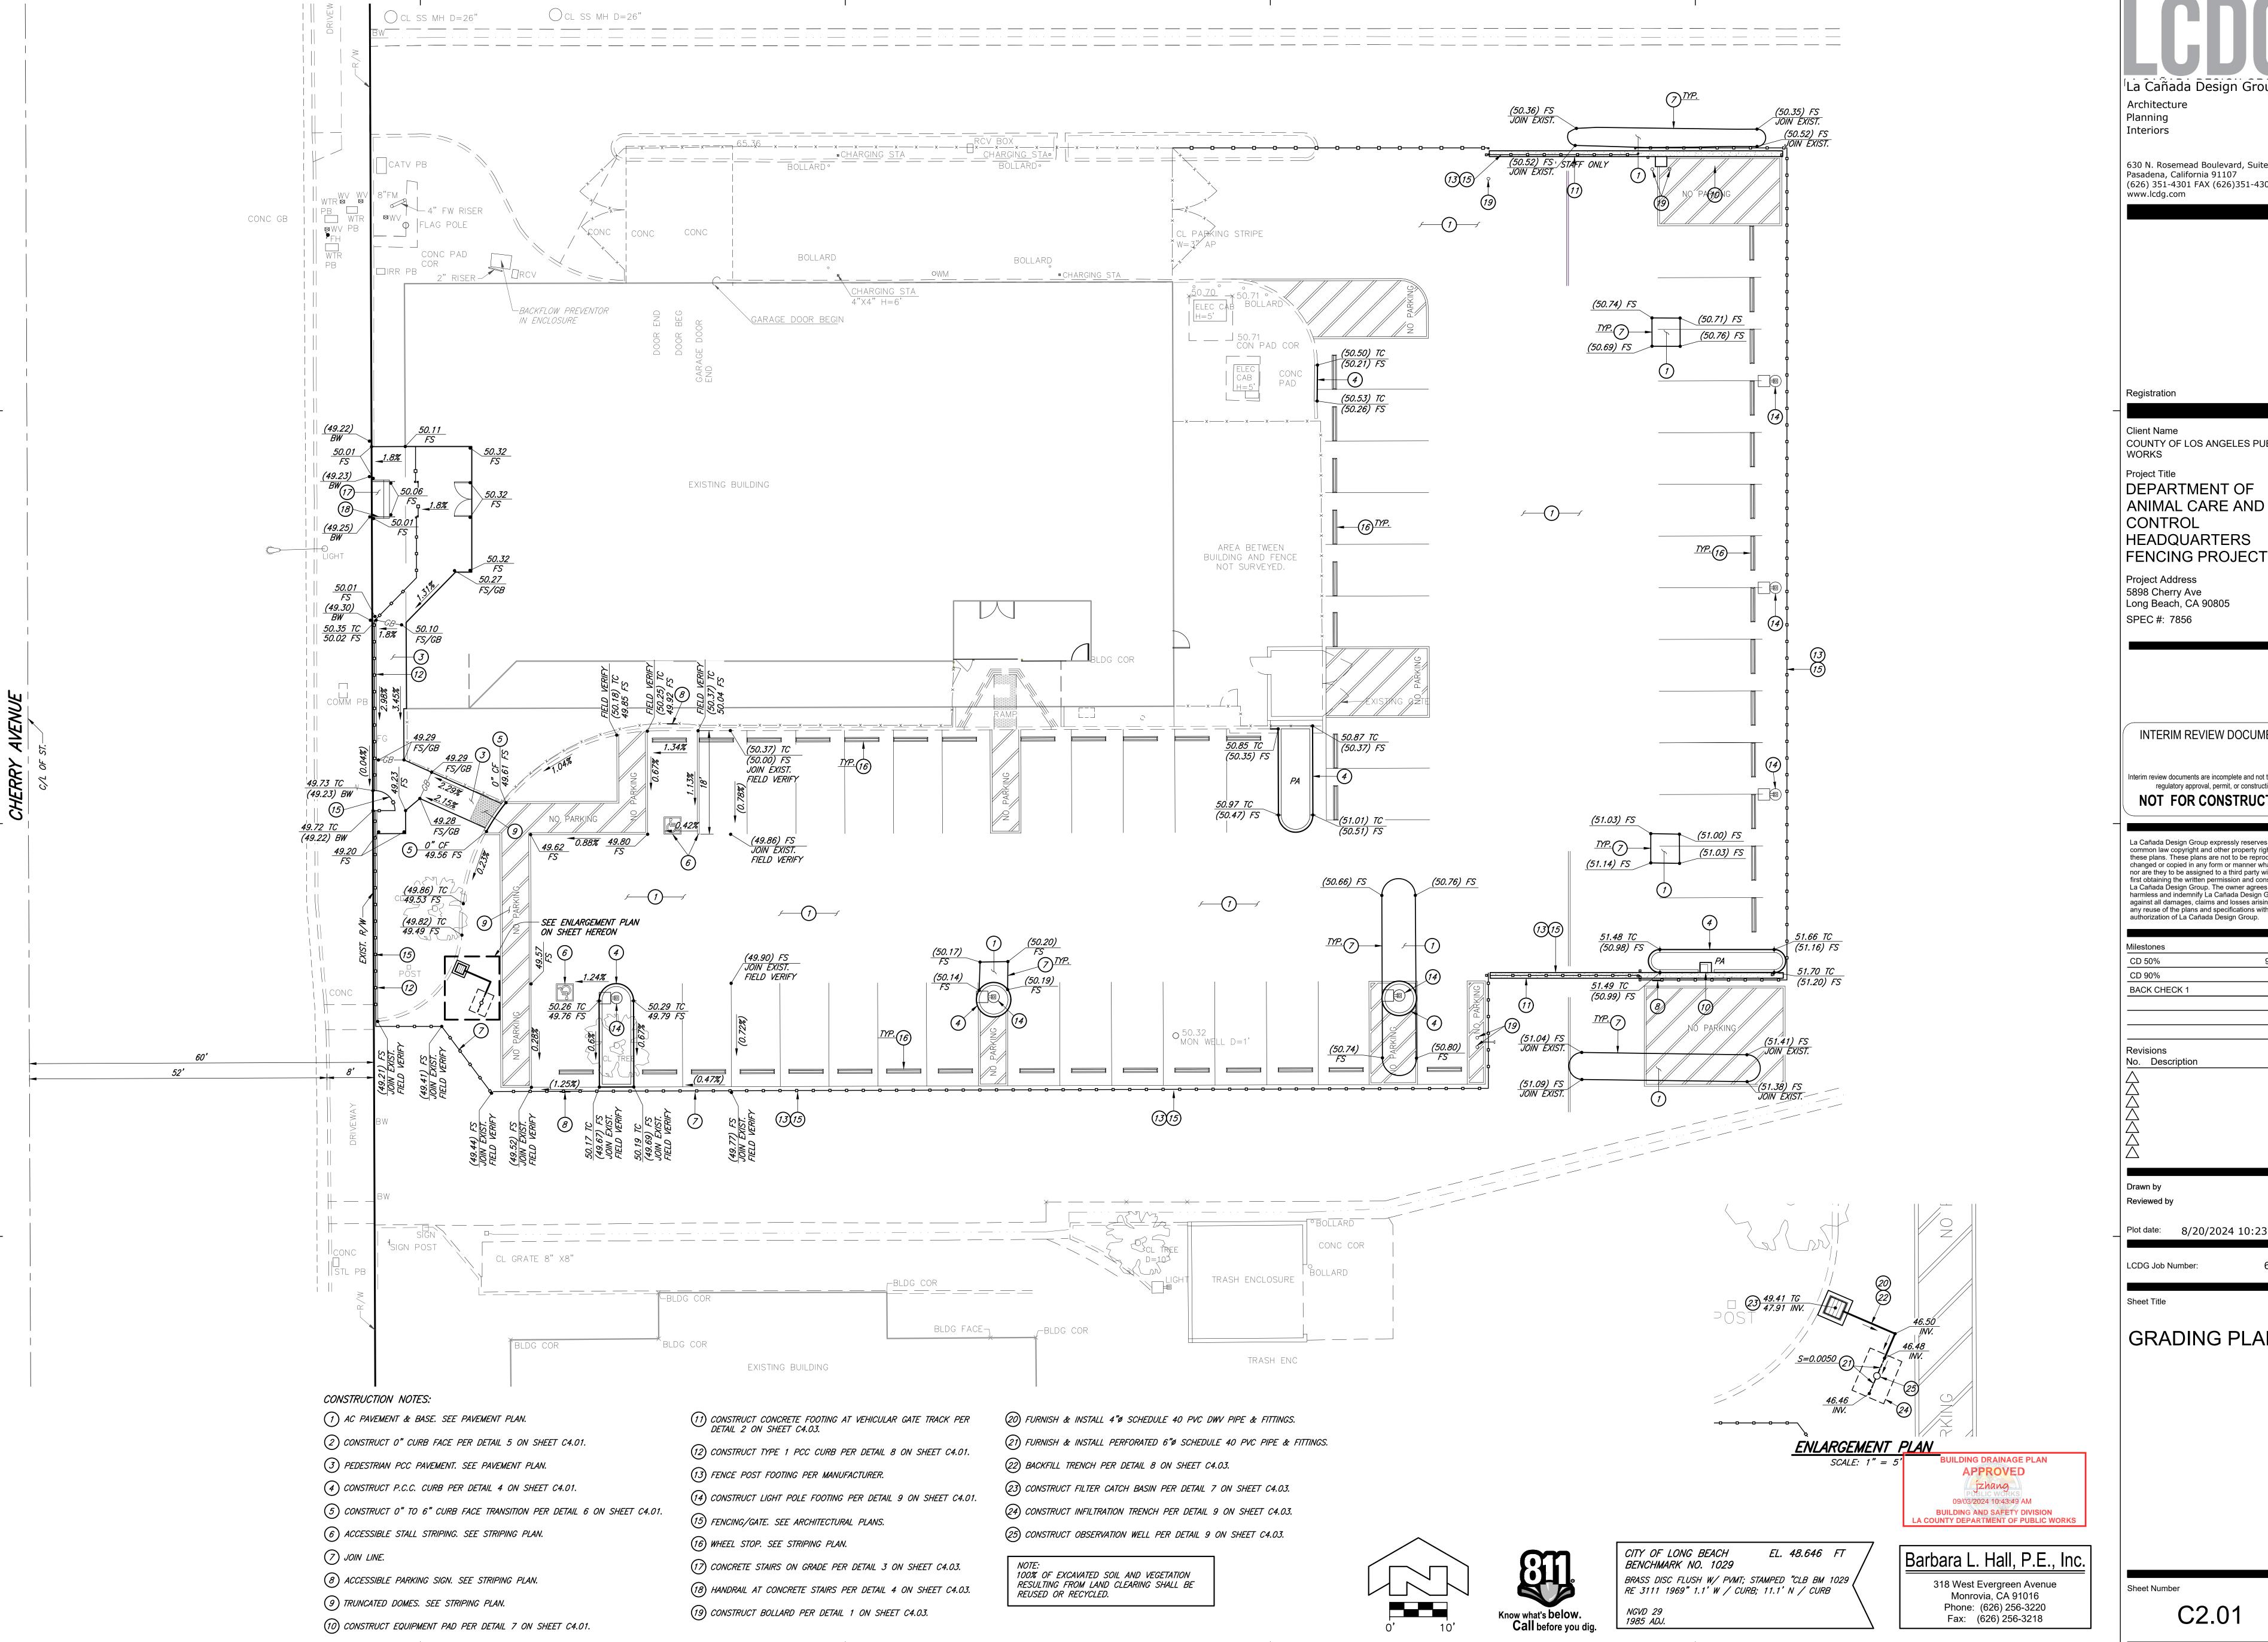
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Sheet Number

C1.04



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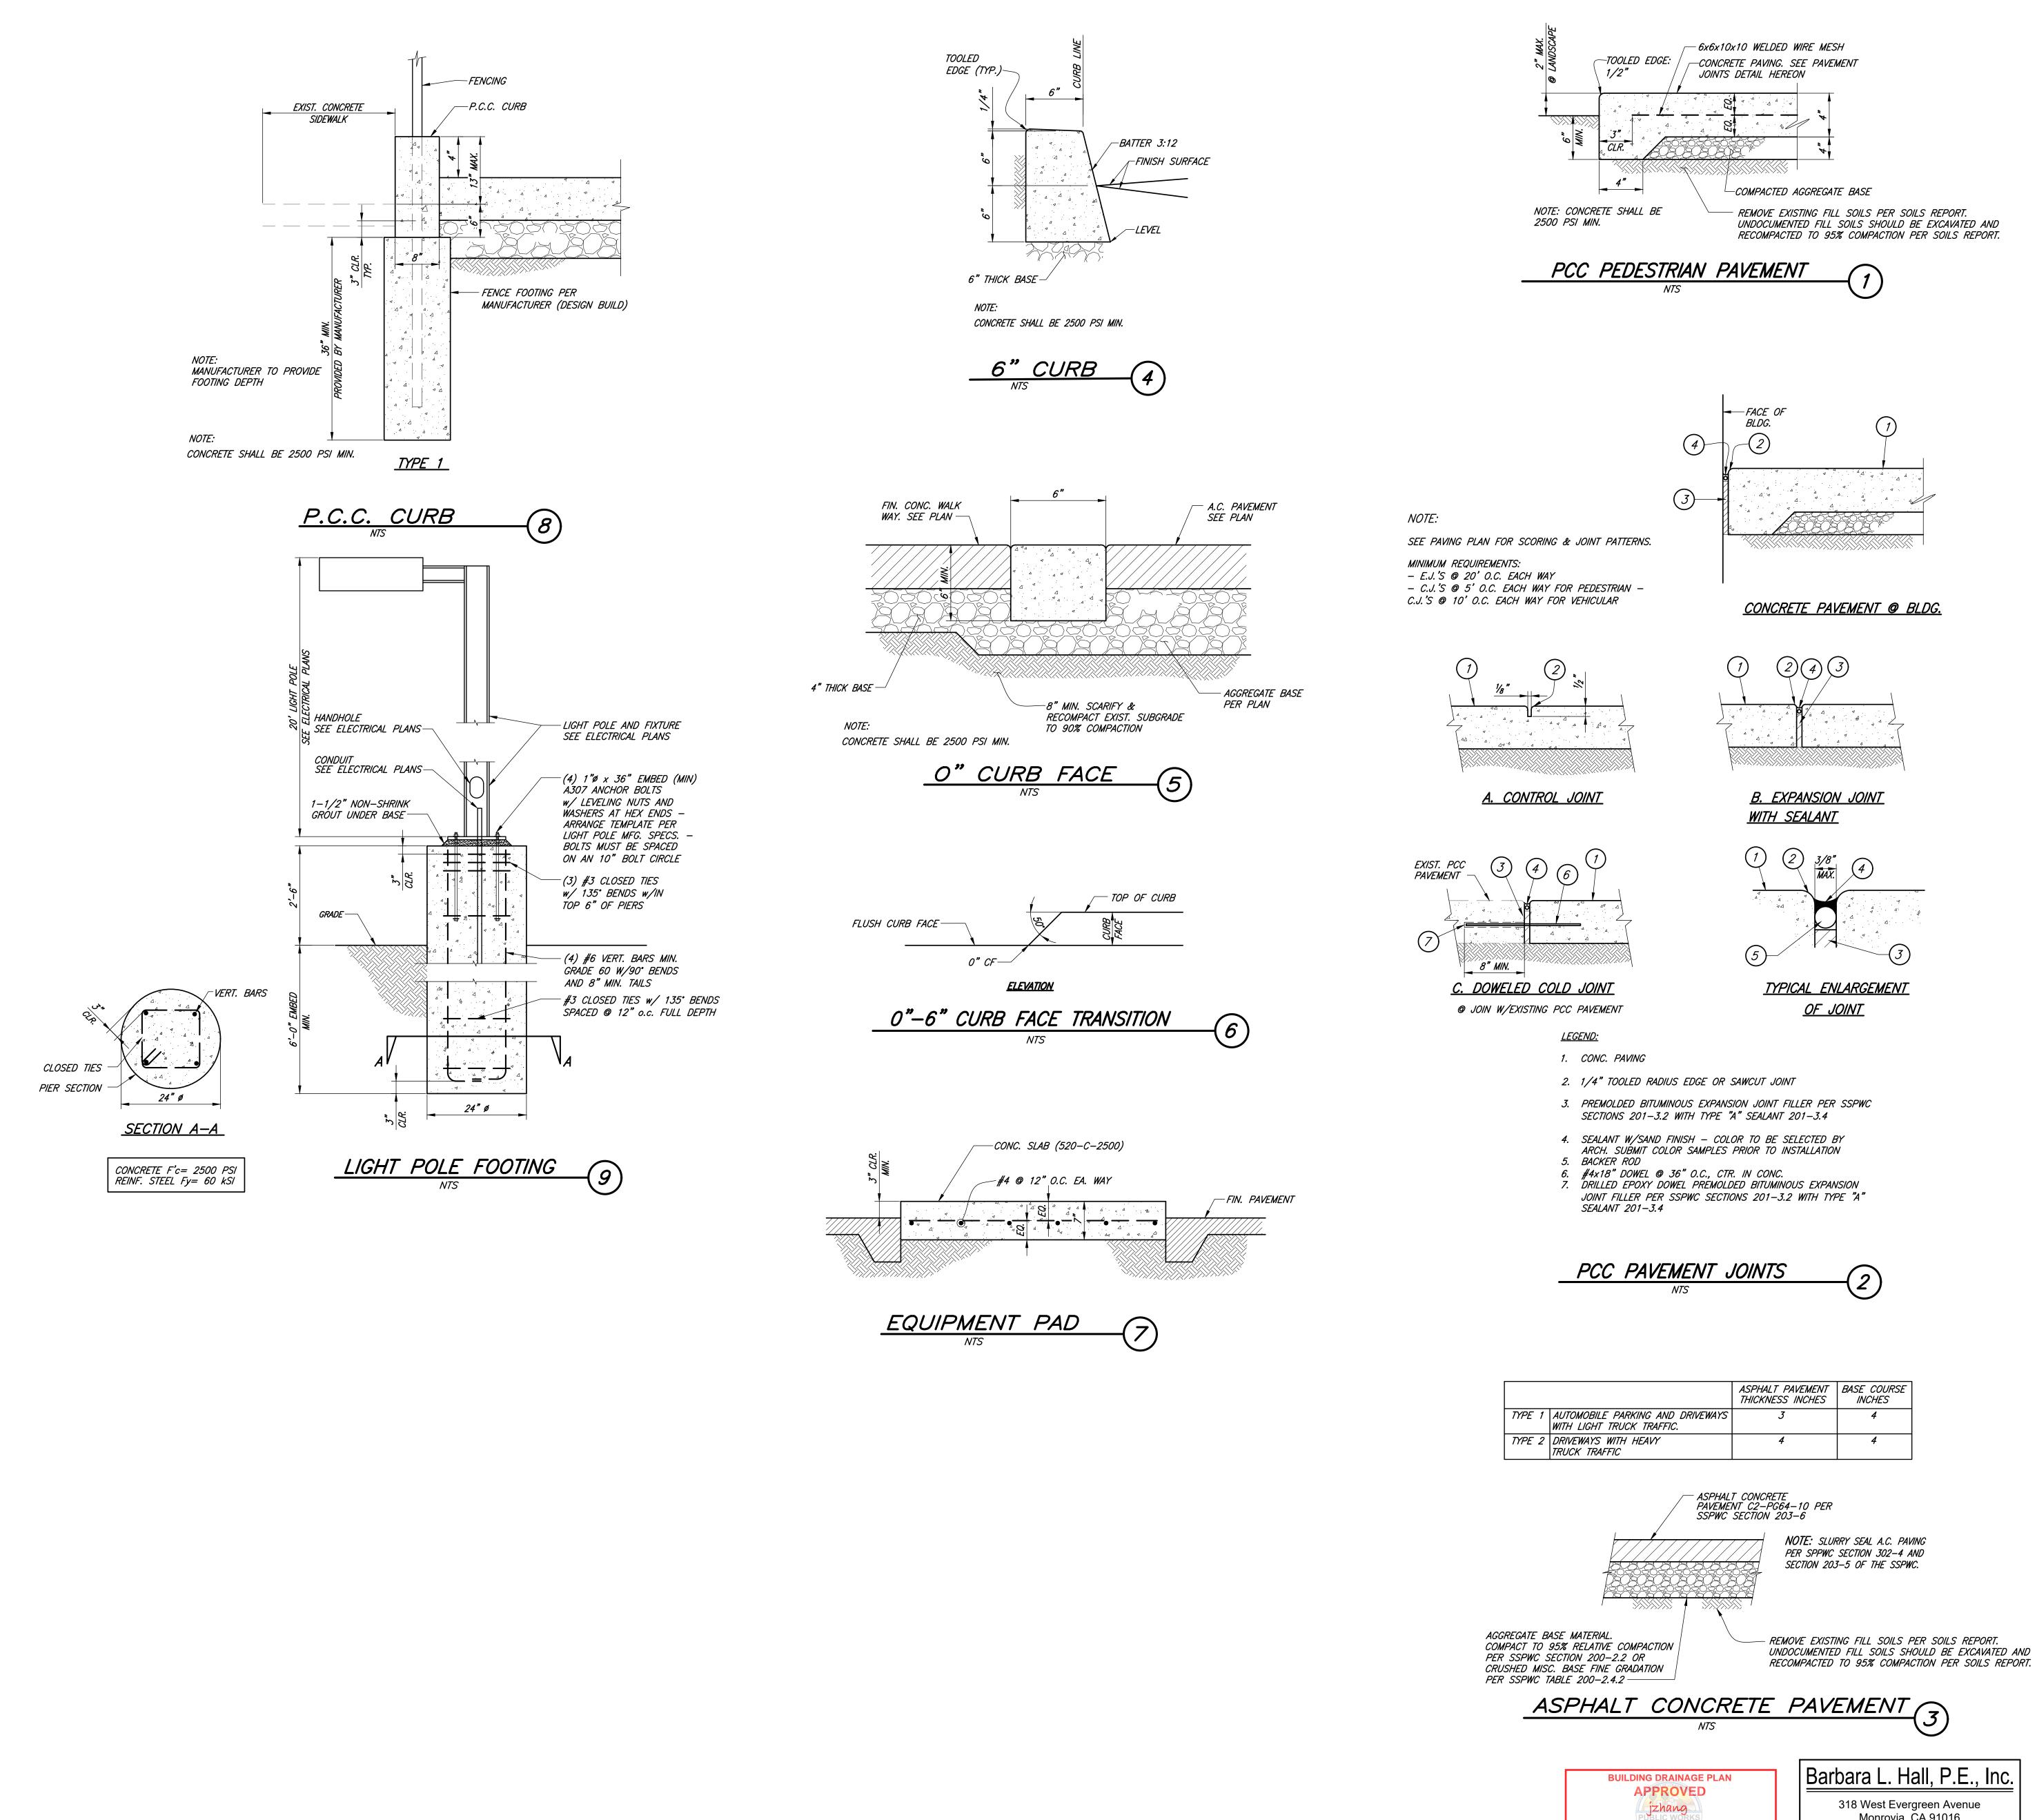
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GRADING PLAN

C2.01

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Registration

Interiors

Client Name COUNTY OF LOS ANGELES PUBLIC WORKS

Project Title DEPARTMENT OF ANIMAL CARE AND CONTROL

HEADQUARTERS **FENCING PROJECT** Project Address

5898 Cherry Ave Long Beach, CA 90805 SPEC #: 7856

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7/2/24

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DETAILS

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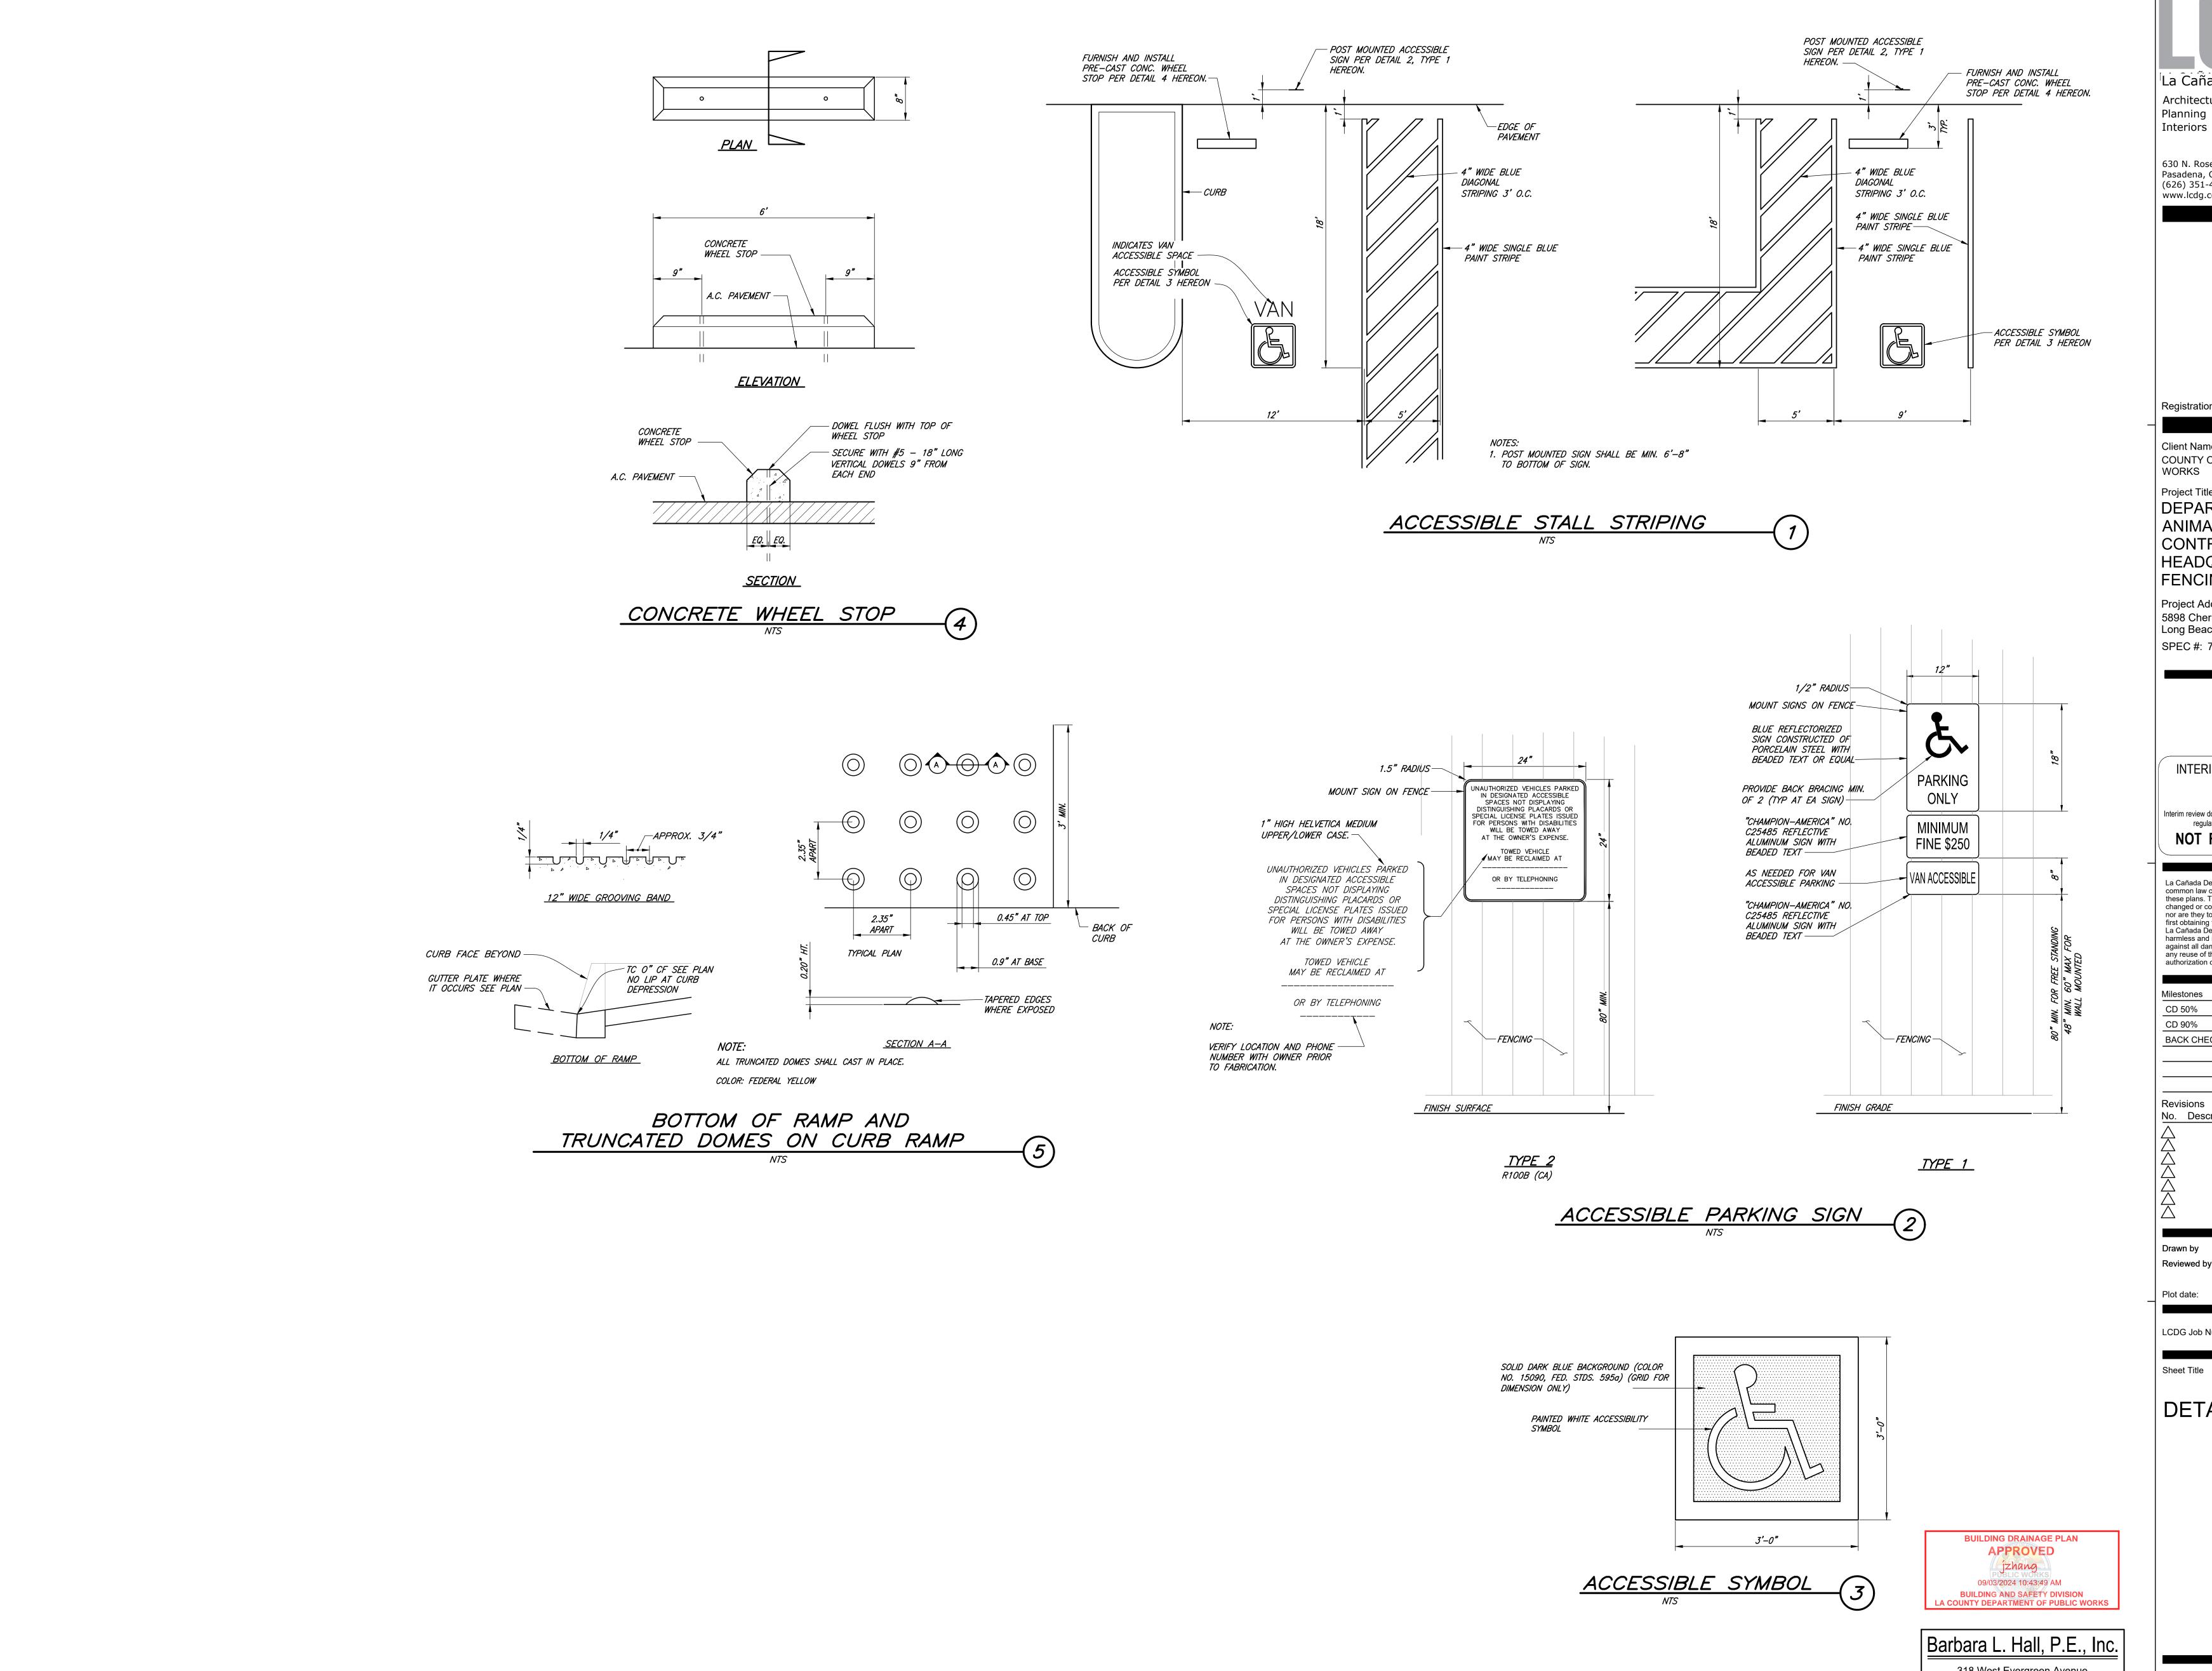
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BUILDING AND SAFETY DIVISION

LA COUNTY DEPARTMENT OF PUBLIC WORKS

Sheet Number

C4.01



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Registration

Client Name COUNTY OF LOS ANGELES PUBLIC WORKS

Project Title DEPARTMENT OF ANIMAL CARE AND

CONTROL HEADQUARTERS **FENCING PROJECT**

Project Address 5898 Cherry Ave Long Beach, CA 90805 SPEC #: 7856

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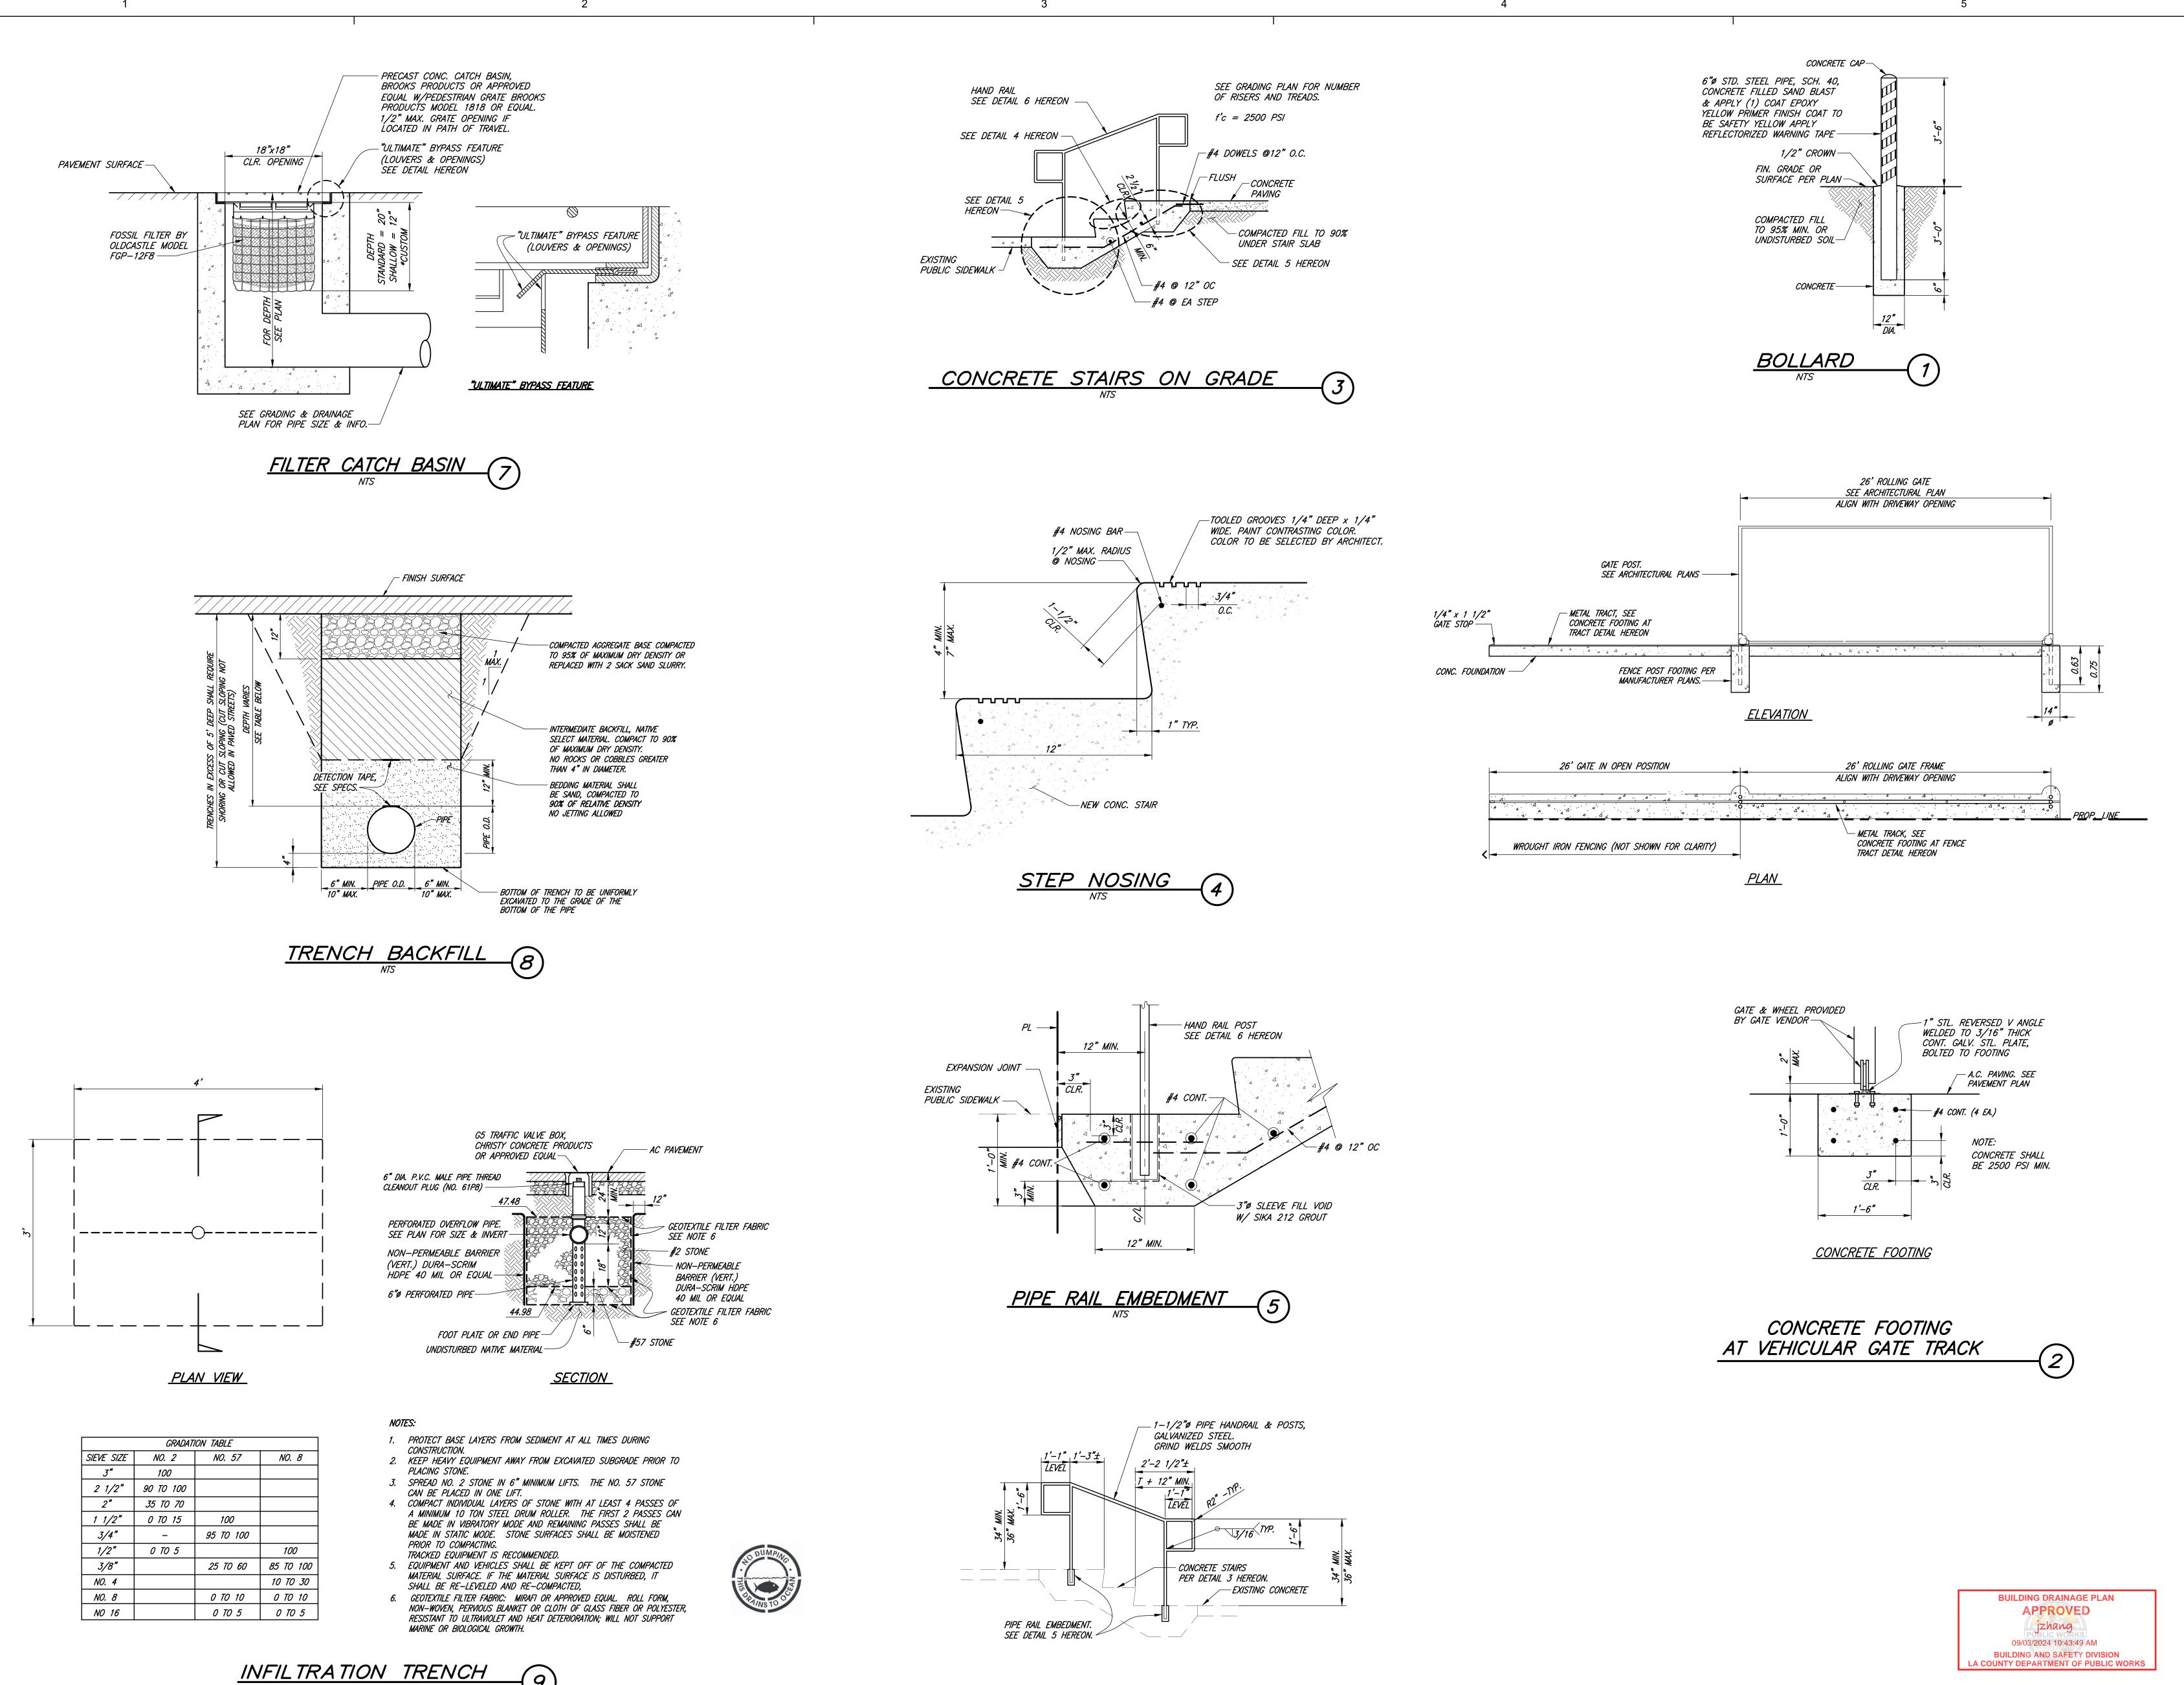
DETAILS

318 West Evergreen Avenue Monrovia, CA 91016 Sheet Number Phone: (626) 256-3220

C4.02

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Fax: (626) 256-3218



HANDRAIL AT CONCRETE STAIRS

Architecture

La Cañada Design Group Planning Interiors

630 N. Rosemead Boulevard, Suite 400 Pasadena, California 91107 (626) 351-4301 FAX (626)351-4302 www.lcdg.com

Registration

Client Name COUNTY OF LOS ANGELES PUBLIC WORKS

Project Title DEPARTMENT OF ANIMAL CARE AND CONTROL HEADQUARTERS

Project Address 5898 Cherry Ave Long Beach, CA 90805 SPEC #: 7856

FENCING PROJECT

INTERIM REVIEW DOCUMENTS

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BACK CHECK 1 7/2/24 Revisions

No. Description

Drawn by Reviewed by Plot date: 8/20/2024 10:23:54 AM

LCDG Job Number:

DETAILS

Sheet Title


Barbara L. Hall, P.E., Inc. 318 West Evergreen Avenue Monrovia, CA 91016 Phone: (626) 256-3220


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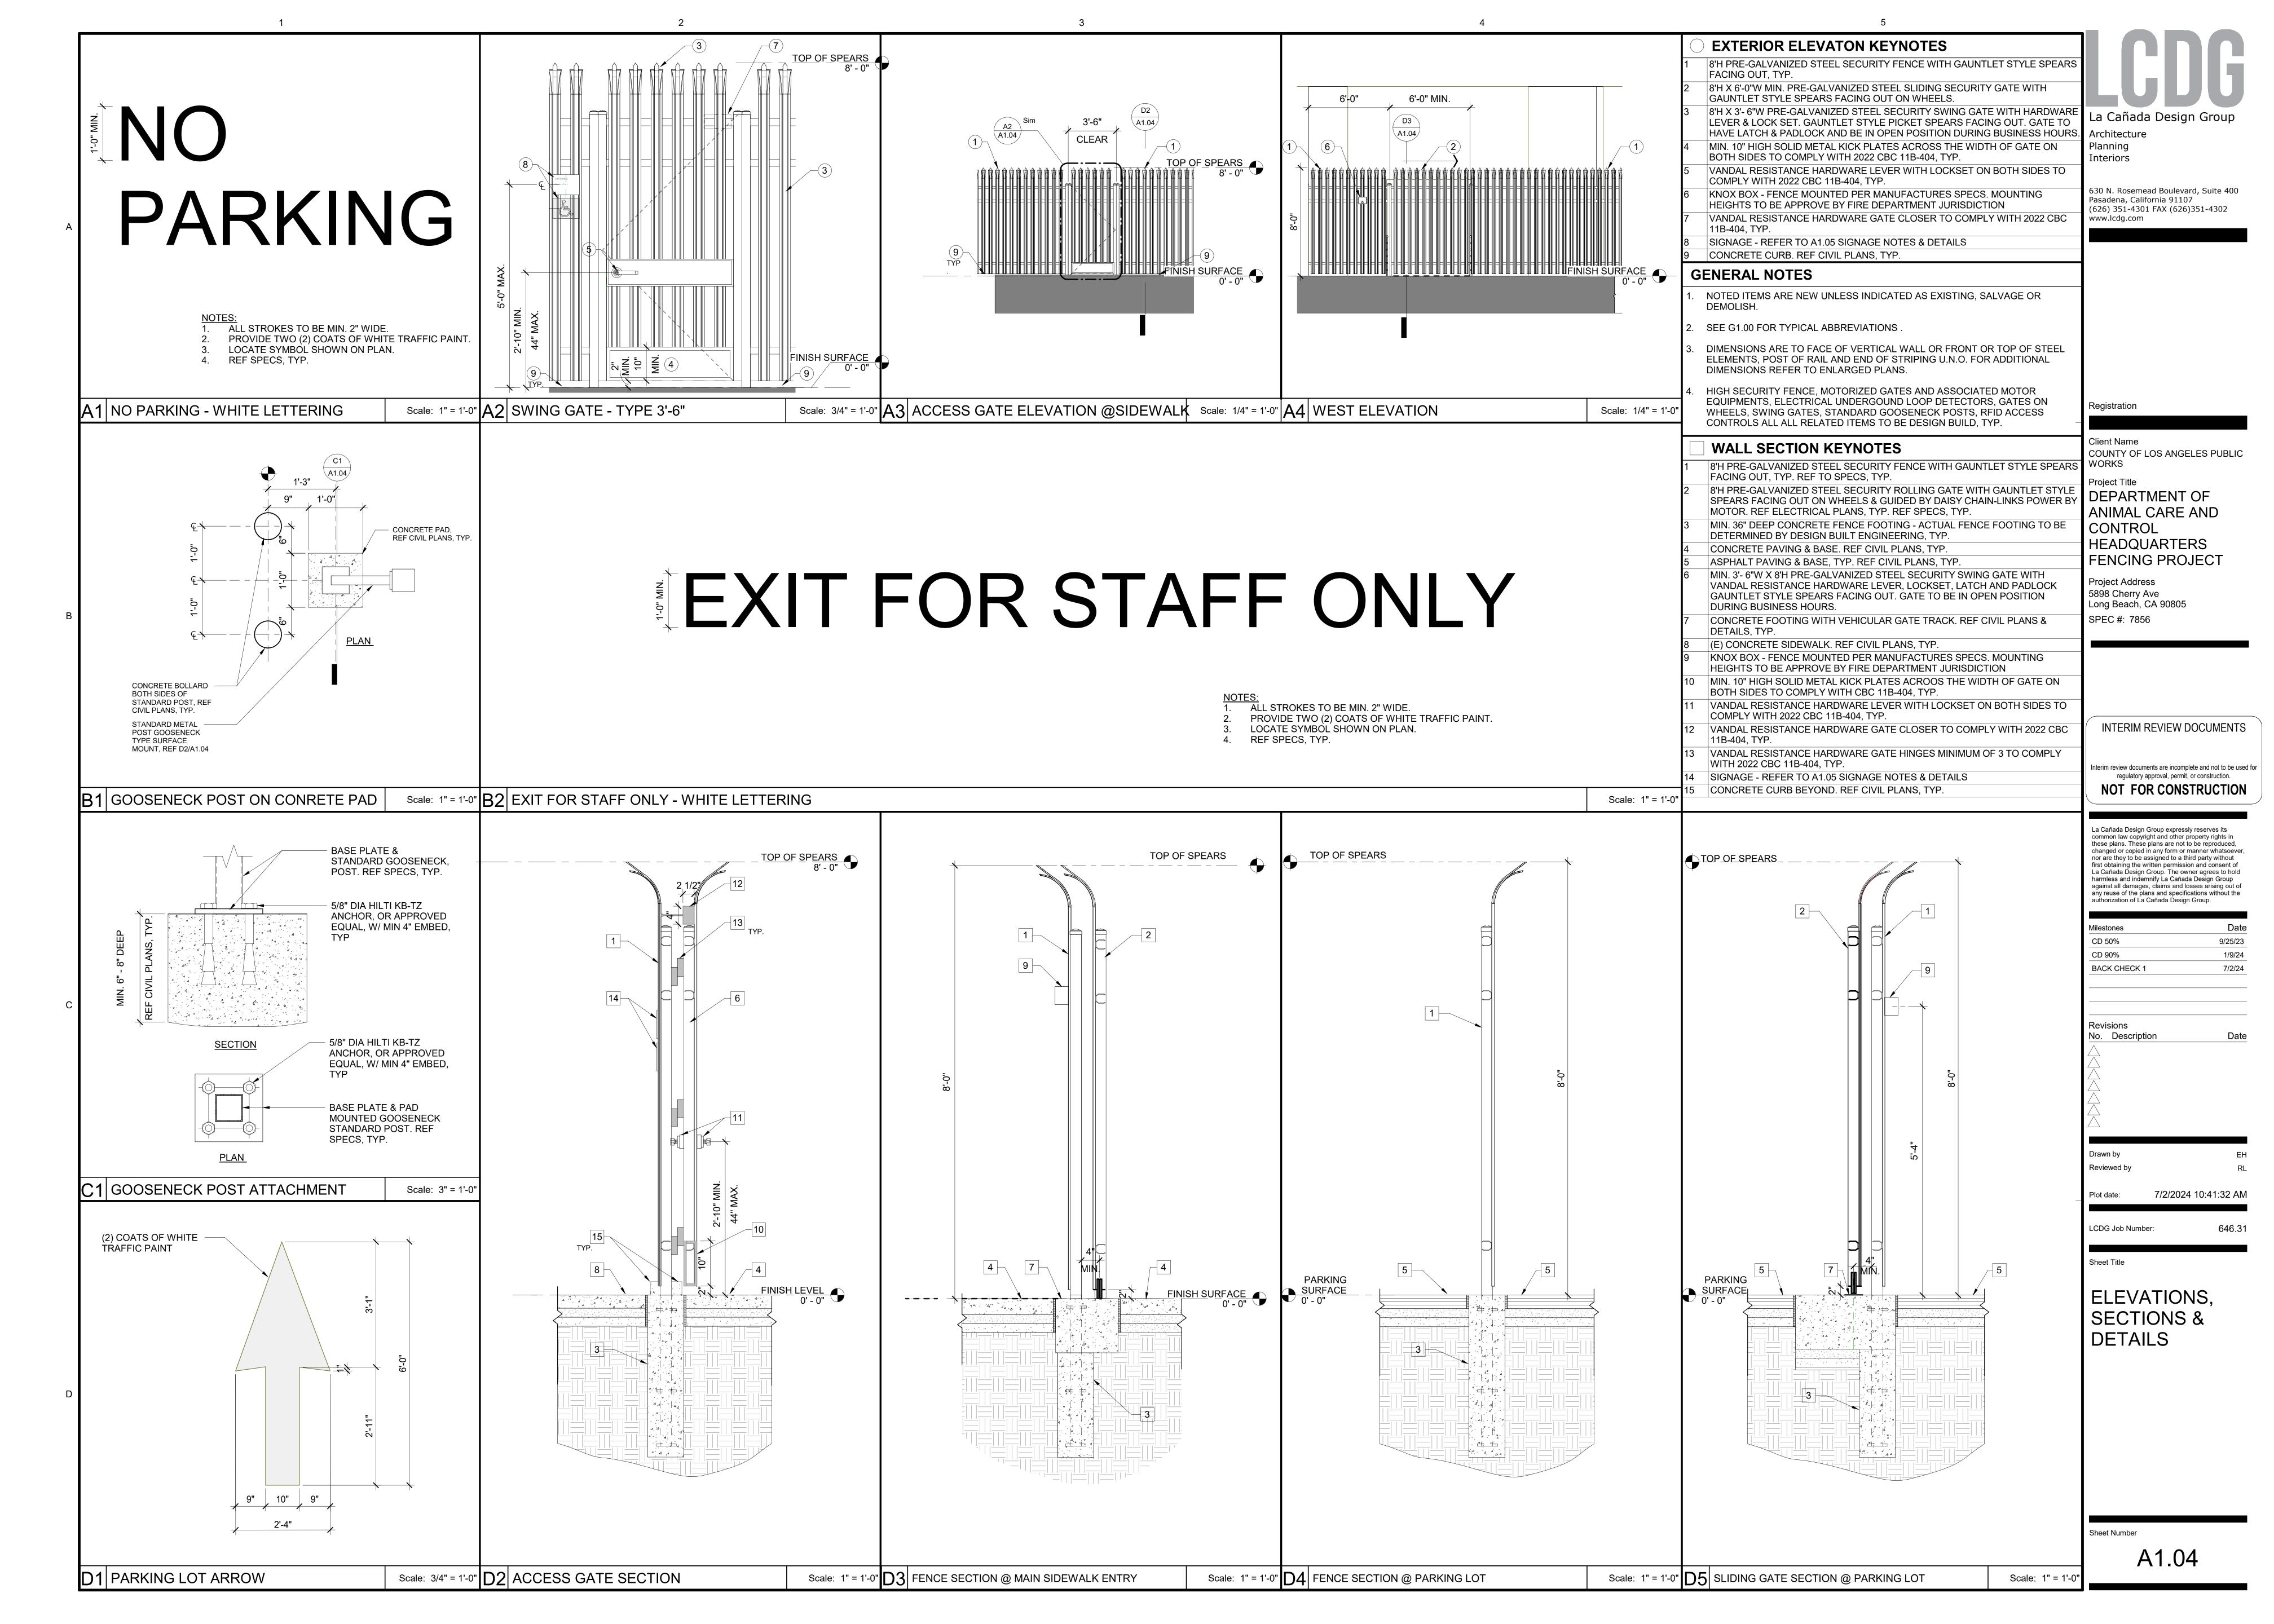
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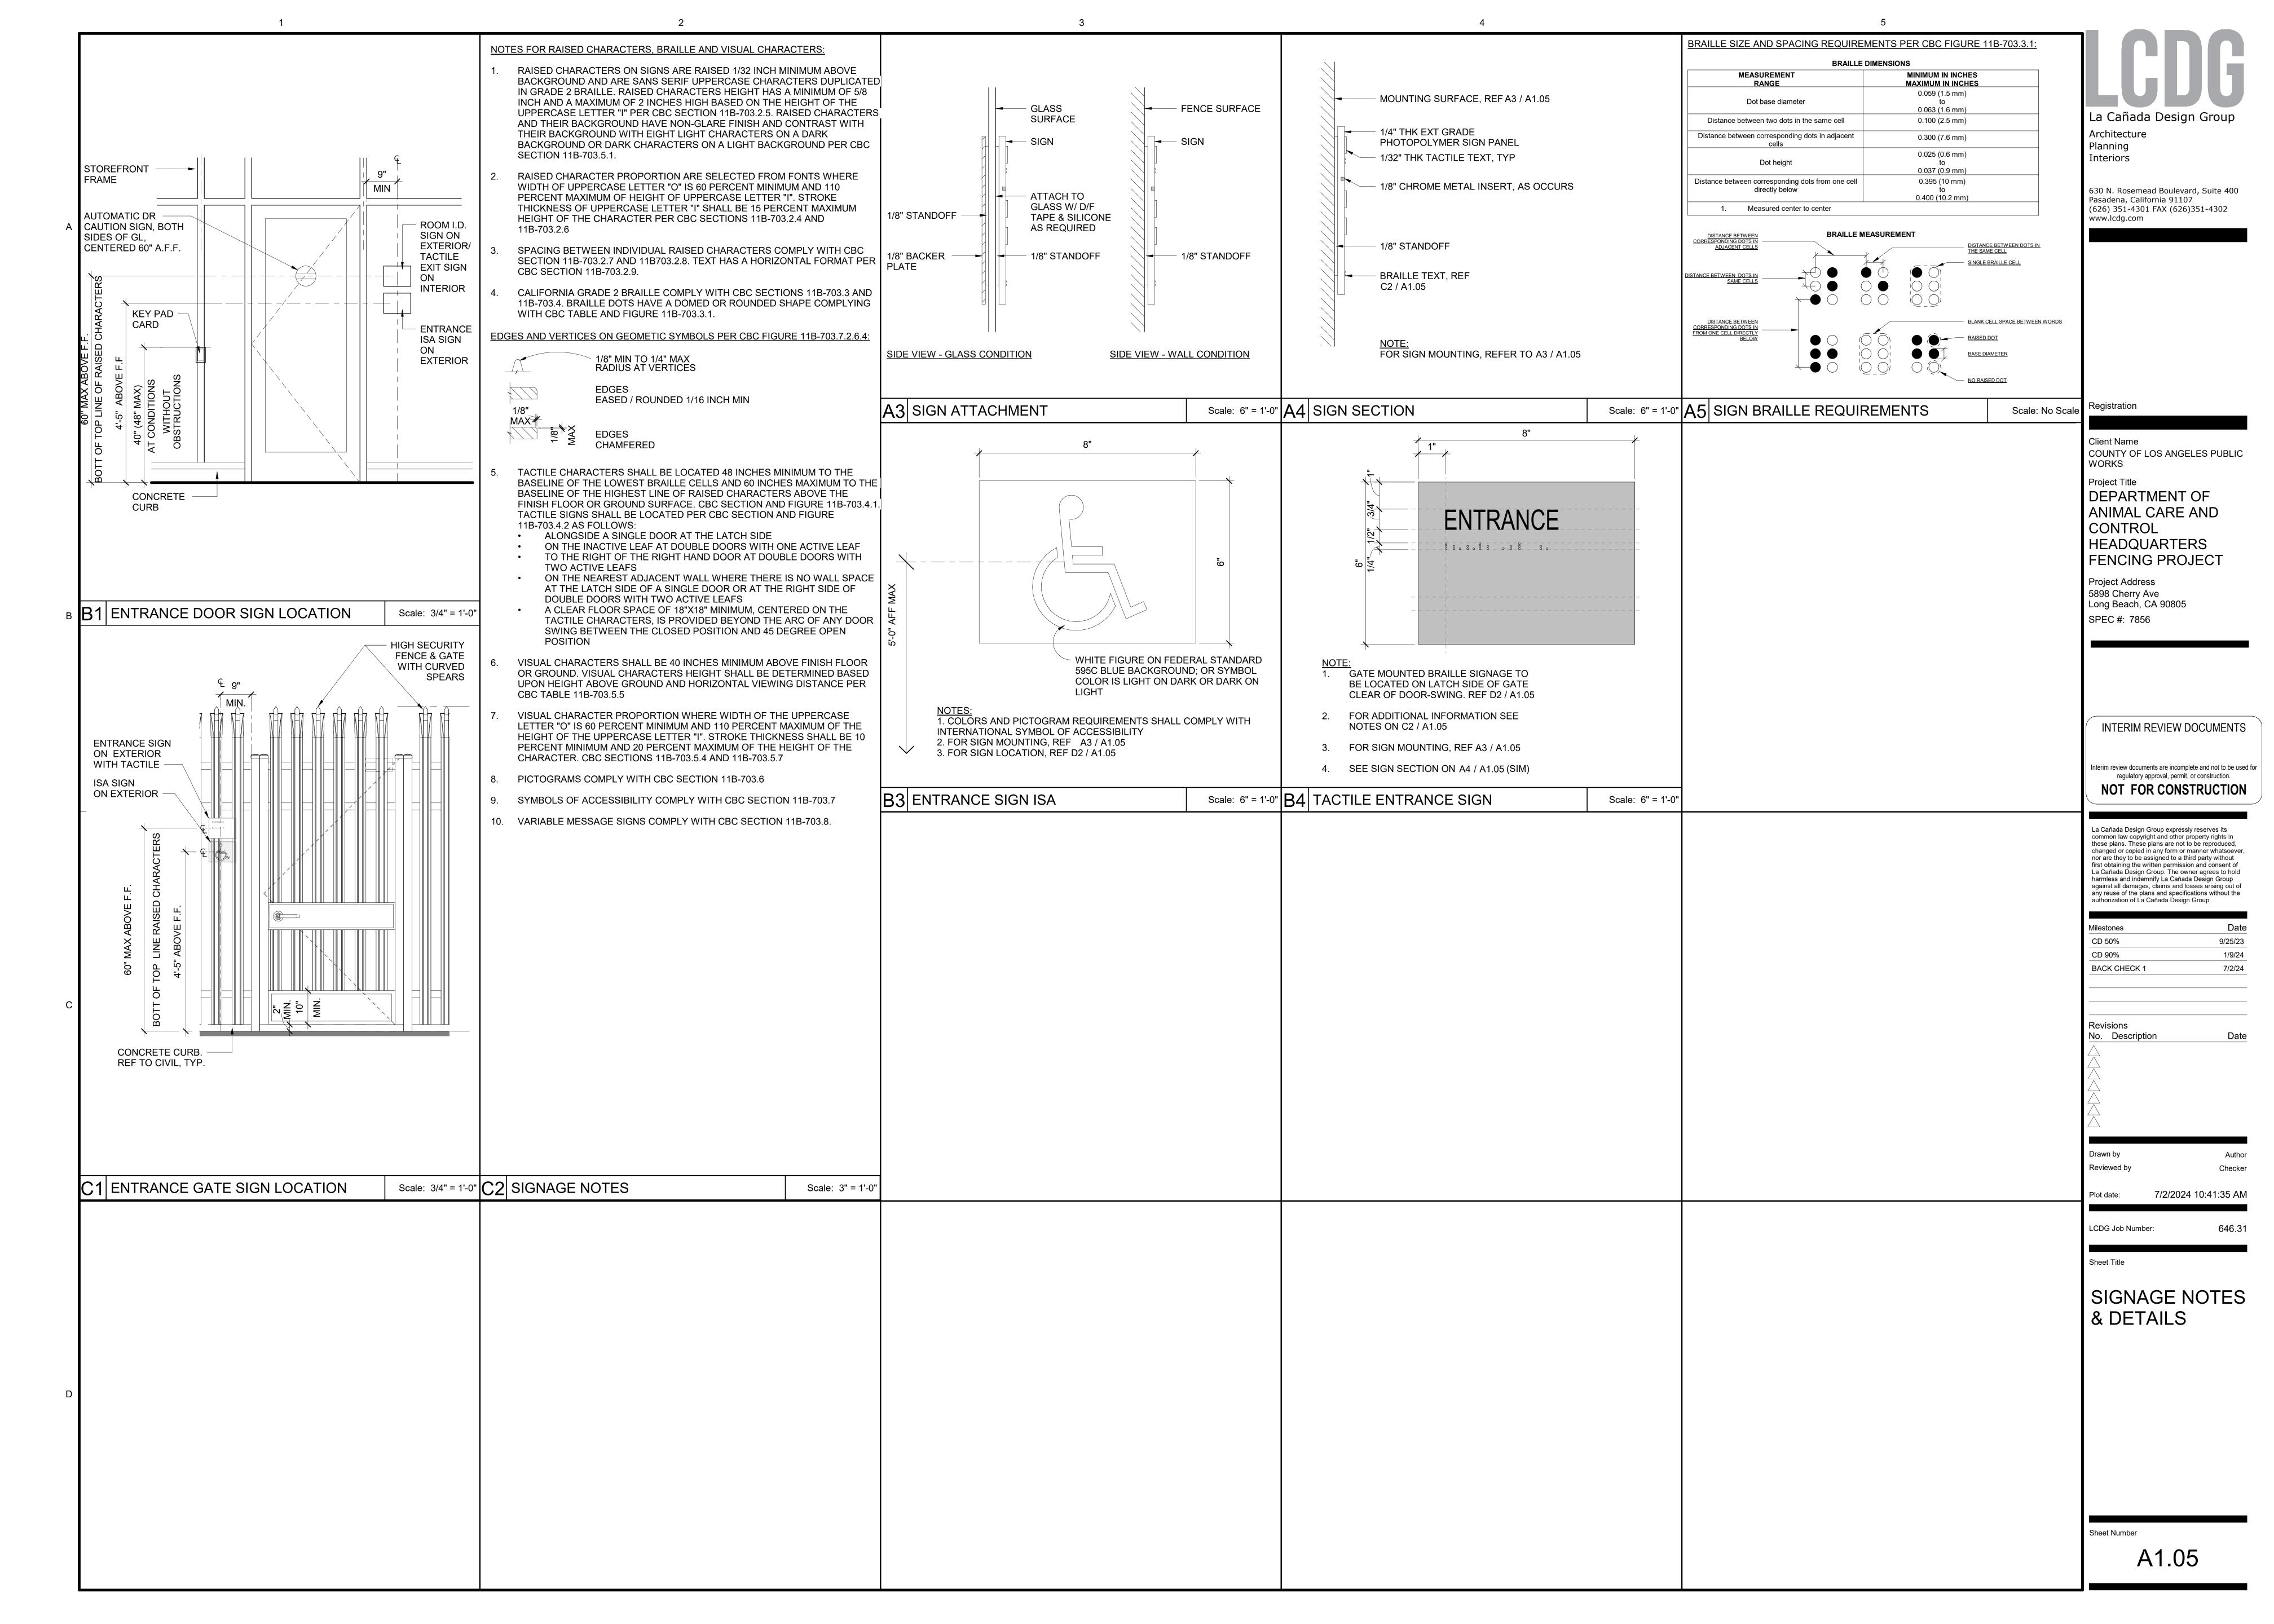
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ELECTRICAL EQ. SYMBOLS LIST

SURFACE MOUNTED/ WALL PANELBOARD

CARD READER: WHERE DOOR KING GATE OPERATOR IS PROVIDED PROVIDE HID SIGNO READER 40 CARD READER OR APPROVED EQUAL WITH CABLING TO OPERATOR AND ACCESS CONTROL PANEL INSIDE BUILDING.

MISC. SYMBOLS LIST

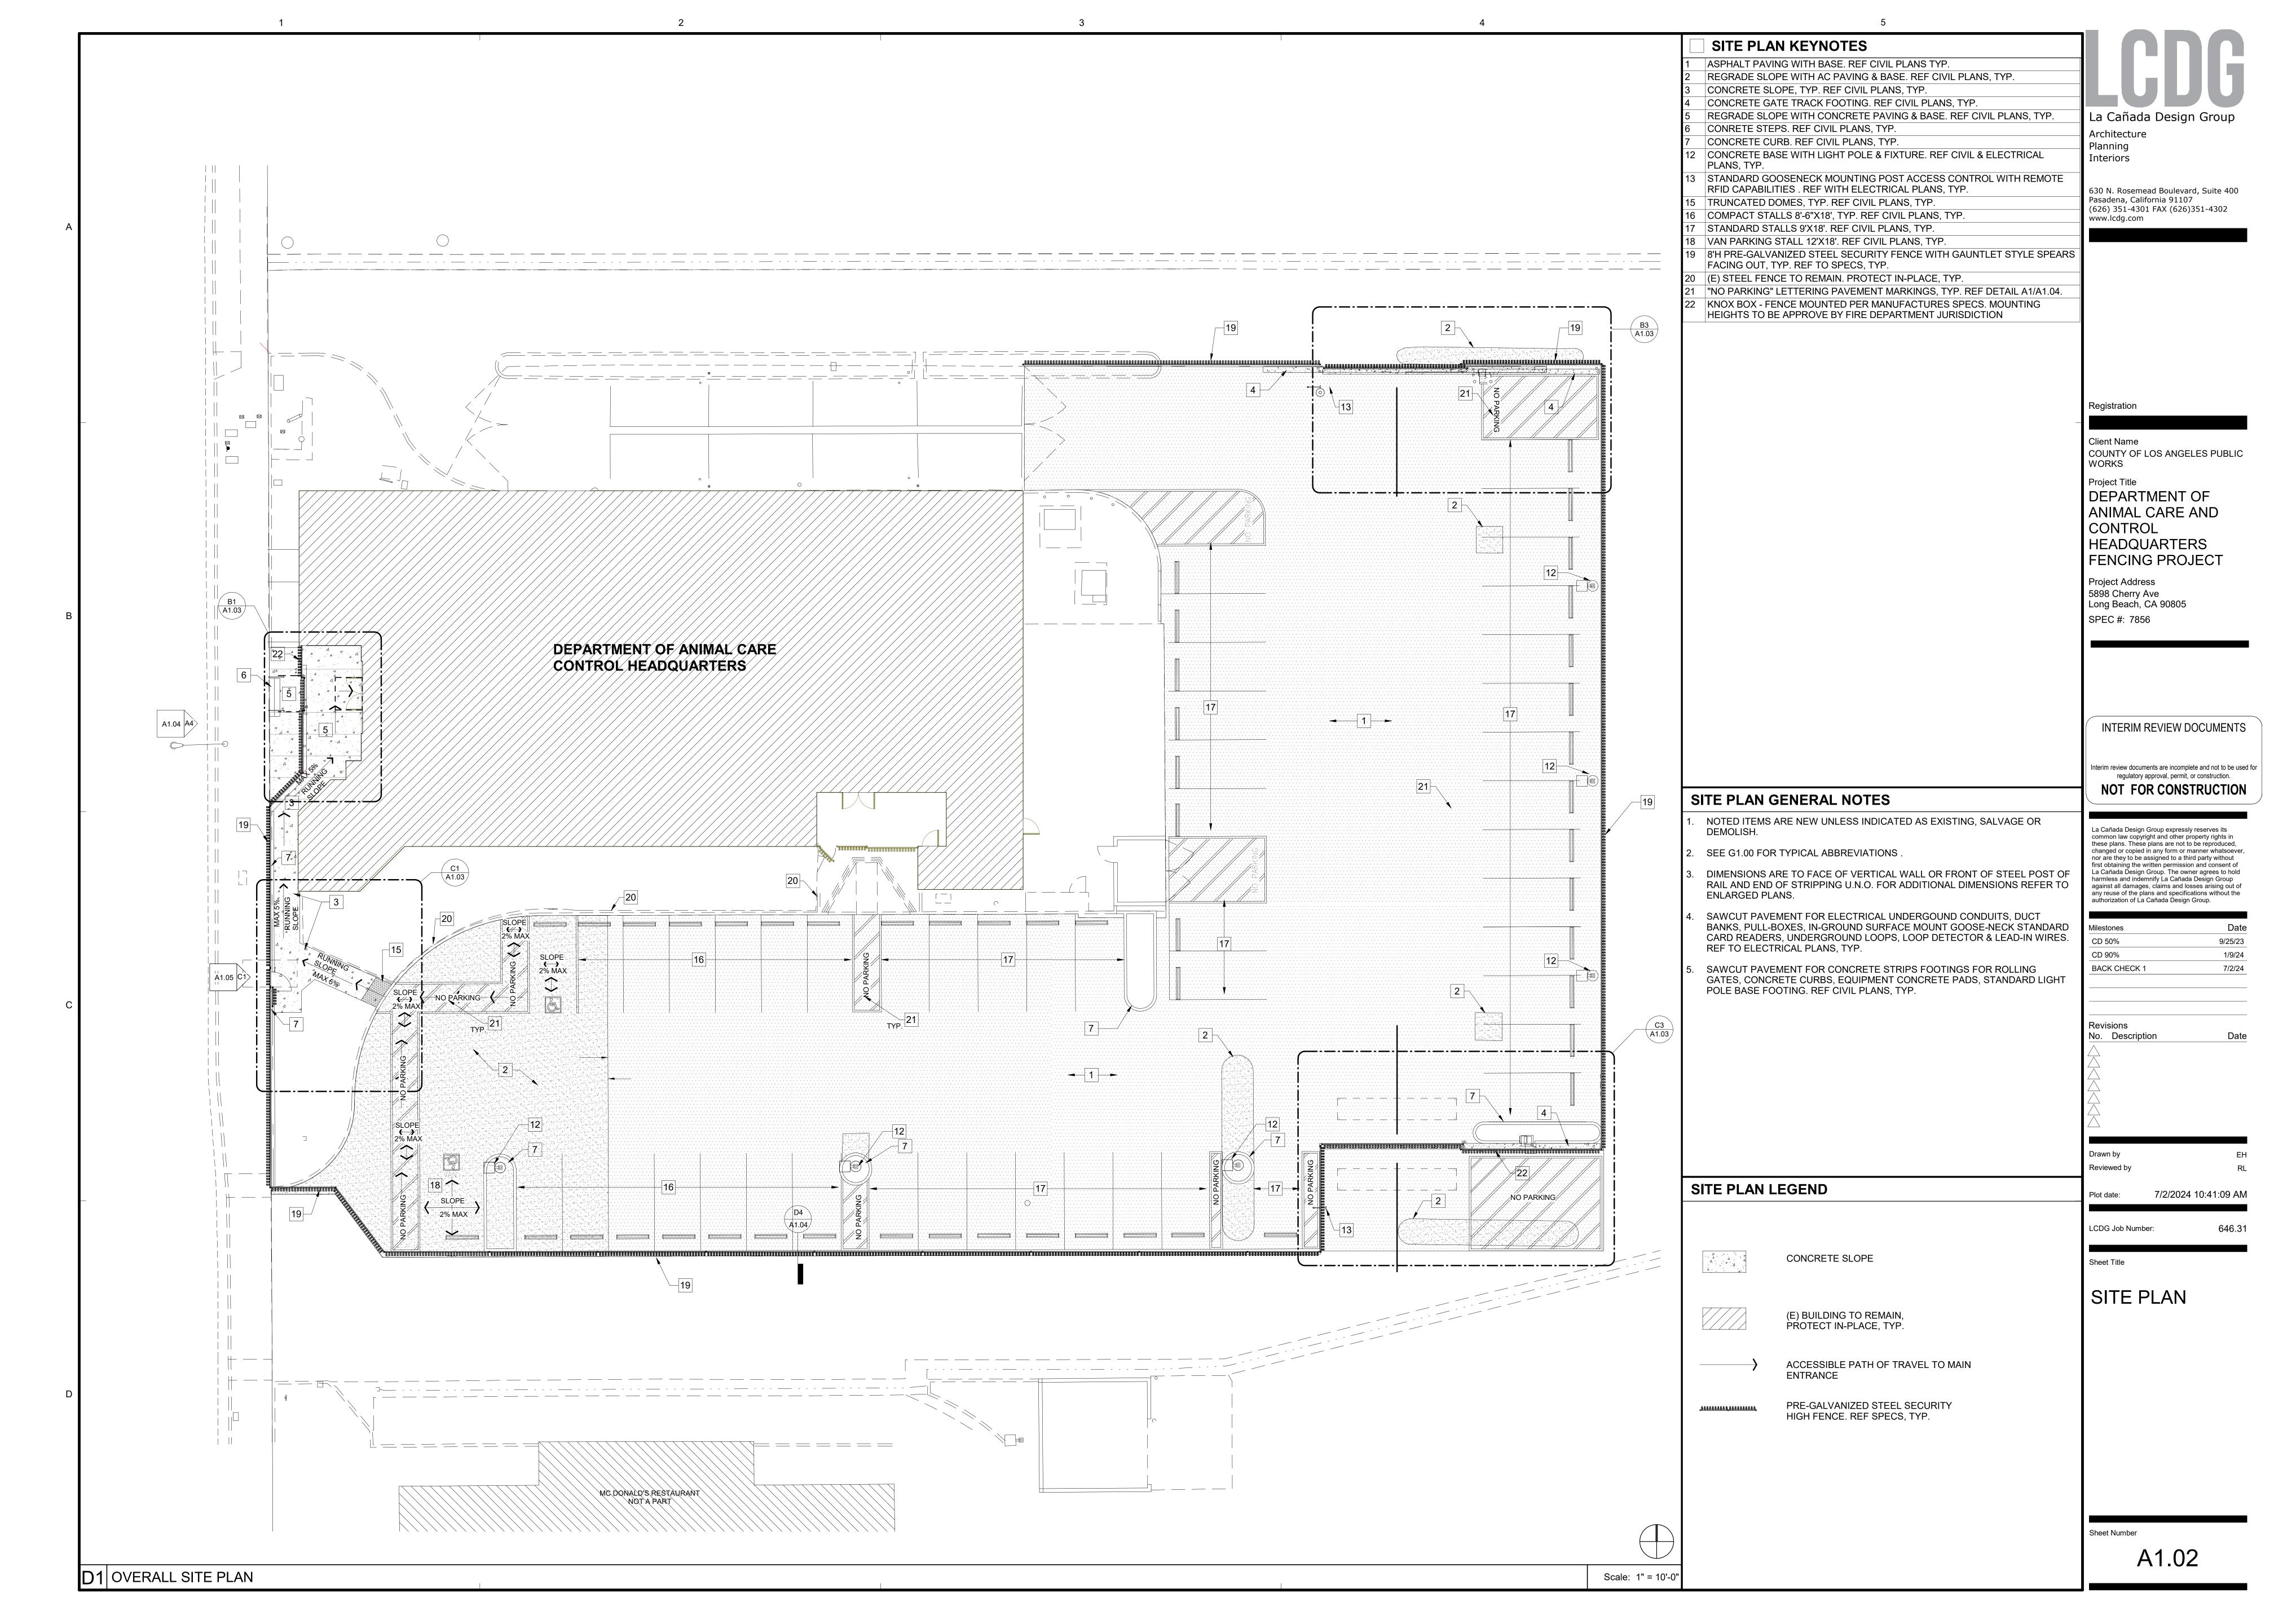CONDUIT SYSTEM RISER UP.

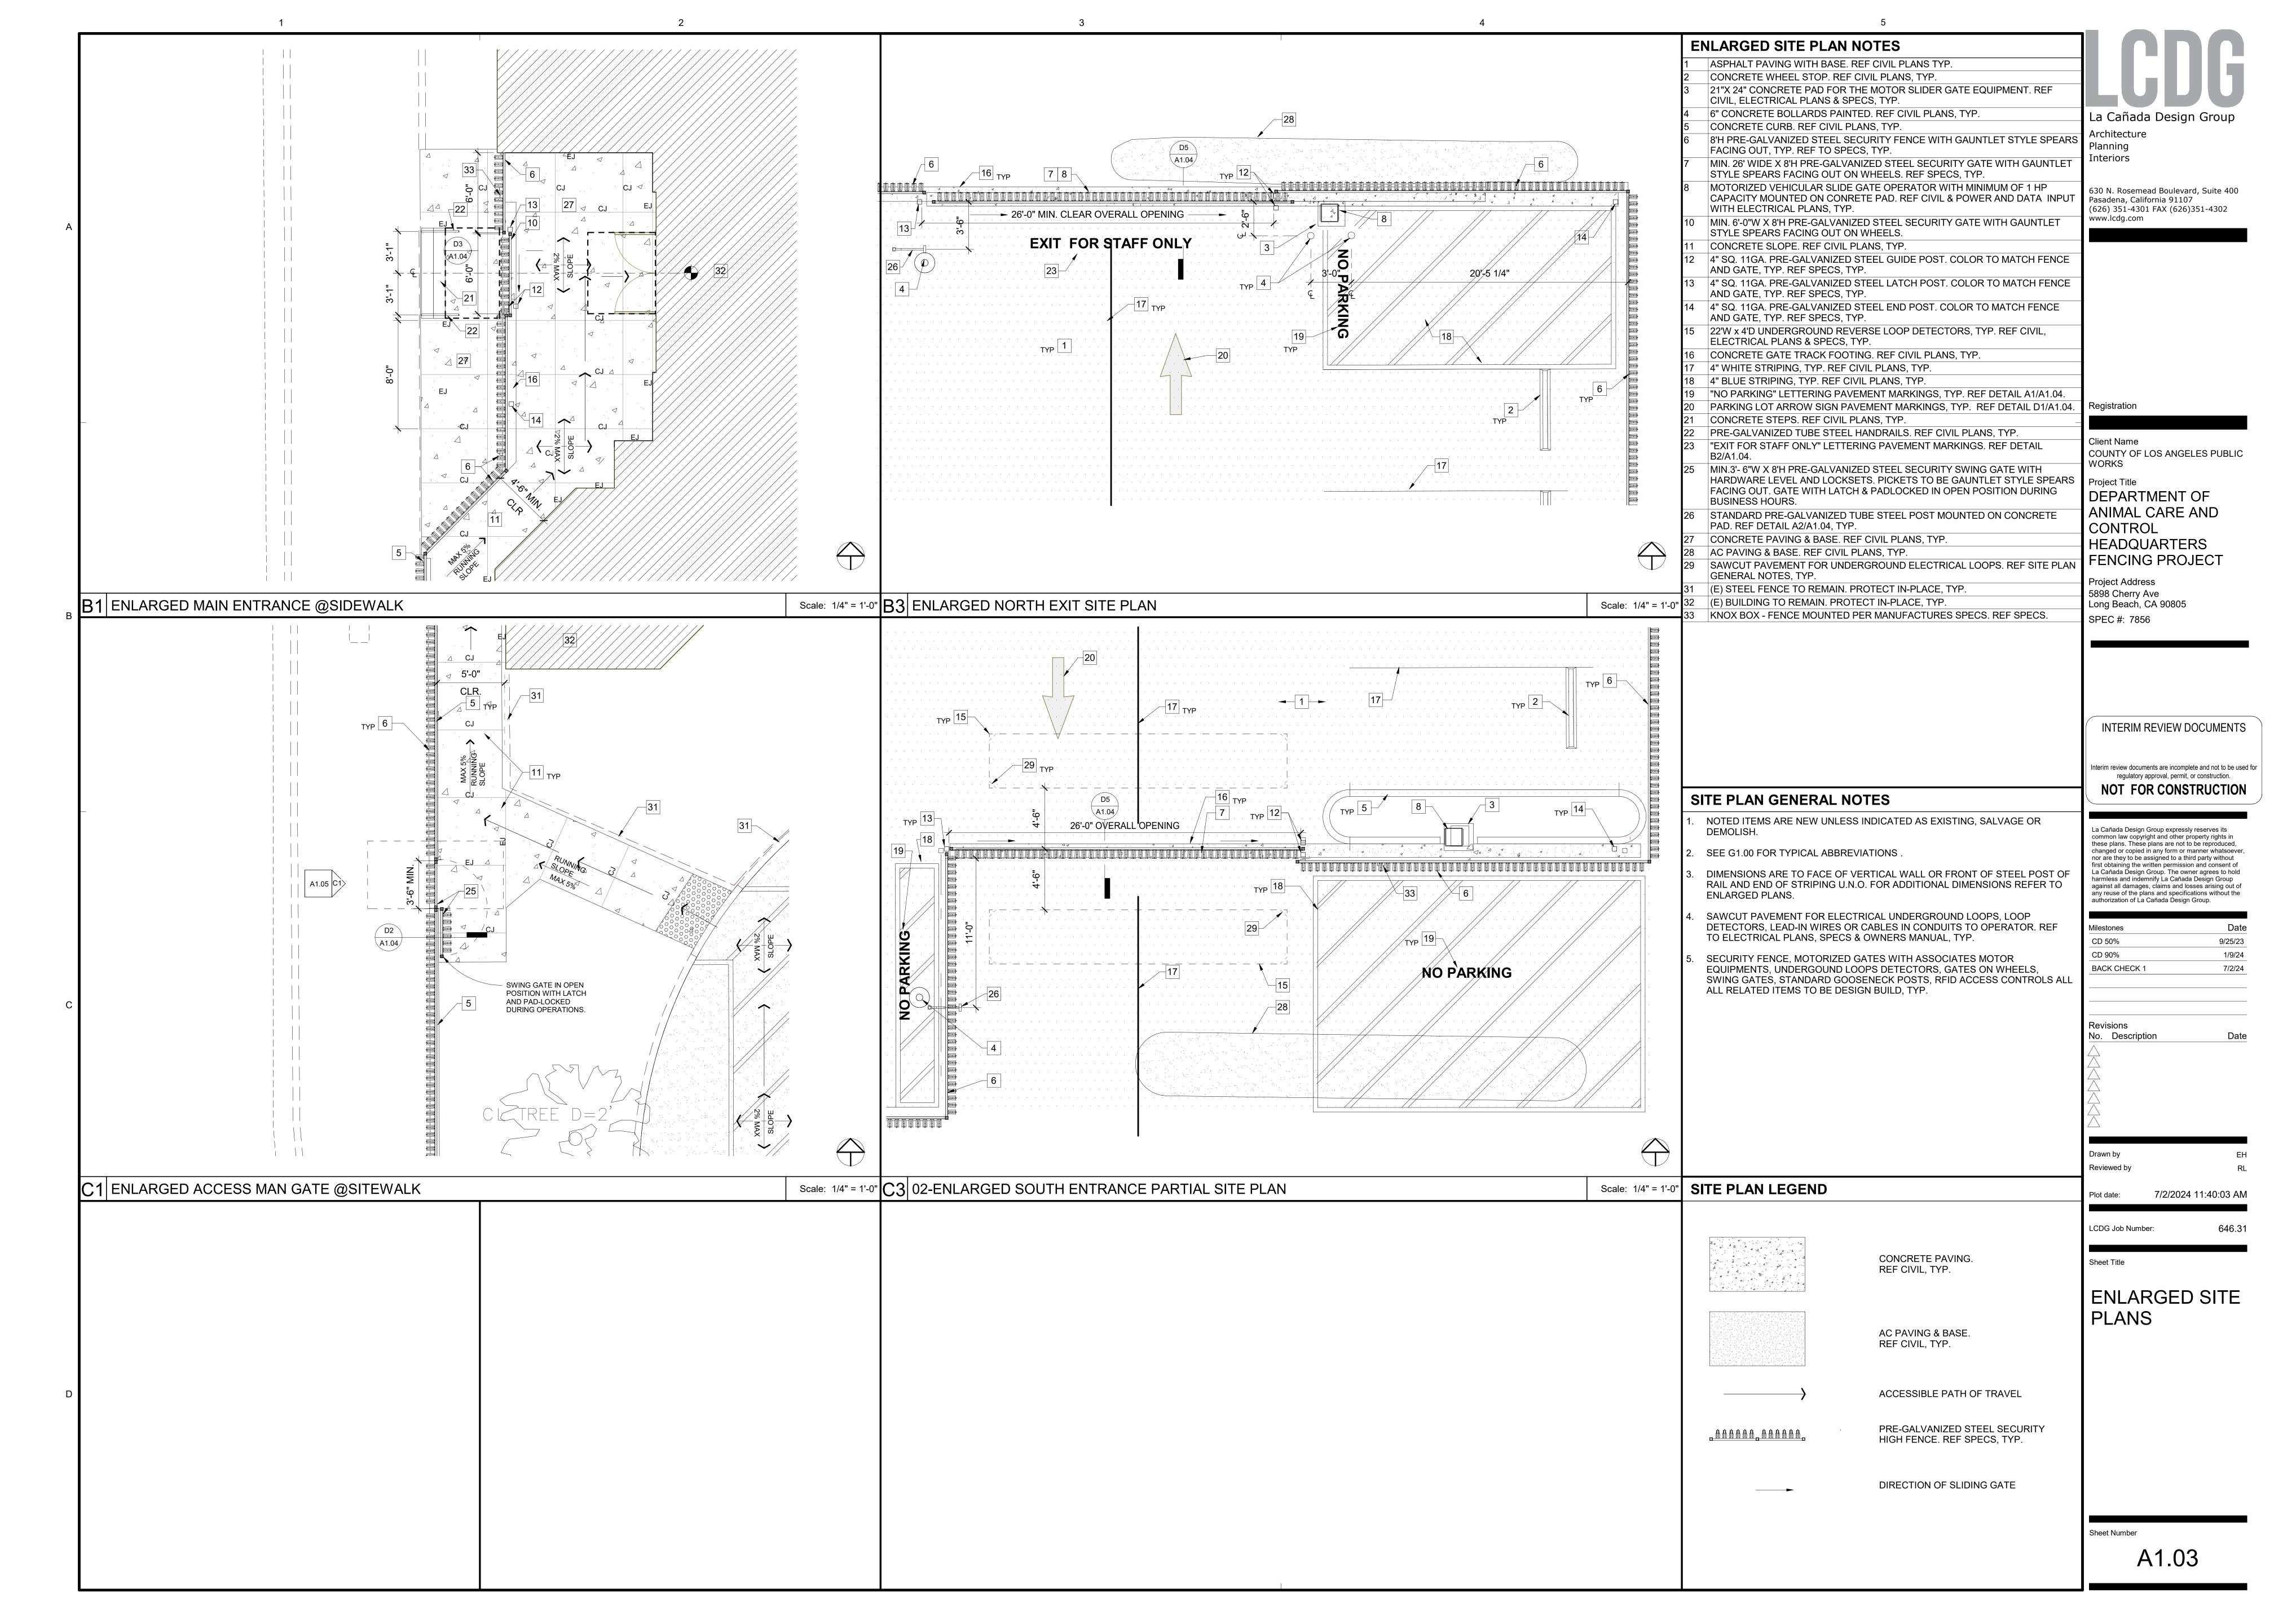CONDUIT SYSTEM RISER DOWN.

APPLICABLE CODES

PART 1 - 2022 CA. BUILDING CODE, TITLE 24 CCR (2018 IBC)

PART 3 - 2022 CA. ELECTRICAL CODE, TITLE 24 CCR (2017 NEC OF THE NFPA)

PART 4 - 2022 CA. MECHANICAL CODE, TITLE 24 CCR (2018 UMC OF THE IAPMO)

PART 5 - 2022 CA. PLUMBING CODE, TITLE 24 CCR (2018 UPC OF THE IAPMO)

PART 6 - 2022 CA. ENERGY CODE, TITLE 24 CCR

PART 7 - CURRENTLY VACANT

PART 8 - 2022 CA. HISTORICAL BUILDING CODE, TITLE 24 CCR

PART 9 - 2022 CA. FIRE CODE, TITLE 24 CCR (2018 IFC OF THE ICC)

PART 10 - 2022 CA. EXISTING BUILDING CODE, TITLE 24 CCR (2018 INTERNATIONAL EXIST. BLDG. CODE OF THE ICC, WITH AMENDMENTS) PART 11 - 2019 CA. GREEN BUILDING STANDARDS CODE (CALGREEN CODE), TITLE 24

PART 12 - 2019 CA. REFERENCED STANDARDS. TITLE 24 CCR

PARTIAL LIST OF APPLICABLE STANDARDS

NFPA 72 NATIONAL FIRE ALARM CODE (CALIFORNIA AMENDED) 2013 EDITION

(NOTE: SEE UL STANDARD 1971 FOR "VISUAL DEVICES")

SCOPE OF WORK

SITE LIGHTING AND ACCESS CONTROL ADDITIONS TO PARKING AREA. PROVIDE NEW PANEL TO POWER PROPOSED GATE OPERATORS AND EXTEND EXISTING SITE LIGHTING TO PROPOSED LED POLE LIGHT LOCATIONS. PROVIDE NEW KEY PAD AND RFID CARD READER FOR GATE OPERATOR ACCESS CONTROL WITH NEW CABLING AND CONNECTIONS PER

LIGHTING CONTROLS LEGEND

TIME SWITCH, WALL MOUNTED, AS SPECIFIED. PROVIDE DUAL SWITCHING CAPABILITY PER TITLE 24 WHERE REQUIRED. SURFACE WALL OUTLET BOX. +48" TO TOP OF BOX, U.O.N.

LIGHT FIXTURE LEGEND

POLE MOUNTED PARKING LOT LIGHT FIXTURE

(E) EXISTING EXTERIOR WALL PACK LIGHT FIXTURE

WIRING LEGEND

----- 3/4"C. 2 #10 + #10 GND.

—### 1"C. 6 #10 + #10 GND.

——— CONDUIT: EXPOSED IN UNFINISHED AREA; CONCEALED ABOVE CEILING OR IN WALL IN FINISHED AREAS.

——— CONDUIT: IN OR BELOW FLOOR OR BELOW GRADE. SIZE & NUMBER OF CONDUCTORS AS NOTED.

HOMERUN TO PANEL "A", CIRCUITS 1,3,5. EQUIPMENT GROUNDING CONDUCTOR IS NOT REPRESENTED IN THE CROSS MARKS BUT IS TO BE INCLUDED IN ALL RACEWAYS. (NO CROSS LINES INDICATE (2)#12 + #12 GROUND.)

GENERAL NOTES

(OAR) PRIOR STARTING WORK A DAILY RECORD OF ALL DEVIATIONS FROM THE BID DRAWINGS. ALL DIMENSIONS AND OTHER INFORMATION THE CONTRACTOR SHALL USE SUFFICIENT BARRICADES AND NECESSARY TO COMPLETELY EXPLAIN AND LOCATE ALL ELEMENTS OF THESE DEVIATIONS SHALL BE RECORDED TEMPORARY PROTECTION DEVICES TO PREVENT PEDESTRIANS OR NON-AUTHORIZED PERSONNEL ACCESS TO UPON COMPLETION OF WORK, THE CONTRACTOR SHALL ANY OPEN TRENCHES OR CONSTRUCTION ACTIVITY. THE SUBMIT TO THE OWNER, ONE COMPLETE SET OF REPRODUCIBLE DRAWINGS CORRECTED TO REFLECT CONTRACTOR SHALL ERECT A SAFETY BARRICADE AT ALL "AS-BUILT" CONDITIONS OF THE WORK. OPEN TRENCHES, DITCHES, PITS, SUMPS, ETC FOR THE PROTECTION AND SAFETY OF THE PUBLIC. ALL TRENCHES OUTSIDE OF THE BARRICADE LIMITS SHALL BE BACKFILLED AND PAVED NOT LATER THAN 72 HOURS AFTER BEING

OPENED. DURING THE TIME THE TRENCHES ARE OPEN IN

PLATES. SAFETY BARRICADES SHALL BE PANELIZED CHAIN

LINK FENCE. EACH FENCE PANEL SHALL BE 6FT TALL X 10FT

MINIMUM 8-GAUGE WIRE. NO TRENCHES SHALL BE LOCATED

FROM THE BEST INFORMATION AVAILABLE TO THE OWNER AT

THE TIME THE DRAWINGS WERE PREPARED. THE OWNER

PROVIDES THIS ONLY AS A GENERAL GUIDELINE FOR THE

CONVENIENCE OF BIDDERS/CONTRACTORS AND DOES NOT

REPRESENTATIONS. NOTHING IN THIS DISCLAIMER AFFECTS

EQUIPMENT AND MATERIAL APPROVED FOR USE UNDER THIS

EXTERIOR EQUIPMENT, JUNCTION BOXES, ENCLOSURES AND CONNECTIONS SHALL BE WEATHERPROOF TYPE SUITABLE

FOR EXTERIOR INSTALLATION.(MALLEABLE IRON FITTINGS)

IN ANY WAY THE DUTY OF THE CONTRACTOR TO FURNISH

ALL FEEDERS AND BRANCH CIRCUITS SHALL CARRY A

GROUND WIRE, SIZED AS PER N.E.C. ARTICLE 250.

CONTRACTOR SHALL INSTALL EQUIPMENT PER ADA

(AMERICAN DISABILITIES ACT) REQUIREMENTS

IN THE EVENT THAT CERTAIN FEATURES OF THE

10. ARE NOT FULLY SHOWN ON THE CONSTRUCTION

DOCUMENTS. THE FEATURES SHALL BE OF THE SAME

11. ALL DIMENSIONS. ELEVATIONS AND EXISTING CONDUITS

DISCREPANCIES SHALL BE BROUGHT TO THE OAR'S

12. THE ENGINEER HAS PREPARED THESE DOCUMENTS ONLY

CONSTRUCTION. MATERIAL OR EQUIPMENT NOTED AS

13. DEMOLITION AND/OR REMOVAL OF ELECTRICAL EQUIPMENT

SHALL BE RETURNED TO OWNER OR AS DIRECTED BY THE

SYSTEM SHALL BE CLEARLY MARKED WITH PERMANENT INK

FELT PEN IDENTIFYING THE BRANCH CIRCUIT (BOTH PANEL

NUMBER AND CIRCUIT NUMBER) CONTAINED IN THE BOX.

15. THE CONTRACTOR SHALL MAINTAIN THE UNIFORMITY AND

. TEST THE ENTIRE SYSTEM TO DEMONSTRATE TO THE OAR

NECESSARY CORRECTIONS AND LEAVE SYSTEMS READY FOR

. DRAWINGS ARE ESSENTIALLY DIAGRAMMATIC AND THE SIZE

WITH OTHER WORK. CONTRACTOR SHALL PROVIDE TO THE

ENGINEER A 1/4"=1'-0" OF SCALED DRAWING OF ELECTRICAL

EQUIPMENT ROOMS SHOWING LOCATION AND CLEARANCES

OF SUBMITTED EQUIPMENT FOR REVIEW AND APPROVAL

18. PROVIDE HANGERS, SUPPORTS, SEISMIC RESTRAINTS AND/

FIXTURES TO SUSTAIN VERTICAL LOADS AND RESIST

19. PER CEC 300-21, "OPENINGS AROUND ELECTRICAL

TERMINATION FOR ALL CONDUCTORS.

RESISTANCE RATING."

OR BRACING FOR ALL EQUIPMENT, CONDUIT, AND LIGHTING

HORIZONTAL FORCES IN ANY DIRECTION TO COMPLY WITH 2016 EDITION OF TITLE 24, PART 2, CALIFORNIA BUILDING

PENETRATIONS THROUGH FIRE-RESISTANT-RATED WALLS, PARTITIONS, FLOORS, CEILINGS SHALL BE FIRESTOPPED

USING APPROVED METHODS TO MAINTAIN THE FIRE

20. ALL CONDUCTORS FOR FEEDERS AND BRANCH CIRCUITS

#12 AWG MAY BE SOLID OR STRANDED. #10 AND LARGER

21. ALL ELECTRICAL WORK SHALL BE PER THE APPLICABLE CEC

REQUIRED LABOR, MATERIAL, EXPERTISE AND QUALIFIED

PERSONNEL TO COMPLETELY INSTALL IN A CODE COMPLIANT

DOCUMENTS (DRAWINGS), OBTAIN CLARIFICATION FROM THE

STRINGENT OR MORE EXPENSIVE REQUIREMENT(S) SHALL

ENGINEER PRIOR TO BID. FOR BIDDING PURPOSES THE MORE

CODE. CONTRACTOR SHALL INCLUDE IN HIS BID ALL

22. WHEN THERE ARE DISCREPANCIES BETWEEN CONTRACT

MANNER, ALL WORK SHOWN ON THE PLANS.

SHALL BE STRANDED. PROVIDE 75°C RATED AND APPROVED

CODE, CHAPTER 16, TABLE 16A AND ASSOCIATED NOTES.

PRIOR TO ORDERING OF ELECTRICAL EQUIPMENT.

AND LOCATION OF EQUIPMENT IS INDICATED TO SCALE

CONTINUITY OF THE GROUNDING SYSTEM IN ALL

ARE COMPLETE AND FUNCTION PROPERLY. MAKE

SHALL BE THE RESPONSIBILITY OF THE ELECTRICAL

14. ALL JUNCTION BOX COVER PLATES FOR BRANCH CIRCUIT

FOR IMPROVEMENTS SPECIFIED, DETAILED OR SHOWN AS

ATTENTION BEFORE CONSTRUCTION BEGINS.

CHARACTER AS SIMILAR CONDITIONS THAT ARE SHOWN.

SHALL BE ON THE SITE BY GENERAL CONTRACTOR, AND

EACH SUB-CONTRACTOR BEFORE THE WORK BEGINS. ALL

THE REPRESENTATION OF PHYSICAL PLACEMENT OF

OR IMPLIED, AS TO THE ACCURACY OF THESE

OUTSIDE BARRICADES.

THE CONTRACT.

CONTRACT.

ALL CONDUITS.

CONSTRUCTION.

"PROVIDED BY OTHERS".

OWNER INSPECTOR.

CONDUITS/RACEWAYS.

OPERATION.

CONSULT WITH THE OWNER AUTHORIZED REPRESENTATIVE 23. DURING CONSTRUCTION, THE CONTRACTOR SHALL MAINTAIN

- 24. ANY SUBMITTALS FOR EQUIPMENT DIFFERENT FROM THE 25. SPECIFIED ITEMS SHOWN ON THE PLANS SHALL BE 26. ACCOMPANIED BY CUT SHEETS FOR THE ORIGINAL TRAFFIC AREAS, THE CONTRACTOR SHALL PROVIDE TRAFFIC 27. SPECIFIED ITEM(S). SUBMITTALS WITHOUT THE SPECIFIED 28. CUT SHEETS WILL BE REJECTED AS INCOMPLETE.
- WIDE WITH STAND AND TIED TOGETHER END TO END WITH A 29. "PROVIDE" SHALL BE DEFINED AS: FURNISH AND INSTALL
- 30. ALL MATERIALS, EQUIPMENT, CONDUIT AND WIRING SHALL BE NEW AND PROVIDED BY THE CONTRACTOR. REFER TO THE PLANS FOR ADDITIONAL REQUIREMENTS FOR EQUIPMENT EXISTING UNDERGROUND CONDUITS HAS BEEN DEVELOPED AND MATERIAL APPROVED FOR USE UNDER THIS CONTRACT.
- ALL DIMENSIONS AND ELEVATIONS SHALL BE CHECKED AND VERIFIED ON THE SITE BY THE GENERAL CONTRACTOR AND EACH SUBCONTRACTOR BEFORE THE WORK BEGINS. ALL PERCEIVED ERRORS, OMISSIONS AND DISCREPANCIES SHALL PROVIDE A GUARANTEE OR WARRANTY IN ANY WAY EXPRESS BE BROUGHT TO THE ENGINEER'S ATTENTION BEFORE CONSTRUCTION BEGINS.
- ACCURATE "AS BUILT" DRAWINGS AFTER THE COMPLETION OF32. PROVIDE ELECTRICAL PANELS WITH TYPEWRITTEN "AS-BUILT" PANEL SCHEDULE. PANEL SCHEDULE SHALL INCLUDE LOCATION, QUANTITY AND TYPE OF DEVICES SERVED. PANEL SCHEDULE SHALL BE REVISED AS REQUIRED TO REFLECT REMOVED OR DEMOLISHED CIRCUITS.
- THE SEISMIC ANCHORAGE OF ELECTRICAL EQUIPMENT SHALL REFER TO THE PLANS FOR ADDITIONAL REQUIREMENTS AND 33. CONFORM TO C.C.R. 2007 CHAPTER 16 AND ASCE 7-05 CHAPTER 13.
- PRIOR TO PULLING ANY CONDUCTORS, CLEAN AND MANDREL 34. CONTRACTOR SHALL SUBMIT A CALCULATIONS AND DETAILS FOR APPROVAL WHEN USING AN INSTALLATION METHOD NOT COVERED UNDER ANY OF THE STRUCTURAL DRAWINGS STANDARD DETAILS.
 - 35. ALL WORK SHALL BE DONE IN ACCORDANCE WITH LATEST APPLICABLE CODES AND REGULATIONS PER CALIFORNIA AND OTHER AUTHORITIES HAVING JURISDICTION.
 - 36. ALL MATERIALS, EQUIPMENT, CONDUIT AND WIRING SHALL BE NEW AND PROVIDED BY THE CONTRACTOR. REFER TO THE SPECIFICATIONS FOR ADDITIONAL REQUIREMENTS FOR EQUIPMENT AND MATERIAL APPROVED FOR USE UNDER THIS CONTRACT.
 - 37. WIRING FOR ALL LOW VOLTAGE SYSTEMS SHALL BE ENCLOSED IN CONDUIT AND/OR RACEWAY.
 - 38. ALL DIMENSIONS AND ELEVATIONS SHALL BE CHECKED AND VERIFIED ON THE SITE BY THE GENERAL CONTRACTOR AND EACH SUBCONTRACTOR BEFORE THE WORK BEGINS. ALL PERCEIVED ERRORS, OMISSIONS AND DISCREPANCIES SHALL BE BROUGHT TO THE ENGINEER'S ATTENTION BEFORE CONSTRUCTION BEGINS.
- NEW WORK, AND ASSUMES NO RESPONSIBILITY FOR OTHER 39. ALL RACEWAYS INSIDE OF BUILDING SHALL BE CONCEALED INCLUDE ALL REQUIRED DEMOLITION, CUTTING, PATCHING AND FINISH TO MATCH EXISTING INSTALLATION AS REQUIRED TO INSTALL NEW CONDUIT AND RACEWAYS IN EXISTING BUILDING.
- CONTRACTOR. ALL REMOVED EQUIPMENT NOT TO BE REUSED40. ALL CONDUIT PENETRATIONS THROUGH FIRE-RATED FLOOR SLABS, SHAFTS AND WALLS SHALL BE SEALED AGAINST THE SPREAD OF FIRE OR SMOKE WITH APPROVED CABLE & CONDUIT FIRE STOPS OR FIRE RESISTANT SEALANT TO GIVE THE EQUIVALENT FIRE RATING OF THE STRUCTURE BEFORE THE PENETRATION. ALL OTHER NON-RATED PENETRATIONS OF STRUCTURES SHALL BE SEALED.
 - 41. EXPOSED AND CONDUITS ABOVE T-BAR CEILINGS SHALL BE INSTALLED PARALLEL TO OR AT RIGHT ANGLES TO EXISTING BEAMS OR WALLS. EXPOSED CONDUITS UP TO 7'-0" ABOVE FINISH FLOOR SHALL BE RIGID GALVANIZED STEEL AND ABOVE 7'-0" MAY BE EMT.
- THAT THE ELECTRICAL COMPONENTS AND SPECIAL SYSTEMS 42. PROVIDE ELECTRICAL PANELS WITH TYPEWRITTEN "AS-BUILT" PANEL SCHEDULE. PANEL SCHEDULE SHALL INCLUDE LOCATION, QUANTITY AND TYPE OF DEVICES SERVED.
 - 43. PROVIDE ELECTRICAL PANELS WITH ENGRAVED NAMEPLATE ON OUTSIDE OF PANEL ABOVE DOOR OPENING.

WHENEVER POSSIBLE. COORDINATE LOCATION AND LAYOUT 44. SUPPORT CONDUIT 2-1/2 INCH TRADE SIZE OR SMALLER WITH

- U.L. LISTED CLAMPS AND HANGERS IN ACCORDANCE WITH SMACNA STANDARDS.
- 45. EQUIPMENT SPECIFIED ON THESE DRAWING ARE BASIS OF DESIGN
- 46. CONTRACTOR SHALL ASSUME FULL RESPONSIBILITY FOR ALL ADDITIONAL DESIGN AND CONSTRUCTION COSTS INCURRED BY THE USE OF ANY PRODUCT OTHER THAN THE BASIS OF DESIGN.
- 47. PROVIDE BREAKERS TIES TO BREAKERS FEEDING MULTI WIRE RUNS.
- 48. THESE PLANS ARE DIAGRAMMATIC, CONDUIT EXACT ROUTING, BOXES, FASTENERS, ETC. ARE CONSIDERED AS PART OF THE MEANS AND METHODS THAT THE CONTRACTOR IS USING TO PROVIDE AN OPERABLE AND APPROVED INSTALLATION
- 49. ALL ELECTRICAL WORK SHALL BE DESIGNED PER 2017 LOS ANGELES COUNTY ELECTRICAL CODE, 2016 CALIFORNIA ELECTRICAL CODE. 2014 NATIONAL ELECTRICAL CODE AND SHALL BE COPPER, TYPE THWN/THHN, RATED FOR 75°C. SIZES 2016 BUILDING ENERGY EFFICIENCY STANDARDS.
 - 50. 110.2 APPROVAL: ALL ELECTRICAL EQUIPMENT SHALL BE LABELED, LISTED OR CERTIFIED BY A NATIONALLY RECOGNIZED TESTING LABORATORY ACCREDITED BY THE UNITED STATES OCCUPATIONAL SAFETY HEALTH ADMINISTRATION.
 - 51. 130.5(c) VOLTAGE DROP: THE MAXIMUM COMBINED VOLTAGE DROP ON BOTH INSTALLED FEEDER CONDUCTORS AND BRANCH CIRCUIT CONDUCTORS TO THE FARTHEST CONNECTED LOAD OR OUTLET SHALL NOT EXCEED 5 PERCENT.

STANDARD ABBREVIATIONS

A.F.F. ABOVE FINISHED FLOOR A OR AMP **AMPERES** ASPHALT CONCRETE BKR BREAKER BC **BARE COPPER** CONDUIT CKT. CIRCUIT C.O. **CONDUIT ONLY** (E) **EXISTING**

(ER) EXISTING, RELOCATED F.O. FIBER OPTIC GFI,G.F. GROUND FAULT INTERRUPTER

J.BOX **JUNCTION BOX** IDF INTERMEDIATE DISTRIBUTION FRAME

(COMPUTER/NETWORKING SYSTEM) LOCAL DISTRIBUTION FRAME (COMPUTER/NETWORKING SYSTEM) MDF MAIN DISTRIBUTION FRAME

(COMPUTER/NETWORKING SYSTEM)

MOUNTING HEIGHT M.H. (N) N.I.C. **NOT IN CONTRACT PUBLIC ADDRESS**

PH OR Ø PHASE (RR) REMOVE AND RELOCATE (R) **REMOVED** REV. REVISED

RSP

SLC

SW SWITCH XFMR TRANSFORMER **TVSS** TRANSIENT VOLTAGE SURGE SUPPRESSER

REMOTE SECURITY PANEL

SIGNALING LINE CIRCUIT

TYP. **TYPICAL** UFER **UFER GROUND** UG **UNDERGROUND** U.O.N. **UNLESS OTHERWISE NOTED** WM WIREMOLD

WP **WEATHERPROOF** W.P. **WEATHERPROOF** V.L. VERIFY LOCATION.

SHEET INDEX

E1.1 | ELECTRICAL FRONT SHEET E1.2 | ELECTRICAL SINGLE LINE DIAGRAM, PANEL SCHEDULES AND LOAD CALCULATION

E1.3 | ELECTRICAL LIGHT FIXTURE SCHEDULE E2.1 | ELECTRICAL SITE LIGHTING, POWER AND ACCESS PLAN

E2.2 | ELECTRICAL POWER AND ACCESS FLOOR PLAN E3.1 ELECTRICAL SITE PHOTOMETRIC CALCULATIONS

ELECTRICAL TITLE-24 COMPLIANCE FORMS - OUTDOOR E4.1

E4.2 | ELECTRICAL LIGHTING CONTROL DIAGRAM E5.1 | ELECTRICAL DETAILS

La Cañada Design Group **Architecture** Planning Interiors 630 N. Rosemead Boulevard, Ste 400 Pasadena, California 91107 (626) 351-4301 FAX (626)351-4302 An MBEISBEIDBEILSBE Firr Glendale|Downtown LA|Camarillo W W W . B U D L O N G . C O N JOB# - 23-010 Registration Client Name: **COUNTY OF LOS ANGELES PUBLIC WORKS** Project Title: DEPARTMENT OF ANIMAL CARE AND CONTROL **HEADQUARTERS FENCING PROJECT** Project Address: SPEC #: 7856

INTERIM REVIEW DOCUMENTS

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Revisions No. Description

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Plot date: Jul 02,2024 - 12:02PM

ELECTRICAL

Sheet Number


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LCDG Job Number:

Sheet Title

FRONT SHEET

	KEY NOTES
1	PROVIDE NEW PANELBOARD. REFER TO PANEL SCHEDULE.
2	PROVIDE NEW MC CABLE. REFER TO FLOOR PLAN FOR ROUTING OF MC CABLE.
3	PROVIDE NEW CIRCUIT BREAKER ON SPACE AVAILABLE.

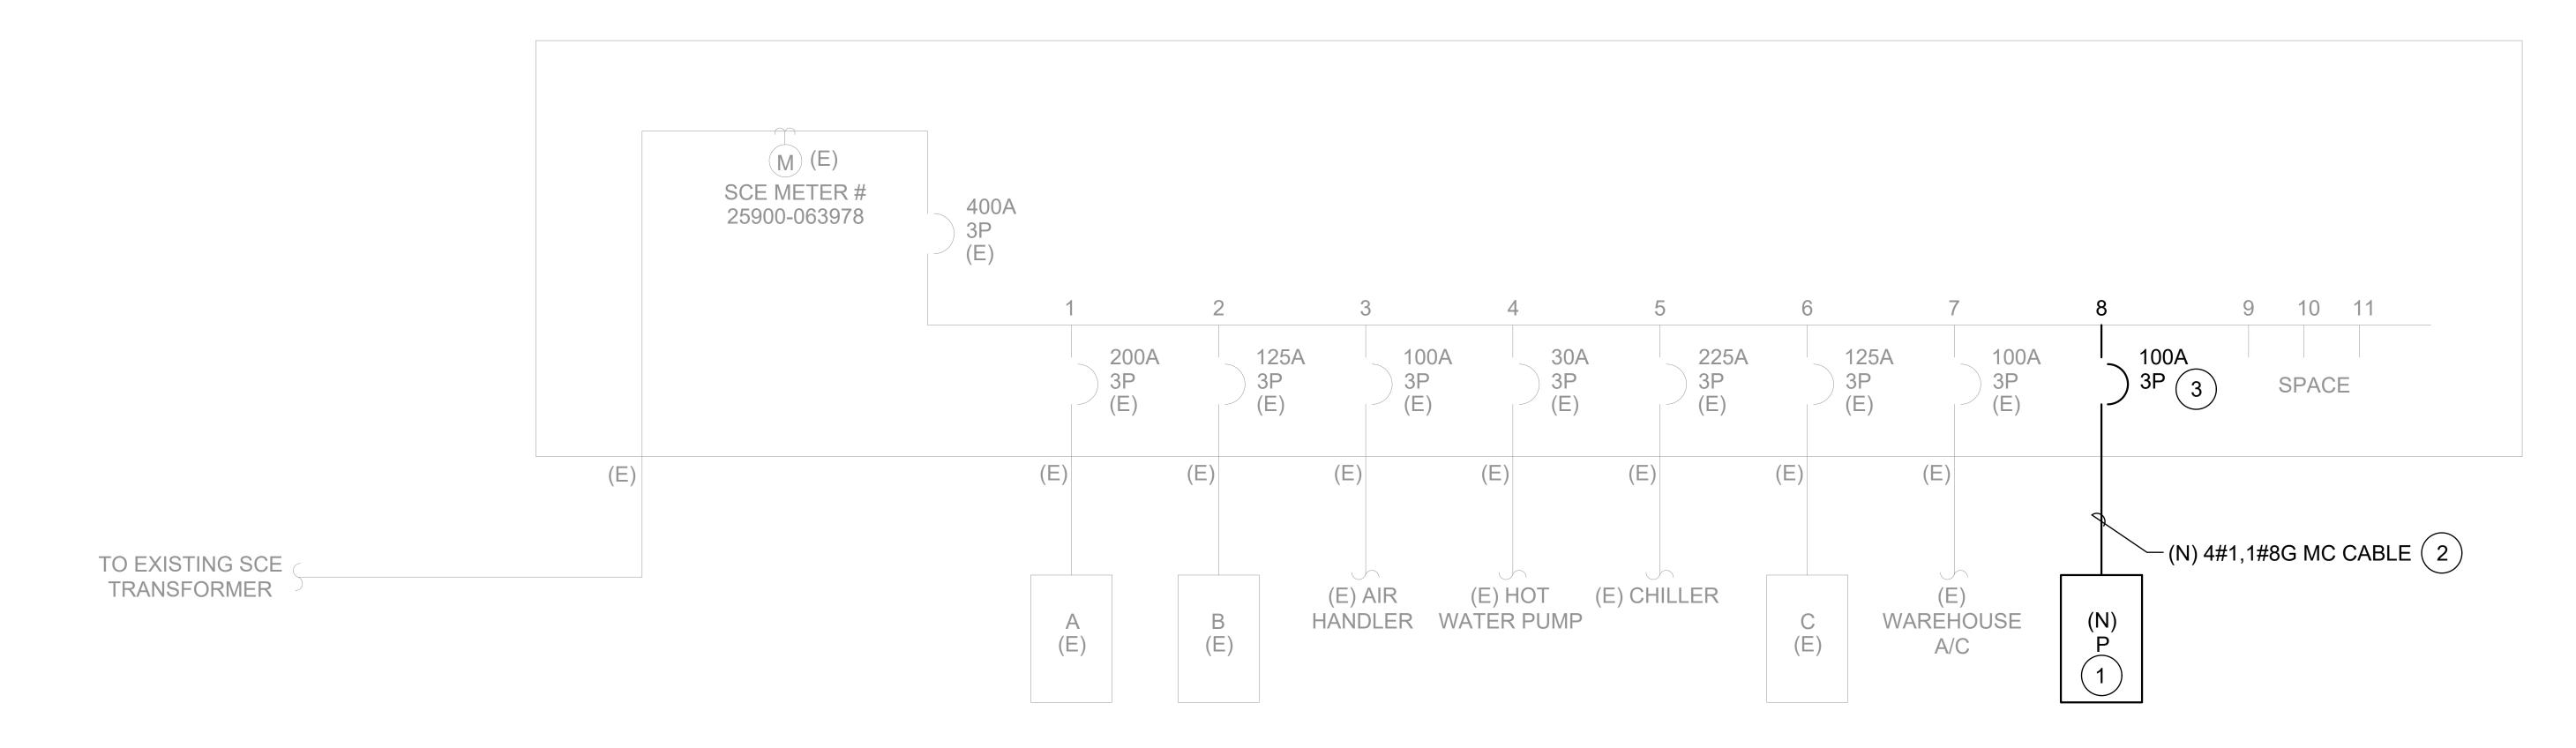

LOAD CALCULATION

(E) MAIN SWITCHBOARD-MS 400A, 208/120V 3 PHASE, 4W

EXISTING LOAD (PEAK DEMAND PER 12 MONTH BILLING)

86 KW X 1.25 = 107.5KW

= 298.6 AMPS

NEW ADDITIONAL LOAD

1. ACCESS GATE = 19.4 AMPS

2. PARKING LIGHTING = 1.7 AMPS

TOTAL NEW LOAD

= 21.1 AMPS

TOTAL DEMAND LOAD = 298.6 AMPS + 21.1 AMPS

= 319.7 AMPS

THEREFORE THE (E) 400A MAIN SWITCHBOARD IS SUFFICIENT ENOUGH TO HANDLE THE ADDITIONAL LOAD

)	4N	EL	: P		1	20	/2	08	V	OL	_T,	3	P	Η,	4	W 100 AM	P CC	PPE	RB	US
O	CAT	TION:					(PAN	EL TO) H/	AVE B	OLT-O	N BI	REAK	ERS)		MAIN	l: LUC	GS ON	۱LY
0	UNTI	NG:	SURFA	CE FLU	SH STANDING											LOAD:	2.4	kVA	19	AMPS
	NT LI		/A LOAD	LINE C	LOAD DESCRIPTION	0	UTLE R		CKT	T BKR	СКТ	BKR P	-	JTLE R	TS O	LOAD DESCRIPTION		/A LOAD		CK NT #
		1116			1 HP/115V GATE OPERATOR MOTOR (VD = 2.52% @ 9.70A, 150 FT, #10AWG)				1	20	20	1				1 HP/115V GATE OPERATOR MOTOR (VD = 3.17% @ 9.70A, 300 FT, #8AWG)	1116			2
			204		SITE LIGHTING (VD = 1.33% @ 1.70A, 450 FT, #10AWG)			6	1	20	20					SPARE				4
ļ					SPARE	<u> </u>			1	20	20	_				SPARE				6
L					SPARE				1	20	20	1				SPARE				8
					SPARE				1	20	20	1				SPARE				10
					SPARE				1	20	20	1				SPARE				12
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		1116	204	0	SUB - TOTALS			<u> </u>			<u> </u>				,	SUB - TOTALS	1116	0	0	
)	E: 1.															LINE TOTALS:	2232	204	0	
	2.															LCL ADDER	0	0	0	
	3.															TOTAL VA PER PHASE	2232	204	0	
	4.															LINE AMPS	19	2	0	



630 N. Rosemead Boulevard, Ste 400 Pasadena, California 91107 (626) 351-4301 FAX (626)351-4302



Interiors

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CD 9	0%	1/9/24
BAC	CHECK 1	7/2/24
Revis	sions	
No.	Description	Date
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Drawn by ZR
Reviewed by VD

Plot date: Jul 02,2024 - 12:03PM

Sheet Title

ELECTRICAL
SINGLE LINE
DIAGRAM/PANEL
SCHEDULES
& LOAD
CALCULATION

Sheet Numbe

J:\23-010 LCDG P-1984 LAC DACC - Parking Lot Refurbishment\E\23-010 E1.2 ELECTRICAL SINGLE LINE DIAGRAM AND PANEL SCHEDULES AND LOAD CALCULATION.dwg

E1.2

				LIGHTII	NG FIX	TURE	SCHEE	DULE	
			SOURCE		SYSTEM				
			COLOR TEMP		INPUT				
TYPE	MANUFACTURER & MODEL NUMBER	MOUNTING	LUMENS	WATTS	WATTS	VOLTAGE	DIMMING	DESCRIPTION	NOTES
_			3000K CCT 4869						

GENERAL NOTES:

- 1 PROVIDE ALL LIGHTING FIXTURES AS SHOWN COMPLETE WITH LAMPS, WIRED, CONTROLLED AND SECURELY ATTACHED TO SUPPORTS.
- 2 PROVIDE UL LISTED DRIVERS OR SCOKETS WITH MANUFACTURER LABEL LISTED PER THE INPUT SYSTEM WATTS AS INDICATED ON THE LIGHTING FIXTURE SCHEDULE.
- 3 THE LIGHTING FIXTURES AND WORKMANSHIP SHALL BE IN ACCORDANCE WITH THE STANDARDS AND REGULATIONS OF THE FOLLOWING:
 - A. UNDERWRITERS LABORATORIES (UL)
 - B. CALIFORNIA ELECTRICAL CODE (CEC)
 - C. LOCAL BUILDING AND LIFE SAFETY CODE AGENCIES.
 - D. LM-79-08, LM-80-08, TM-21-11, AND TITLE 20 LISTED
- 4 ALL FIXTURES AND WORKMANSHIP SHALL BE GUARANTEED FREE OF DEFECTS AND FULLY OPERATIONAL. ANY FIXTURES OR WORKMANSHIP FOUND TO BE DEFECTIVE DURING THE WARRANTY PERIOD WILL BE EITHER FIXED OR REPLACED BY THE CONTRACTOR AT NO COST TO THE OWNER.
- 5 PROVIDE ADEQUATE AND STURDY SUPPORT FOR EACH LIGHTING FIXTURE OR POLE LIGHT ASSEMBLY. CONTRACTOR SHALL BE RESPONSIBLE FOR VERFYING THE WEIGHT AND MOUNTING METHOD OF ALL FIXTURES AND FURNISH AND INSTALL SUITABLE SUPPORTS OR BASE FOOTINGS. FIXTURE MOUNTING ASSEMBLIES SHALL COMPLY WITH ALL LOCAL SEISMIC CODES AND REGULATIONS.

 NOTE: CONTRACTOR SHALL REFER TO ARCHITECTURAL OR STRUCTURAL DRAWINGS FOR FOOTING REQUIREMENTS.
- 6 PROVIDE ALL LIGHT FIXTURES EQUIPPED WITH COMPATIBLE DIMMING DRIVERS PER THE LIGHTING CONTROLS SYSTEM.
- 7 PROVIDE UL924 DEVICES FOR ALL EMERGENCY FIXTURES. ALL LIGHTING FIXTURES EQUIPPED WITH EMERGENCY BATTERY BACK-UP SHALL BE PROVIDED WITH A UN-SWITCHED HOT WIRE PER MANUFACTURER DIRECTIONS.
- 8- AT THE COMPLETION OF CONSTRUCTION, CONTRACTOR SHALL CLEAN LENSES AND REFLECTORS OF ALL LIGHT FIXTURES SO AS TO RENDER THEM FREE OF ANY MATERIAL, SUBTANCE OR FILM FOREIGN TO THE FIXTURE. BLEMISHED, DAMAGED OR UNSATISFACTORY FIXTURES SHALL BE REPLACED IN A SATISFACTORY MANNER.
- 9 CONTRACTOR SHALL CONFIRM ALL LIGHT FIXTURE VOLTAGES WITH LIGHTING PLANS AND LIGHTING PANEL SCHEDULES.
- 10 PROVIDE ALL FINISHES FOR ALL LIGHT FIXTURES PER THE ARCHITECTS FINAL SELECTION.



630 N. Rosemead Boulevard, Ste 400 Pasadena, California 91107 (626) 351-4301 FAX (626)351-4302



Registration

Client Name:
COUNTY OF LOS ANGELES PUBLIC WORKS
Project Title:
DEPARTMENT OF
ANIMAL CARE AND

HEADQUARTERS
FENCING PROJECT
Project Address:
5898 Cherry Ave.,
Long Beach, CA 90805

CONTROL

SPEC #: 7856

INTERIM REVIEW DOCUMENTS

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 Milestones
 Date

 CD 50%
 9/25/23

 CD 90%
 1/9/24

 BACK CHECK 1
 7/2/24

Revisions
No. Description

Reviewed by VD
Plot date: Jul 02,2024 - 12:04PM

LCDG Job Number:


Sheet Title

ELECTRICAL LIGHTING FIXTURE SCHEDULE

Sheet Number

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E1.3




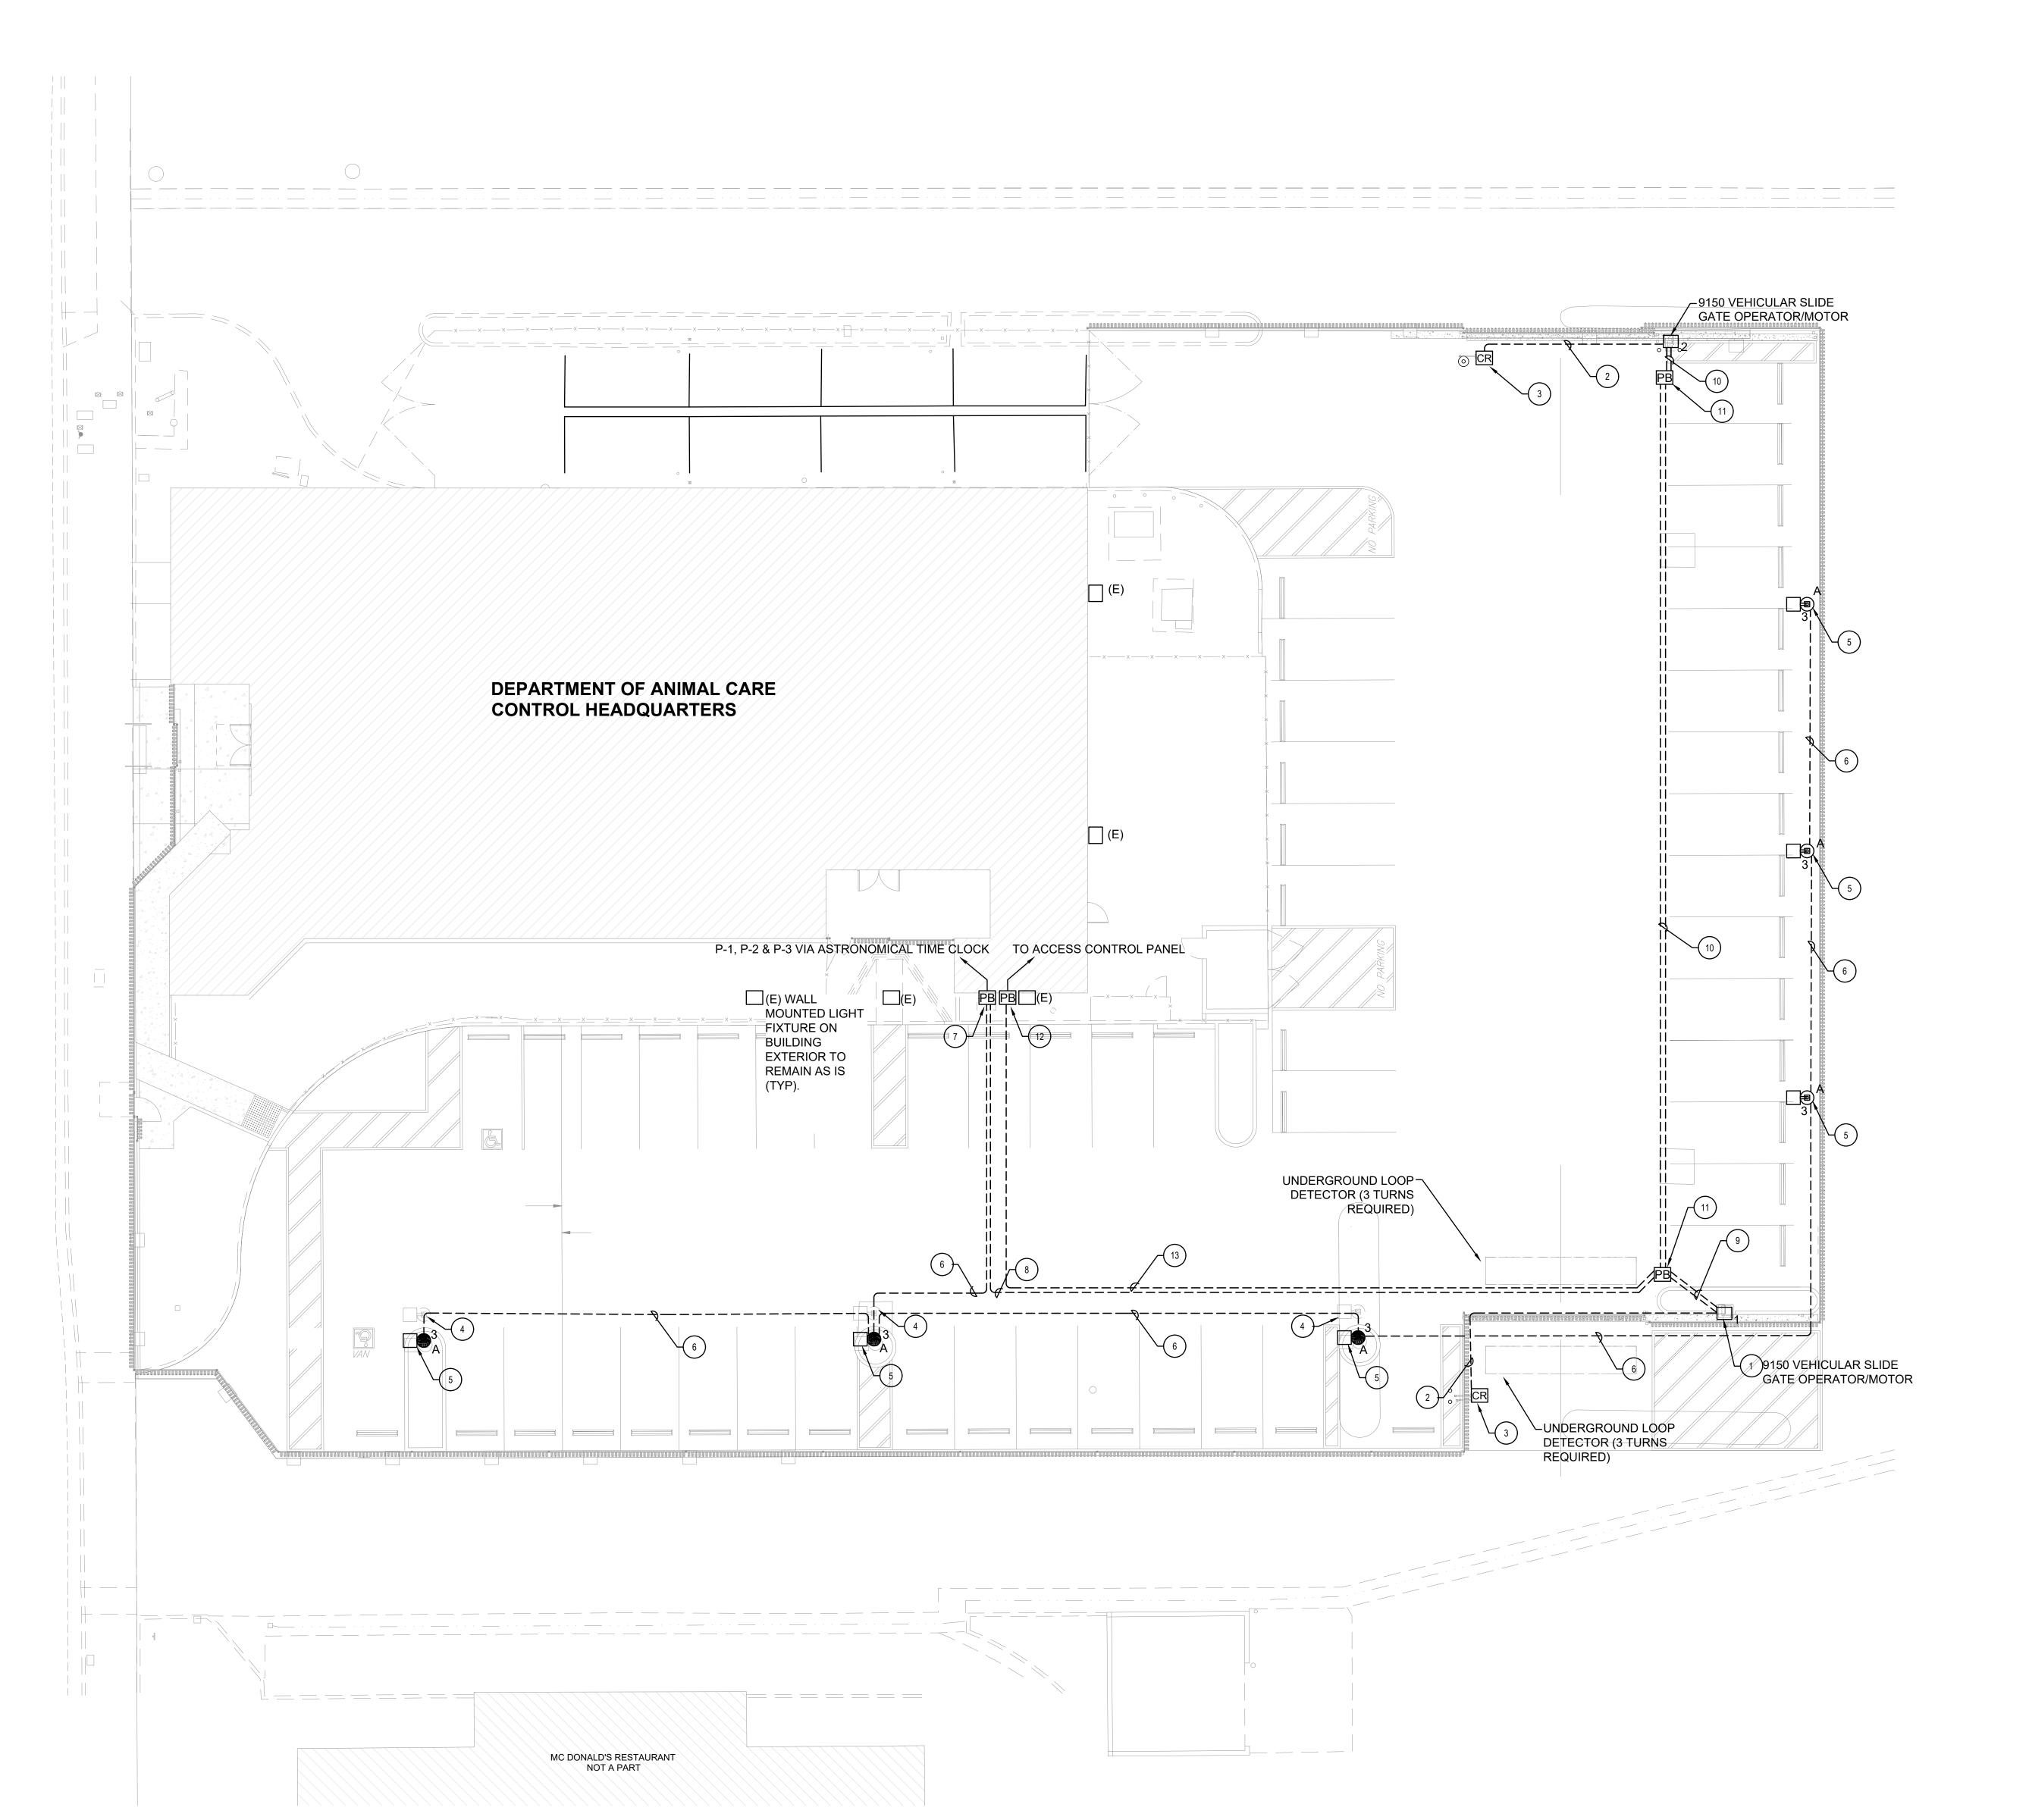

- FUNCTION AS REQUIRED PER PROJECT.
- 2) MINIMUM 1-1/4" U.G. CONDUIT FROM GATE MOTOR TO PEDESTAL ACCESS CONTROL EQUIPMENT WITH NEW CABLING AS REQUIRED FOR COMPLETE CONNECTIONS AND
- PROVIDE CARD READER TYPE HID SIGNO READER 40
 MOUNTED ON GOOSENECK PEDESTAL TYPE DOOR KING STANDARD PAD-MOUNT WITH IN-GROUND MOUNT 1200-046 ADAPTER FOR 5X5 BASE PLATE TO MATCH GATE OPERATOR SYSTEM AS REQUIRED PER PROJECT FOR A COMPLETE WORKING SYSTEM.
- FURNISH AND INSTALL NEW POLE MOUNTED LED LIGHT FIXTURE - TYPE VISIONAIRE #RLX-1-T4-32LC-3-3K-UNV- WITH COMPATIBLE 20' POLE AND NEW CONCRETE POLE BASE. SEE ELECTRICAL DETAILS AND DETAIL #11 ON SHEET C4.01 FOR MORE INFORMATION.
- 1" C WITH 2#10&1#10G FOR NEW POWER CIRCUIT TO SITE LIGHTING. SEE FLOOR PLAN FOR SOURCE PANEL AND ASTRONOMICAL TIME CLOCK LOCATIONS, SEE PANEL
- PROVIDE ELECTRICAL 10"X10"X8" DEPTH NEMA 3R PULL BOX MOUNTED ON BUILDING EXTERIOR WITH CONDUIT SLEEVE INTO BUILDING FOR NEW POWER CIRCUITS. SEE FLOOR PLAN FOR SOURCE PANEL LOCATION.
- POWER CIRCUIT. SEE PANEL SCHEDULE AND ELECTRICAL DETAILS FOR MORE INFORMATION. PROVIDE 1" CONDUIT FOR ACCESS CONTROL CABLING TO GATE OPERATOR AND CARD READER.
- POWER CIRCUIT. SEE PANEL SCHEDULE AND ELECTRICAL DETAILS FOR MORE INFORMATION. PROVIDE 1" CONDUIT FOR ACCESS CONTROL CABLING TO GATE OPERATOR AND CARD
- 11) UNDERGROUND 24"X24"X36" ELECTRICAL PULL BOX. SEE
- 12) PROVIDE ELECTRICAL 10"X10"X8" DEPTH NEMA 3R PULL BOX MOUNTED ON BUILDING EXTERIOR WITH CONDUIT SLEEVE INTO BUILDING FOR ACCESS CONTROL CABLING. SEE FLOOR PLAN FOR ACCESS CONTROL PANEL LOCATION.
- 1"C FOR ACCESS CONTROL CABLING TO BOTH GATE OPERATORS AND CARD READERS FROM PULL BOX MOUNTED ON BUILDING EXTERIOR.

GENERAL NOTES

1. CONTRACTOR TO PROVIDE DEMOLITION, INSTALLATION AND MINIMAL DISRUPTION TO MCDONALDS AND OTHER BUSINESSES DURING THE CONSTRUCTION PHASE.

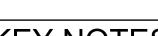

- (1) CONTRACTOR TO PROVIDE REQUIRED CABLING AND CONNECTIONS FROM GATE MOTOR TO NEW PEDESTAL MOUNTED KEY PAD FOR ACCESS CONTROL SYSTEM
- TERMINATIONS.
- EXISTING LIGHT AND POLE, AND CONCRETE POLE BASE TO BE DEMOLISHED. EXISTING SITE LIGHTING CIRCUIT CONDUCTORS TO BE DISCONNECTED AND REMOVED BACK TO SOURCE. EXISTING LIGHTING CONNECTED TO DEMOLISHED LIGHT FIXTURES IS TO BE MAINTAINED AND REMAIN OPERATIONAL AT ALL TIMES. EXISTING CONDUIT TO BE ABANDONED IN PLACE.
- SCHEDULE FOR MORE INFORMATION.
- (8) 2"C WITH 2#10&1#10G AND 2#8&1#8G FOR DEDICATED GATE OPERATOR POWER CIRCUITS. SEE PANEL SCHEDULE AND ELECTRICAL DETAILS FOR MORE INFORMATION.
- 1"C WITH 2#10&1#10G FOR DEDICATED GATE OPERATOR
- 1"C WITH 2#8&1#8G FOR DEDICATED GATE OPERATOR
- ELECTRICAL DETAILS #3 FOR MORE INFORMATION.

Plot date: Jul 02,2024 - 12:04PM

Architecture

630 N. Rosemead Boulevard, Ste 400

(626) 351-4301 FAX (626)351-4302

COUNTY OF LOS ANGELES PUBLIC

DEPARTMENT OF

HEADQUARTERS

FENCING PROJECT

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authorization of La Cañada Design Group.

CD 50%

CD 90%

Revisions

BACK CHECK 1

No. Description

against all damages, claims and losses arising out of any reuse of the plans and specifications without the

7/2/24

ANIMAL CARE AND

Pasadena, California 91107

An MBEISBEIDBEILSBE Firm

GlendalelDowntown LAICamarillo W W W . B U D L O N G . C O M JOB# - 23-010

Registration

WORKS

Project Title:

CONTROL

Project Address:

5898 Cherry Ave.,


SPEC #: 7856

Long Beach, CA 90805

Planning

Interiors

ELECTRICAL SITE LIGHTING, POWER AND ACCESS PLAN

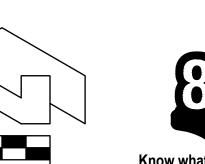




CITY OF LONG BEACH BENCHMARK NO. 1029 EL. 48.646 FT

Sheet Number

1985 ADJ.

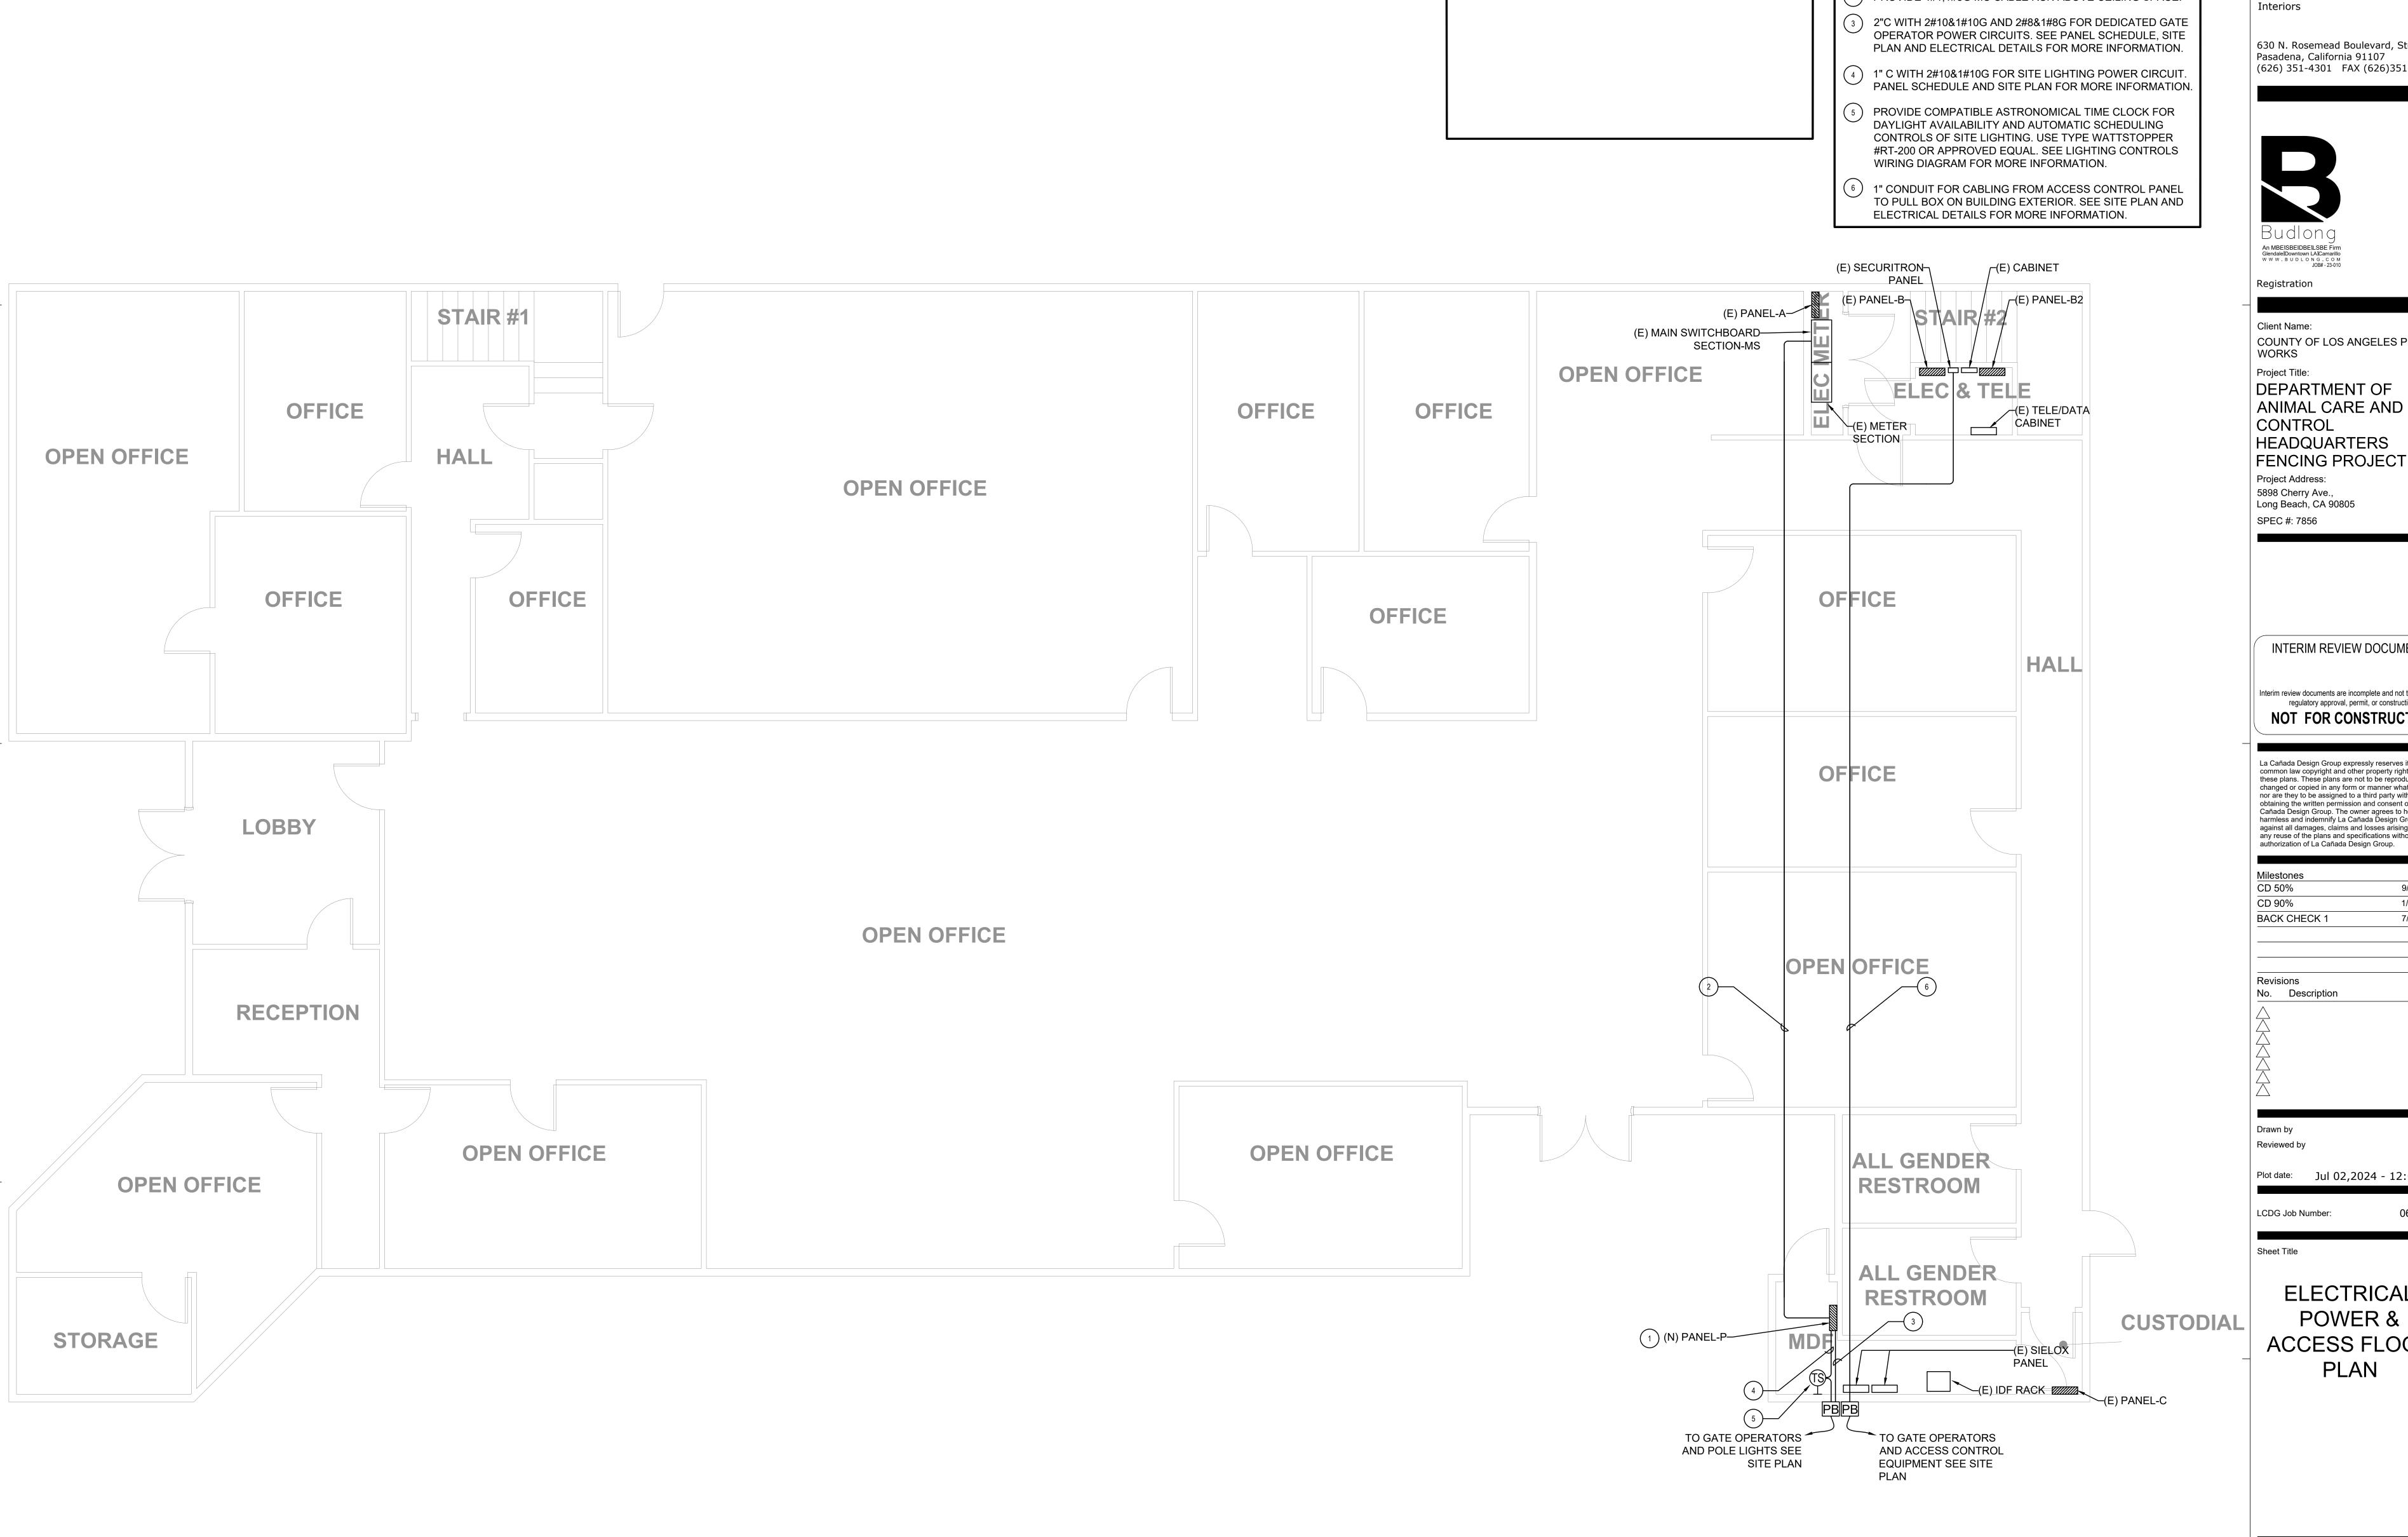

La Cañada Design Group

Architecture Planning

KEY NOTES

(1) PROVIDE NEW PANEL. REFER TO PANEL SCHEDULE ON

(2) PROVIDE 4#1,1#8G MC CABLE RUN ABOVE CEILING SPACE.

SHEET E1.2.

GENERAL NOTES

CONTRACTOR TO PROVIDE DEMOLITION, INSTALLATION AND MINIMAL

DISRUPTION TO MCDONALDS AND OTHER BUSINESS DURING THE

CONSTRUCTION PHASE.

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COUNTY OF LOS ANGELES PUBLIC DEPARTMENT OF ANIMAL CARE AND

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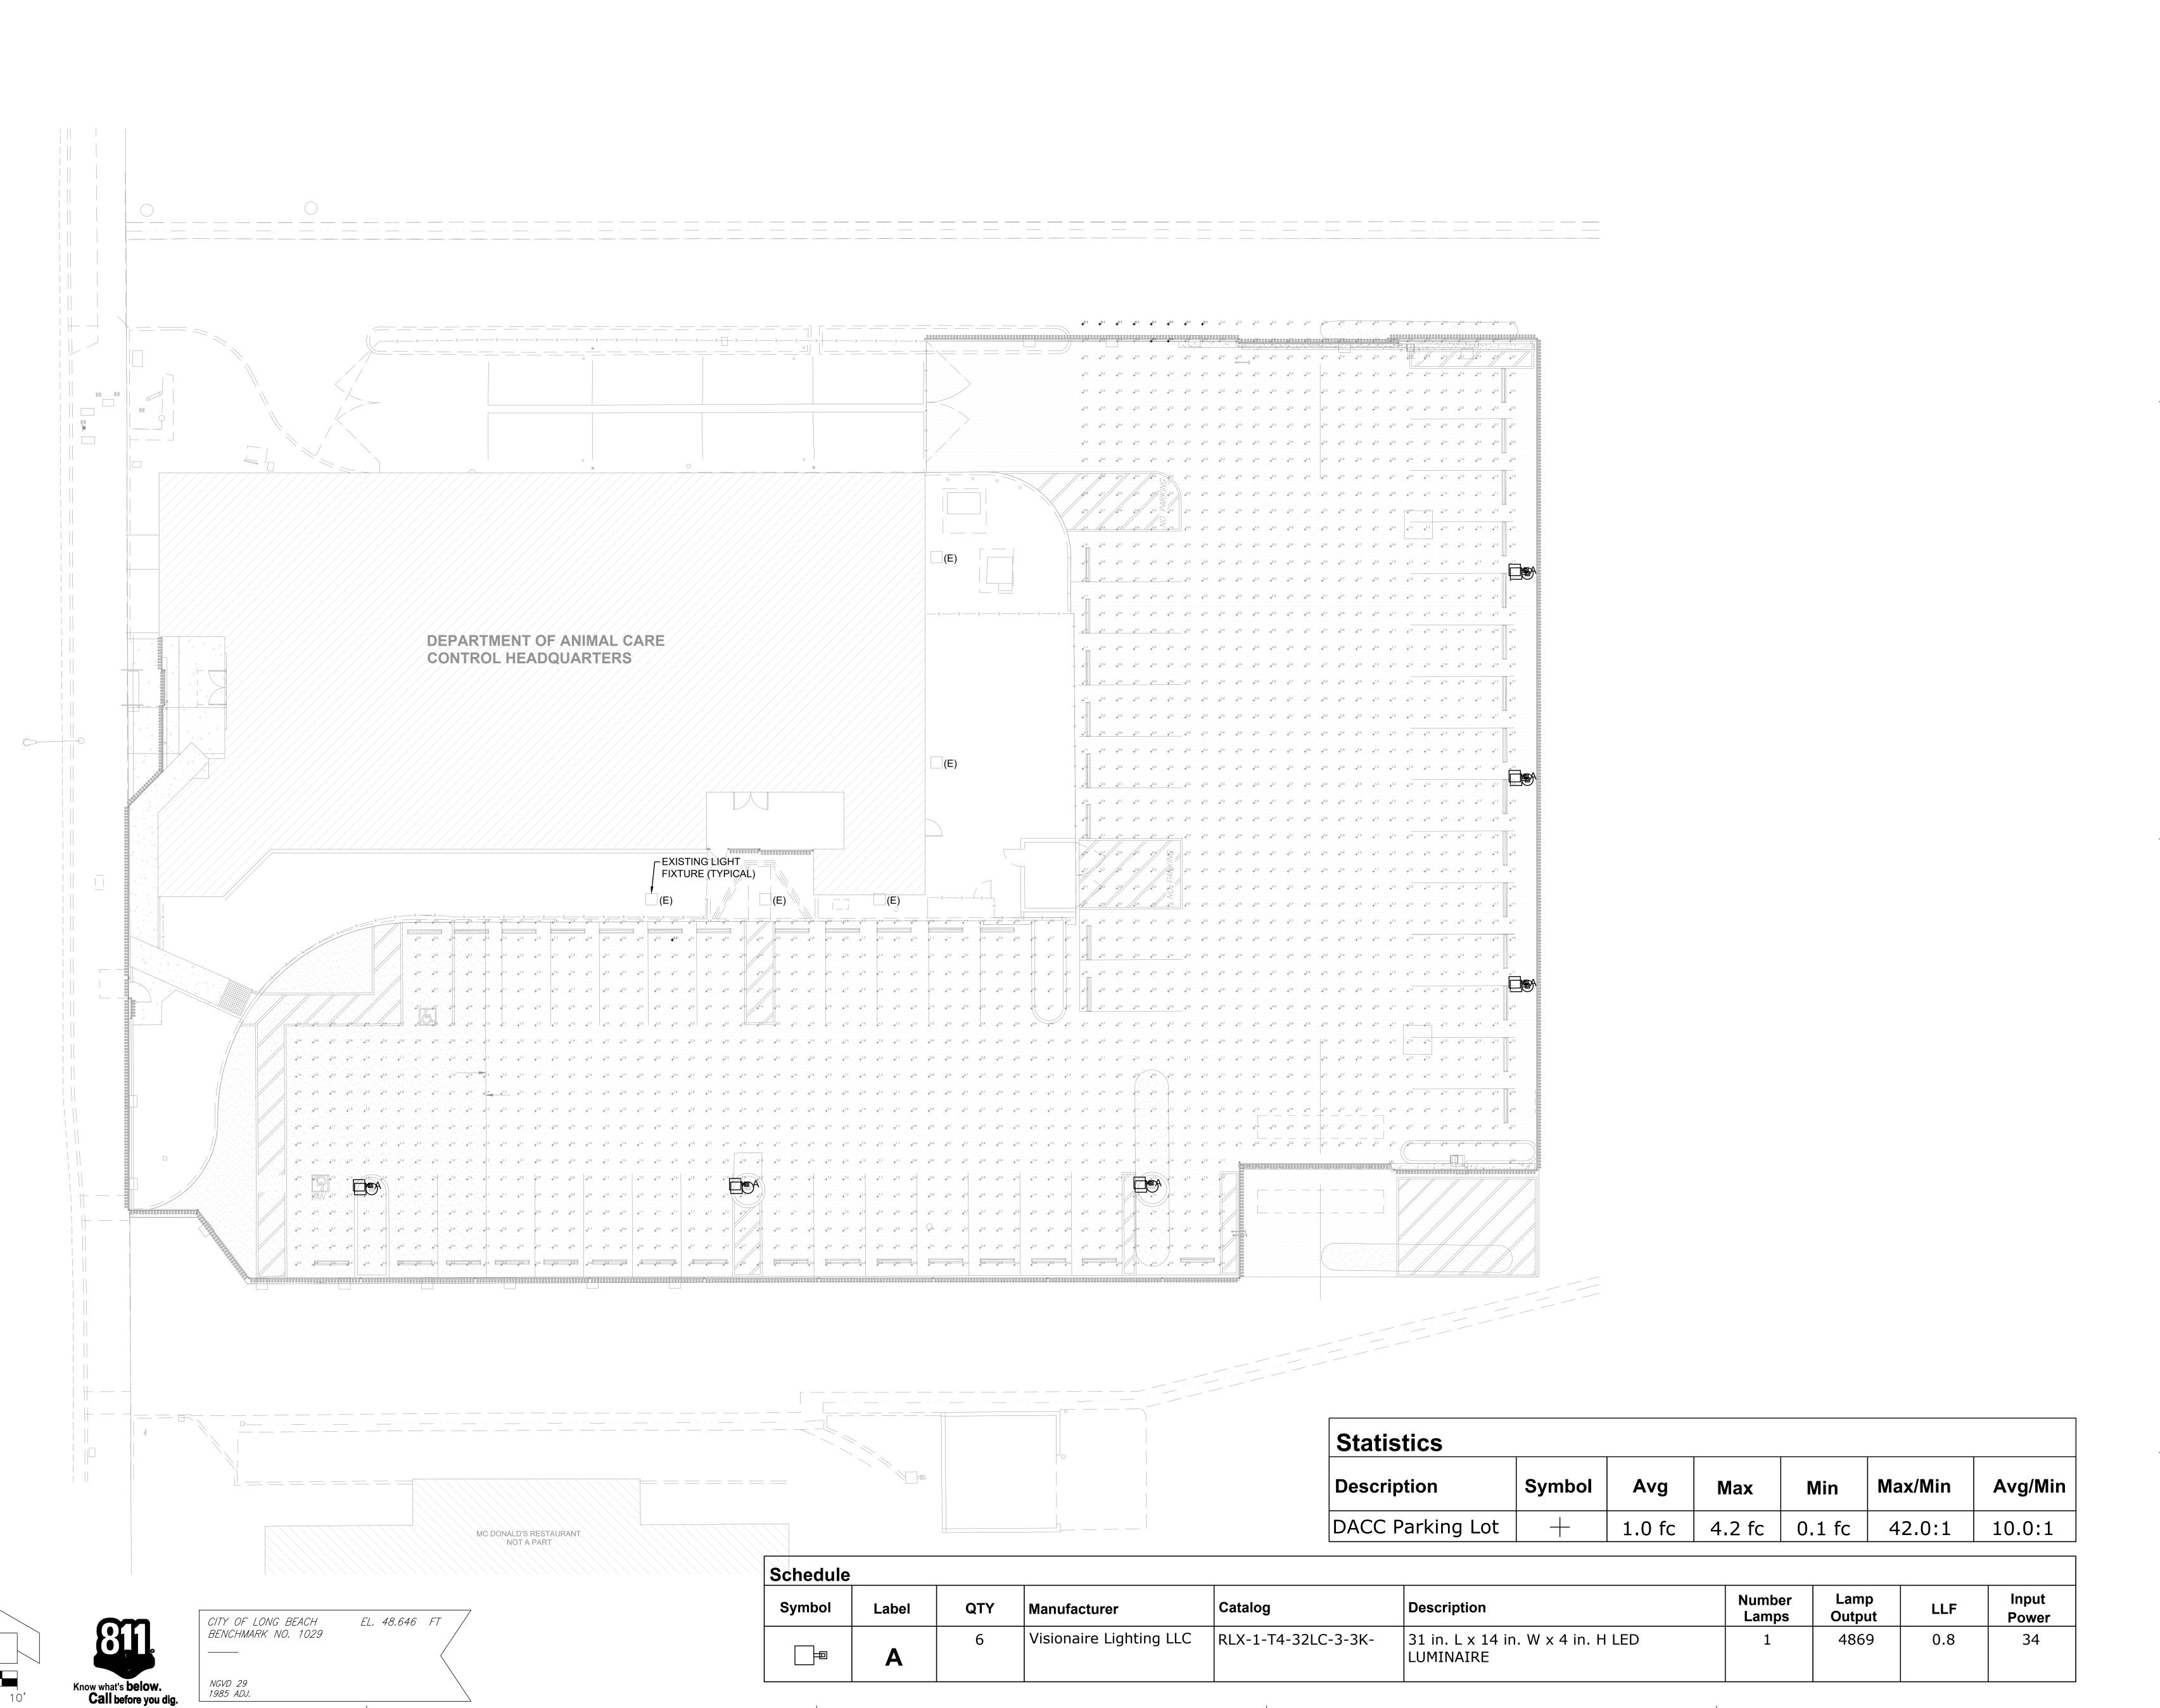
Milestones	Date
CD 50%	9/25/23
CD 90%	1/9/24
BACK CHECK 1	7/2/24

Plot date: Jul 02,2024 - 12:05PM

ELECTRICAL POWER & ACCESS FLOOR PLAN

J:\23-010 LCDG P-1984 LAC DACC - Parking Lot Refurbishment\E\23-010 E2.2 ELECTRICAL POWER AND ACCESS FLOOR PLAN.dwg

E2.2



La Cañada Design Group
Architecture
Planning
Interiors

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Registration

Client Name:
COUNTY OF LOS ANGELES PUBLIC WORKS
Project Title:
DEPARTMENT OF
ANIMAL CARE AND
CONTROL
HEADQUARTERS

Project Address: 5898 Cherry Ave., Long Beach, CA 90805 SPEC #: 7856

FENCING PROJECT

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Milestones	Date
CD 50%	9/25/23
CD 90%	1/9/24
BACK CHECK 1	7/2/24

Revisions
No. Description
Date

Drawn by

Plot date: Jul 02,2024 - 12:

LCDG Job Number:

neet Title

ELECTRICAL SITE PHOTOMETRIC CALCULATIONS

Sheet Number

J:\23-010 LCDG P-1984 LAC DACC - Parking Lot Refurbishment\E\23-010 E3.1 ELECTRICAL SITE PHOTOMETRIC CALCULAIONS NORMAL.dwg

E3.1

This document is used to demonstrate compliance with requirements in 110.9, 130.0, 130.2, 140.7, and 141.0(b)2L for outdoor lighting scopes using the prescriptive path for montresidential and hotel/motel occupancies. It is also used to document compliance with requirements in 160.5, 170.2(e)6, 180.1(a) and 180.2(b)48v for outdoor lighting scopes using the prescriptive path for multifamily and mixed-use occupancies. Multifamily includes dominative and senior living facilities. Project Name: DACC HQ Parking Lot Report Page: Project Address: S898 Cherry Ave Date Prepared: 9/2					,	CALIFORNIA ENERGY COMMISSI NRCC-LT
Project Name: DACC HQ Parking Lot S898 Cherry Ave Page: Page Page	This document is used to demonstrate complinonresidential and hotel/motel occupancies.	It is also used to	document compliance with re	quirer	ments in 160.5, 170.2(e)6, 180.1(a) and	copes using the prescriptive path for
Project Address:			,,			(Page 1 o
02 Climate Zone 6	<u> </u>	•	5898 Cherry Ave	<u> </u>		9/13/20
O1						
Oracle Project Location (city) Long Beach Oracle Illuminated Hardscape Area (ft²) 20587	A. GENERAL INFORMATION					
02 Climate Zone 6 04 Total Illuminated Hardscape Area (ft') 20587		Long Beach			1	
03 Outdoor Lighting Zone per Title 24 Part 1 10.114 or as designated by Authority Having Jurisdiction (AHJ): □ IZ-0: Very Low - Undeveloped Parkland □ IZ-2: Moderate - Urban Clusters □ IZ-4: High - Must be reviewed by CA Energy Commission for Approval □ IZ-1: Low - Rural Areas □ IZ-3: Moderately High - Urban Areas 05 Occupancy Types within Project • All Other Occupancies ■ PROJECT SCOPE This table includes outdoor lighting systems that are within the scope of the permit application and are demonstrating compliance using the prescriptive path outlined in 140.7/170.2(e)6 or 141.0(b)2L / 180.2(b)4Bv for alterations. My Project Consists of: □ 01 □ New Lighting System □ Must Comply with Allowances from 140.7 / 170.2(e)6 □ Altered Lighting System □ Is your alteration increasing the connected lighting load (Watts)? □ Yes □ No □ 03 □ 04 □ 05 □ 6 Existing Luminaires Being Altered □ Sum Total of Luminaires Being Added or Altered □ Calculation Method □ < 10% □ >= 10% and < 50% □ >= 50% □ 0	` ''	6		04	Total Illuminated Hardscape Area (ft²)	20587
IZ-0: Very Low - Undeveloped Parkland X IZ-2: Moderate - Urban Clusters IZ-4: High - Must be reviewed by CA Energy Commission for Approval IZ-1: Low - Rural Areas IZ-3: Moderately High - Urban Areas IZ-4: High - Must be reviewed by CA Energy Commission for Approval IZ-4: Low - Rural Areas IZ-4: High - Must be reviewed by CA Energy Commission for Approval IZ-4: High - Must be reviewed by CA Energy Commission for Approval IZ-4: High - Must be reviewed by CA Energy Commission for Approval IZ-4: High - Must be reviewed by CA Energy Commission for Approval IZ-4: High - Must be reviewed by CA Energy Commission for Approval IZ-4: High - Must be reviewed by CA Energy Commission for Approval IZ-4: High - Must be reviewed by CA Energy Commission for Approval IZ-4: High - Must Energy Commission for Approval IZ-4: High - Urban Areas IZ-4: High - Must Energy Commission for Approval IZ-2: Approved For Approval IZ-4: High - Urban Areas IZ-4: High - Must Energy Commission for Approval IZ-4: High - Urban Areas IZ-4: High - Urban Areas IZ-4: High - Urban Areas IZ-4:		1 10.114 or as d	esignated by Authority Having	Juriso	l diction (AHJ):	
□ IZ-1: Low - Rural Areas □ IZ-3: Moderately High - Urban Areas 05 Occupancy Types within Project • All Other Occupancies **B. PROJECT SCOPE** This table includes outdoor lighting systems that are within the scope of the permit application and are demonstrating compliance using the prescriptive path outlined in 140.7/170.2(e)6 or 141.0(b)2L / 180.2(b)4Bv for alterations. **My Project Consists of:** 01 02 □ New Lighting System					· · · ·	Energy Commission for Approval
Occupancy Types within Project All Other Occupancies B. PROJECT SCOPE This table includes outdoor lighting systems that are within the scope of the permit application and are demonstrating compliance using the prescriptive path outlined in 140.7 / 170.2 (e)6 or 141.0 (b)2L / 180.2 (b)4Bv for alterations. My Project Consists of: O1 New Lighting System Must Comply with Allowances from 140.7 / 170.2 (e)6 Altered Lighting System Is your alteration increasing the connected lighting load (Watts)? Yes No O5 W of Existing Luminaires Being Altered¹ Sum Total of Luminaires Being Added or Altered Calculation Method Calculation Method	· ·		derately High - Urban Areas	1	, ,	
■ All Other Occupancies B. PROJECT SCOPE This table includes outdoor lighting systems that are within the scope of the permit application and are demonstrating compliance using the prescriptive path outlined in 140.7 / 170.2(e)6 or 141.0(b)2L / 180.2(b)4Bv for alterations. My Project Consists of: O1 New Lighting System Must Comply with Allowances from 140.7 / 170.2(e)6 Altered Lighting System Is your alteration increasing the connected lighting load (Watts)? Yes No O5 W of Existing Luminaires Being Altered¹ Sum Total of Luminaires Being Added or Altered Calculation Method < 10% >= 10% and < 50% >= 50% 0	05 Occupancy Types within Project	<u> </u>	, с		·	
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Altered Lighting System Is your alteration increasing the connected lighting load (Watts)? O3 O4 Sum Total of Luminaires Being Added or Altered Calculation Method 3000 300	This table includes outdoor lighting systems to 170.2(e)6 or 141.0(b)2L / 180.2(b)4Bv for alte My Project Consists of:		he scope of the permit applicat	ion ar		the prescriptive path outlined in 140.7/
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¹ FOOTNOTES: % of Existing Luminaires Being Altered = (Sum Total of Luminaires Being Added or Altered / Existing Luminaires within the Scope of the Permit Application) x 100.	This table includes outdoor lighting systems to 170.2(e)6 or 141.0(b)2L / 180.2(b)4Bv for altered to 180.2(b)4Bv for altered to 180.2(b)4Bv for altered Lighting System Altered Lighting System	erations. ered ¹ >= 50%	Must Comply with Allowances Is your alteration increasing the	s from he cor 04 ires Be	02 n 140.7 / 170.2(e)6 nnected lighting load (Watts)?	Yes No
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DACC HQ Parking Lot Report Page: (Page 4 of Date Prepared: 9/13/20 Date Prepared: 9/13/20 Date Prepared: 9/13/20 Date Prepared: 9/13/20 Doubt DOTROLS Distable demonstrates compliance with controls requirements for all new or altered luminaires installed as part of the permit application. For alteration projects, luminaires which are risting to remain (ie untouched) and luminaires which are removed and reinstalled (wiring only) do not need to be included in this table even if they are within the spaces covered by e permit application. Dutdoor lighting for nonresidential buildings, parking garages and common service areas in multifamily buildings must be documented separately from outdoor lighting attached to ultifamily buildings and controlled from the inside of a dwelling unit Database of the permit application. Database over alteration projects, luminaires which are removed and reinstalled as part of the permit application. For alteration projects, luminaires which are removed and reinstalled in non-insulated ceilings are excepted from ii and iii.	DACCHO D	4	In			NRCC-LTO-
OUTDOOR LIGHTING CONTROLS It is table demonstrates compliance with controls requirements for all new or altered luminaires installed as part of the permit application. For alteration projects, luminaires which are risting to remain (ie untouched) and luminaires which are removed and reinstalled (wiring only) do not need to be included in this table even if they are within the spaces covered by e permit application. utdoor lighting for nonresidential buildings, parking garages and common service areas in multifamily buildings must be documented separately from outdoor lighting attached to ultifamily buildings and controlled from the inside of a dwelling unit andatory Controls for Nonresidential Occupancies, Parking Garages & Common Areas in Multifamily Buildings 01 02 03 04 05 Area Description Shut-Off Auto-Schedule Motion Sensor Field Inspector 130.2(c)1 / 160.5(c) 130.2(c)2 / 160.5(c) 130.2(c)3 / 160.5(c) Pass Fail Parking Lot Astronomical Timer Provided Provided Provided Provided DOTNOTE: Text has been abbreviated, please refer to Table 160.5-A to confirm compliance of light source.	roject Name: DACC HQ Par	rking Lot				(Page 4 of 7
is table demonstrates compliance with controls requirements for all new or altered luminaires installed as part of the permit application. For alteration projects, luminaires which are removed and reinstalled (wiring only) do not need to be included in this table even if they are within the spaces covered by the permit application. Sutdoor lighting for nonresidential buildings, parking garages and common service areas in multifamily buildings must be documented separately from outdoor lighting attached to ultifamily buildings and controlled from the inside of a dwelling unit Sandatory Controls for Nonresidential Occupancies, Parking Garages & Common Areas in Multifamily Buildings O1 O2 O3 O4 O5 Area Description Shut-Off Auto-Schedule Motion Sensor 130.2(c)1 / 160.5(c) 130.2(c)2 / 160.5(c) 130.2(c)3 / 160.5(c) Parking Lot Astronomical Timer Provided Provided Provided ODTNOTE: Text has been abbreviated, please refer to Table 160.5-A to confirm compliance with the specific light source technologies listed. Suthority having jurisdiction may ask for cutsheets or other documentation to confirm compliance of light source.			Date Pre	parea:		9/13/202
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Area Description Shut-Off 130.2(c)1 / 160.5(c) Pass Fail Parking Lot Astronomical Timer Provided Provided Provided Provided Provided Provided Provided Provided DOTNOTE: Text has been abbreviated, please refer to Table 160.5-A to confirm compliance with the specific light source technologies listed. Suthority having jurisdiction may ask for cutsheets or other documentation to confirm compliance of light source.				mily Buildings		
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Parking Lot Astronomical Timer Provided Provided □ □ □ COTNOTE: Text has been abbreviated, please refer to Table 160.5-A to confirm compliance with the specific light source technologies listed. uthority having jurisdiction may ask for cutsheets or other documentation to confirm compliance of light source.	Area Description				Field In	spector
OOTNOTE: Text has been abbreviated, please refer to Table 160.5-A to confirm compliance with the specific light source technologies listed. uthority having jurisdiction may ask for cutsheets or other documentation to confirm compliance of light source.		130.2(6)17 100.3(6)	130.2(0)2 / 130.3(0)	130.2(0,3 / 130.3(0)	Pass	Fail
uthority having jurisdiction may ask for cutsheets or other documentation to confirm compliance of light source.	Parking Lot	Astronomical Timer	Provided	Provided		
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Generated Date/Time:

Report Version: 2022.0.000

Schema Version: rev 20220101

Report Version: 2022.0.000

Schema Version: rev 20220101

CA Building Energy Efficiency Standards - 2022 Nonresidential Compliance

CA Building Energy Efficiency Standards - 2022 Nonresidential Compliance

Compliance ID: EnergyPro-5468-0923-0580 Report Generated: 2023-09-13 00:03:33

Documentation Software: EnergyPro

Compliance ID: EnergyPro-5468-0923-0580

Report Generated: 2023-09-13 00:03:33

CERTIFICATE OF COMPLIANCE		NRCC-LTO-E
Project Name: DACC HQ Parking Lot	Report Page:	(Page 7 of 7)
Project Address:	5898 Cherry Ave Date Prepared:	9/13/2023
DOCUMENTATION AUTHOR'S DECLARATION STATEMENT		
	assurate and samplete	
certify that this Certificate of Compliance documentation is a Documentation Author Name:	<u> </u>	
Anatoliy Shalygin	Documentation Author Signature:	
Company:	Signature Date:	
Budlong & Associates Address:	2023-09-13	
address: 315 Arden Ave	CEA/ HERS Certification Identification (if applicable):	
City/State/Zip:	Phone:	
Glendale CA 91203	(818) 638-8780	
of Title 24, Part 1 and Part 6 of the California Code of Regulations.	its, and manufactured devices for the building design or system design identified on this Certi ertificate of Compliance are consistent with the information provided on other applicable cor	
of Title 24, Part 1 and Part 6 of the California Code of Regulations. 4. The building design features or system design features identified on this Coplans and specifications submitted to the enforcement agency for approva 5. I will ensure that a completed signed copy of this Certificate of Compliance	ertificate of Compliance are consistent with the information provided on other applicable cor	ificate of Compliance conform to the requirements inpliance documents, worksheets, calculations, ble to the enforcement agency for all applicable
of Title 24, Part 1 and Part 6 of the California Code of Regulations. 4. The building design features or system design features identified on this Ceplans and specifications submitted to the enforcement agency for approva 5. I will ensure that a completed signed copy of this Certificate of Compliance inspections. I understand that a completed signed copy of this Certificate of Responsible Designer Name:	ertificate of Compliance are consistent with the information provided on other applicable cor Il with this building permit application. e shall be made available with the building permit(s) issued for the building, and made availal	ificate of Compliance conform to the requirements inpliance documents, worksheets, calculations, ble to the enforcement agency for all applicable
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	СОМ	PLIANCE													NRCC-LTO-
Project Name:	DA	CC HQ Parking L	ot			:		Re	eport	Page:		+			(Page 2 of 7
								Da	ate Pr	epared:					9/13/202
C. COMPLIAN															
			•	alculated from (uidance or see (•			hroug	h N. Note: If an	y cell	on this table says "	СОМ	PLIES with Exception	nal Conditions" refe
Calcu	ılatio	ns of Total Allo	wed	Lighting Power	· (Wa	tts) 140.7 / 170). 2 (e)	6 or 141.0(b)2	L / 18	80.2(b)4Bv			Co	mpliance Results	
01		02		03		04		05		06		07		08	09
General Hardscape Allowance 140.7(d)1 / 170.2(e)6 (See Table I)	+	Per Application 140.7(d)2 / 170.2(e)6 (See Table J)	+	Sales Frontage 140.7(d)2 (See Table K)	+	Ornamental 140.7(d)2 / 170.2(e)6 (See Table L)	+	Per Specific Area 140.7(d)2 / 170.2(e)6 (See Table M)	OR	Existing Power Allowance 141.0(b)2L / 180.2(b)4Bv (See Table N)	II	Total Allowed (Watts)	2	Total Actual (Watts)	07 must be >= 0
707	+		+		+		+		OR		=	707	2	204	COMPLIES
				Sh	ieldii	ng Compliance	(See	Table G for De	tails)						N
				C	ontro	ols Compliance	(See	Table H for De	tails)						COMPLIE
	ıto-fil		table	comments becc	iuse (of selections ma	ade o	r data entered	in tal	oles throughout	the J	form.			
This table is au	ito-fil	lled with unedit		comments becc					in tal	oles throughout	the J	form.			
This table is au	ito-fil	lled with unedit							in tak	ples throughout	the j	form.			
This table is au	ito-fil	lled with unedit									the j	form.		Documentation	n Software: EnergyPr

	COMPLIANCE							NRCC-LTO-
Project Name:	DACC HQ Parking Lot			Report Page:				(Page 5 of 7
				Date Prepared:				9/13/2023
. LIGHTING I	POWER ALLOWANCE (per 140.7 / 170	0.2(e))				,		
This table incl	udes areas using allowance calculations រុ	per 140.7 / 170.2(e,). General			01		
•	owance is per Table 140.7-A/Table 170.2-		I .		"Use it or lose it	t all that apply)		
Allowances are per Table 140.7-B /Table 170.2-S. Indicate wused to expand sections for user input. Luminaires that quallose it" allowances shall not qualify for another "Use it or loo Outdoor lighting attached to multifamily buildings and cont dwelling unit are included in Table H. and are not included in Dutdoor lighting is included here.		qualify for one of the "Use it or or lose it" allowance. controlled from the inside of a		☐ General Hardscape Allowance Table I (below)	☐ Per Application Table J	□ Sales Frontage Table K	☐ Ornamental Table L	Per Specific Area Table M
Calculated Ge	neral Hardscape Lighting Power Allowand	e per Table 140.7-	A for Nonresident	ial & Hotel/Motel	, 1			
	02	03	04	05	06	07	08	09
		Area Wattage Allowa		e (AWA)	Linea	r Wattage Allowance (LWA)		Total General
	Area Description	Illuminated Area (ft ²)	Allowed Density (W/ft ²)	Area Allowance (Watts)	Perimeter Lengt (If)	h Allowed Density (W/If)	Linear Allowance (Watts)	AWA + LWA (Watts)
	Parking Lot	20587	0.019	391.2	771	0.2	115.7	507
			0.020	1 00=:-			Entire Site (Watts):	200
							owance (LZ 0 only) ¹	
							Allowance (Watts):	707
	ALLOWANCE: PER APPLICATION oes not apply to this project.							
K. LIGHTING	ALLOWANCE: SALES FRONTAGE							
This section do	pes not apply to this project.							
	ALLOWANCE: ORNAMENTAL							
L. LIGHTING								

CERTIFICATE OF	COMPLIANCE									NRC	C-LT
Project Name:	DACC HQ Parking Lot				Report Page:		;			(Pag	e 3 o
				Date Prepared:						9/	13/2
For new or alte the spaces cove installed and re	LIGHTING FIXTURE SCHEDU ered lighting systems demonstra ered by the permit application of eplacement luminaires being in the gattached to multifamily build	ating complian are included in stalled as part	the Table below. of the project sc	For altered ligh	hting systems usi d (ie, existing lur	ing the Existing ninaires remai	Power method ning or existing	per 141.0(b)2L luminaires being	only new lumino g moved are not	aires bei include	ing ed).
lighting is inclu		migs and contr	oned from the m	isiae oj a aweiii	ing anne are mera	aca III Table II.	and are not me			y outuo	
Designed Watt	age:										
01	02		03	04	05	06	07	08	09	1	0
Name or Item Tag	Complete Luminaire De	scription	Watts per luminaire ^{1, 2}	How is Wattage determined	Total Number Luminaires ²	Luminaire Status ³	Excluded per 140.7(a) / 170.2(e)6A	Design Watts	Cutoff Req. > 6,200 initial lumen output 130.2(b) / 160.5(c)1 ⁴	Fie Inspe Pass	
A/34	VISIONAIRE #RLX-1-T4A-32LC-3-3K-UNV A/34	☐ Linear	34	Mfr. Spec	6	New		204	NA: < 6200 lumens		
				•		Tota	l Design Watts:	204			
EX: Luminaire is a 14 FOOTNOTES: Au 25 For linear lumin 36 Select "New" for existing lumin the project scope 46 Compliance with G. SHIELDING	ions with a * require a note in the solighting a statue; EXCEPTION 2 to a statue; EXCEPTION 2 to a statue; EXCEPTION 2 to a statue, wattage should be indicated or new luminaires in a new outdoor naires within the project scope that it. The mandatory shielding requirement of REQUIREMENTS (BUG) The ses not apply to this project.	130.2(b) k for Luminaire of d as W/lf instead r lighting project, t are not being a	aut sheets to confir of Watts/luminair or for added lumi ltered and are rem	m wattage used j e. Total linear fee naires in an alter naining. Select "Ex	for compliance per et should be indica ation. Select "Alter kisting Reinstalled"	ted in column 05 red" for replacer ' for existing lum	5 instead of numb ment luminaires in inaires which are	an alteration. Se			
This section do											

CERTIFICATE OF COMPLIANCE		CALIFORNIA ENERGY COMMIS
SERVIN ICATE OF COMPLIANCE		NRCC
Project Name: DACC HQ Parking Lot	Report Page:	(Page
	Date Prepared:	9/1
M. LIGHTING ALLOWANCE: PER SPECIFIC AREA		
This section does not apply to this project.		
N. EXISTING CONDITIONS POWER ALLOWANCE (alterations only)		
This section does not apply to this project.		
O. DECLARATION OF REQUIRED CERTIFICATES OF INSTALLATION		
Selections have been made based on information provided in this document Additional Remarks. These documents must be provided to the building insp		n explanation should be included in Table E.
	Form/Title	
NRCI-LTO-E - Must be submitted for all buildings		
P. DECLARATION OF REQUIRED CERTIFICATES OF ACCEPTANCE Selections have been made based on information provided in this document Additional Remarks. These documents must be provided to the building insp Provider (ATTCP). For more information visit: http://www.energy.ca.gov/titl	pector during construction and must be completed through	
Form	m/Title	Systems/Spaces To Be Verified
NRCA-LTO-02-A - Must be submitted for all outdoor lighting controls except	for alterations where controls are added to <= 20 luminai	1770.34 7.00 7.70.33



Interiors

630 N. Rosemead Boulevard, Ste 400
Pasadena, California 91107
(626) 351-4301 FAX (626)351-4302

Planning



Registration

Client Name:
COUNTY OF LOS ANGELES PUBLIC WORKS

Project Title:
DEPARTMENT OF
ANIMAL CARE AND
CONTROL
HEADQUARTERS
FENCING PROJECT

Project Address: 5898 Cherry Ave., Long Beach, CA 90805 SPEC #: 7856

INTERIM REVIEW DOCUMENTS

Interim review documents are incomplete and not to be used for regulatory approval, permit, or construction.

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 Milestones
 Date

 CD 50%
 9/25/23

 CD 90%
 1/9/24

 BACK CHECK 1
 7/2/24

Revisions
No. Description

Date

Reviewed by VD

Plot date: Jul 02,2024 - 12:06PM

LCDG Job Number:

Sheet Title

ELECTRICAL
TITLE-24
COMPLIANCE
FORMS-OUTDOOR

Sheet Number

E4.

J:\23-010 LCDG P-1984 LAC DACC - Parking Lot Refurbishment\E\23-010 E4.1 ELECTRICAL TITLE-24 COMPLIANCE FORMS-OUTDOOR.dwg

INSTALLATION & WIRING

WARNING

4

DISCONNECT POWER AT THE CIRCUIT BREAKER BEFORE INSTALLING THIS PRODUCT.

ONLY CONNECT THE RT-200 TO A SINGLE POLE CIRCUIT. THE RT-200 IS NOT SUITABLE FOR 3-WAY SWITCHING.

IF THE EXISTING WIRING DOES NOT MATCH THE DESCRIPTION FOR A SINGLE POLE

CIRCUIT, YOU SHOULD CONSULT WITH A QUALIFIED ELECTRICIAN.

. Prepare the switch box

After the power is turned OFF at the circuit breaker box, remove the existing wall plate and mounting screws. Pull the old switch from the wall box.


2. Identify the type of circuit

In a single pole circuit, two single wires connect to two screws on the existing switch. A ground wire may also be present and connected to a ground terminal on the old switch. A neutral wire should also be present in the wall box.

3. Prepare the wires

Tag the wires currently connected to the existing switch, so that they can be identified later. Disconnect the wires. Make sure the insulation is stripped off the wires to expose their copper cores to the length indicated by the "Strip Gauge" (approximately ½ inch).



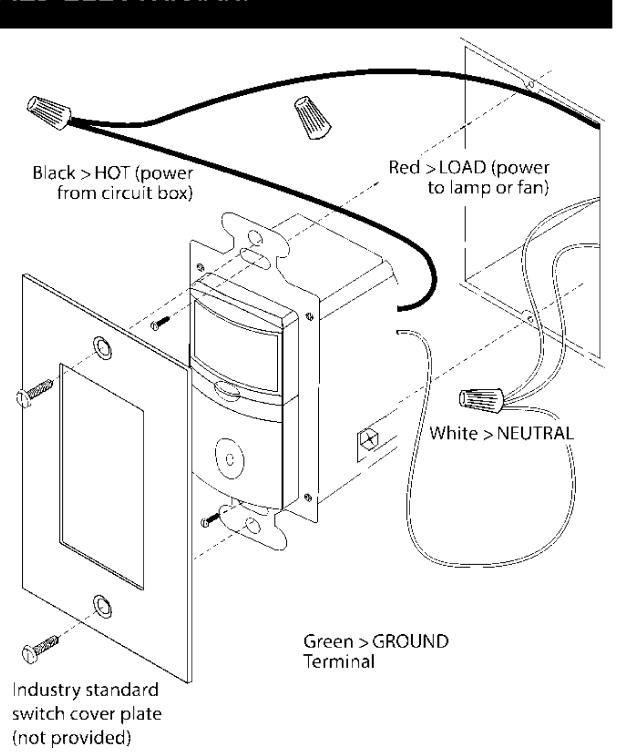

4. Wire the time switch

Twist the existing wires together with the wire leads on the RT-200 as indicated in the table below. Cap them securely using the wire nuts provided.

Power wire from the circuit (hot)	to	Black wire on RT-200
Power wire from the lamp or fan (load)	to	Red wire on RT-200
Neutral wires from the circuit	to	White wire on RT-200
Ground wire from the circuit	to	Ground terminal on RT-200


5. Put the RT-200 in the wall box with the display positioned above the ON/OFF button. Secure it to the wall box with the screws provided.

6. Install cover plates.

Install industry standard decorator wall switch cover plate (not included).

7. Restore power to the circuit.

Turn on the breaker or replace the fuse.

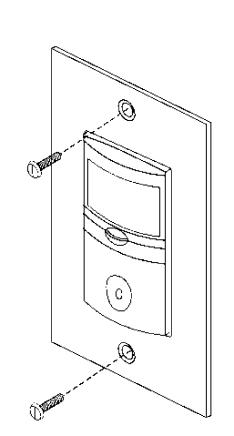

La Cañada Design Group
Architecture
Planning

630 N. Rosemead Boulevard, Ste 400 Pasadena, California 91107 (626) 351-4301 FAX (626)351-4302



Interiors

Registration

Client Name:
COUNTY OF LOS ANGELES PUBLIC
WORKS

DEPARTMENT OF
ANIMAL CARE AND
CONTROL
HEADQUARTERS
FENCING PROJECT

Project Address: 5898 Cherry Ave., Long Beach, CA 90805 SPEC #: 7856

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 Milestones
 Date

 CD 50%
 9/25/23

 CD 90%
 1/9/24

 BACK CHECK 1
 7/2/24

Revisions
No. Description

Reviewed by VD

Plot date: Jul 02,2024 - 12:06PM

LCDG Job Number:


Sheet Title


ELECTRICAL LIGHTING CONTROL DIAGRAM


Sheet Number

J:\23-010 LCDG P-1984 LAC DACC - Parking Lot Refurbishment\E\23-010 E4.2 ELECTRICAL LIGHTING CONTROL DIAGRAM.dwg

E4.2

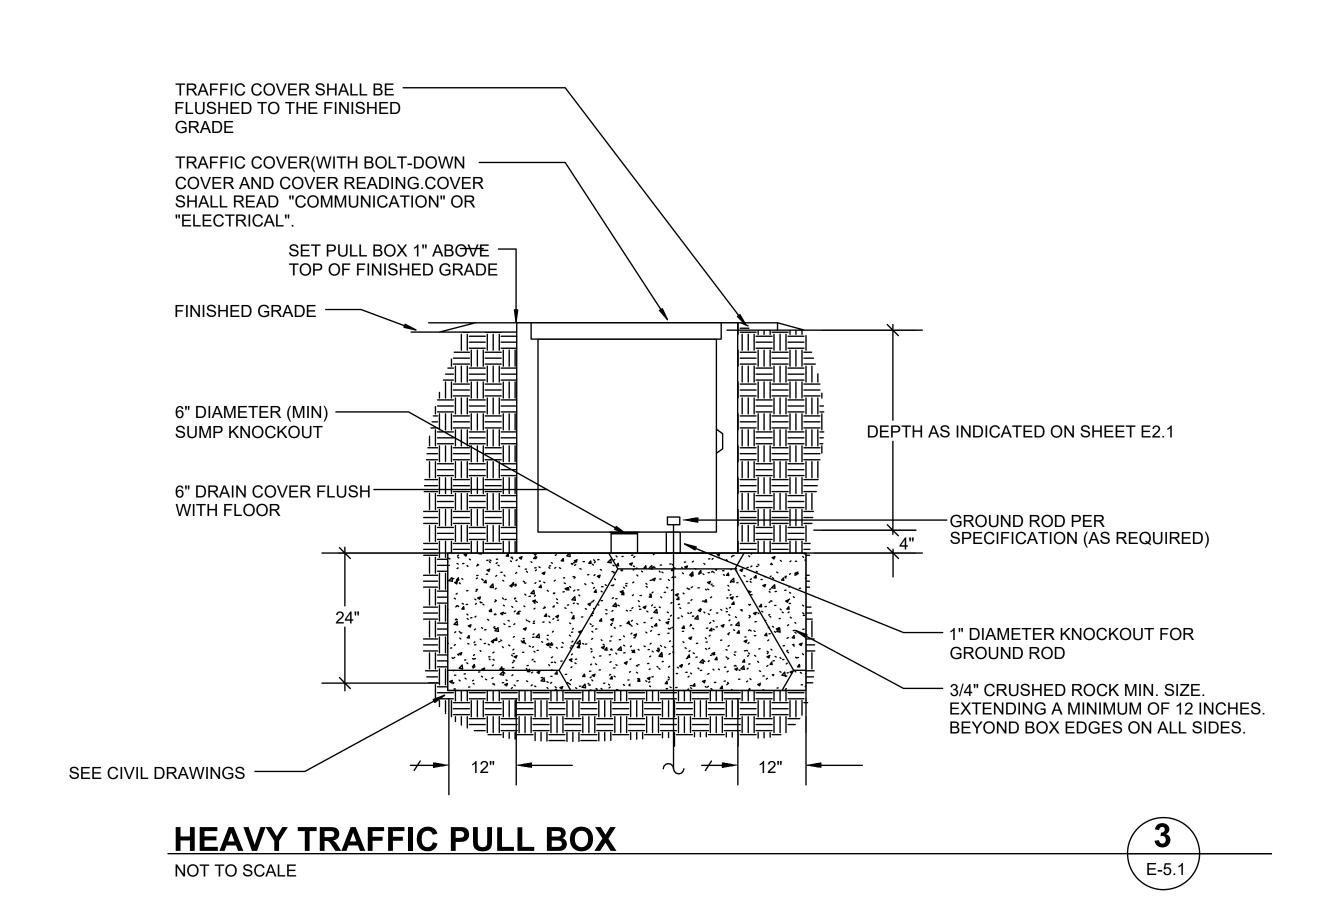

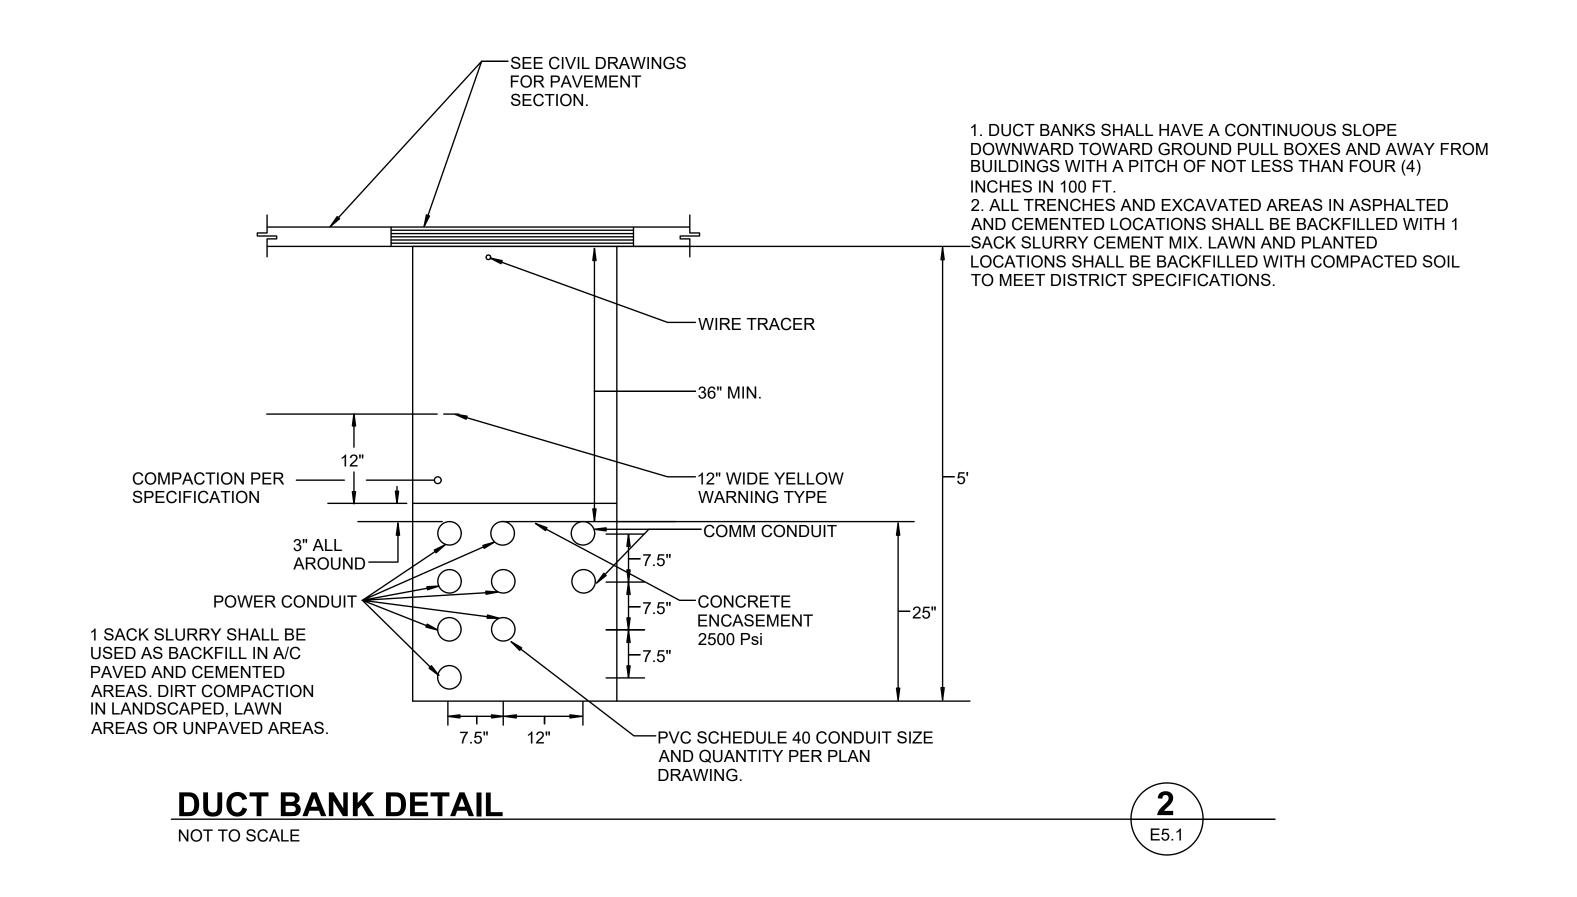

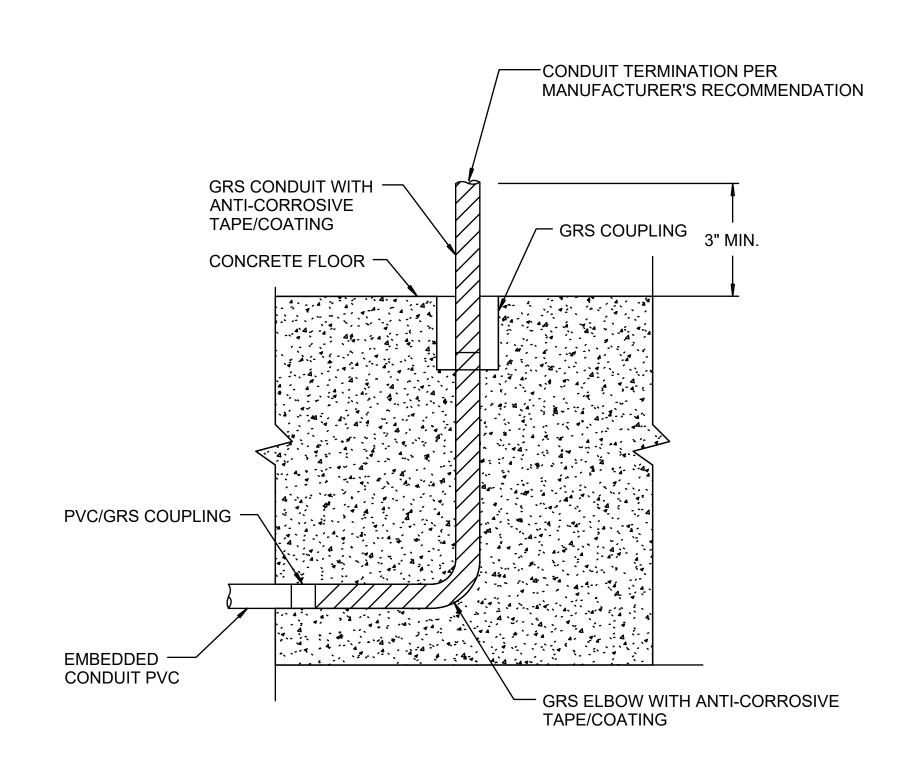

STUB UP OR STUB DOWN CONDUIT DETAIL

NOT TO SCALE

E5.1

La Cañada Design Group
Architecture
Planning

630 N. Rosemead Boulevard, Ste 400 Pasadena, California 91107 (626) 351-4301 FAX (626)351-4302



Interiors

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Project Title:
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FENCING PROJECT
Project Address:
5898 Cherry Ave.,
Long Beach, CA 90805
SPEC #: 7856

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Milestones	Date
CD 50%	9/25/23
CD 90%	1/9/24
BACK CHECK 1	7/2/24
Davidada	

Revis	sions	
No.	Description	Date
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Reviewed by VD

Plot date: Jul 02,2024 - 12:07PM

LCDG Job Number: 064

Sheet Title

ELECTRICAL DETAILS

Sheet Number

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E5.1