ATTACHMENT G

GENERAL NOTES CONTRACTOR SHALL BE HELD RESPONSIBLE FOR HAVING VISITED THE SITE

COUNTY ARCHITECT IMMEDIATELY

AND HAVING FAMILIARIZED HIMSELF WITH THE EXISTING CONDITIONS PRIOR TO SUBMITTING HIS BID. 2. THE CONTRACTOR SHALL VERIFY ALL DIMENSIONS PRIOR TO ANY DEMOLITION

OR CONSTRUCTION AT THE JOB SITE. ANY DISCREPANCY TO NOTIFY LA

- 5. ALL WORK SHALL BE PERFORMED AS PER CALIFORNIA BUILDING CODE. 2022 EDITION AND ALL INSPECTIONS SHALL BE PERFORMED AS REQUIRED BY THE COUNTY OF LOS ANGELES BUILDING DEPARTMENT AND THEIR RELATED
- CONTRACTOR SHALL MAINTAIN A SET OF PLANS, APPROVED BY THE LOCAL BUILDING DEPARTMENT, ON THE JOB SITE AT ALL TIMES DURING
- ALL WORK AND MATERIALS SHALL CONFORM TO THE REQUIREMENTS OF THE LATEST EDITIONS OF THE COUNTY OF LOS ANGELES BUILDING CODE AND UNIFORM BUILDING CODE STANDARDS, CALIFORNIA CODE OF REGULATIONS HANDICAPPED ACCESSIBILITY REQUIREMENTS (TITLE 24), AMERICANS WITH DISABILITIES ACT (ADA), THE PLANS AND THE PROJECT MANUAL.
- 6. THIS PROJECT REQUIRES THE PRIME CONTRACTOR TO POSSESS A LICENSE CLASSIFICATION B AT THE TIME OF BID AWARD. CONTRACTORS SHALL VERIFY THAT ALL CORRECT LICENSES ARE POSSESSED FOR THIS PROJECT.
- . CONTRACTOR SHALL BE RESPONSIBLE TO IDENTIFY & PROTECT AND REPAIR ALL UNDERGROUND UTILITIES, INCLUDING ELECTRICAL, PLUMBING, SPRINKLERS, GAS SEWERS, AND STORM DRAINS WITHIN THE CONSTRUCTION SITE OR AREAS THAT THEY WORK IN. CONTRACTOR SHALL BE RESPONSIBLE TO SOLICIT THE SERVICES OF USA/DIG ALERT PRIOR TO AN EXCAVATION WORK.
- B. CONTRACTOR SHALL FIELD VERIFY ALL EXISTING CONDITIONS, DIMENSIONS, AND ELEVATIONS. ANY DISCREPANCIES SHALL BE CALLED TO THE ATTENTION OF THE DEPARTMENT OF PUBLIC WORKS AND BE RESOLVED PRIOR TO STARTING WORK. DO NOT SCALE DRAWINGS.
- 9. THE CONTRACTOR SHALL BE RESPONSIBLE FOR COORDINATING THE WORK OF ALL TRADES. CONTRACTOR TO COORDINATE CIVIL, ARCHITECTURAL, ELECTRICAL, MECHANICAL AND PLUMBING REQUIREMENTS BEFORE CONSTRUCTION. ALL CONDITIONED SPACES SHALL COMPLY WITH "TITLE 24" STATE ENERGY CONSERVATION REQUIREMENTS. THE CONTRACTOR SHALL MAINTAIN FIRE ACCESS DURING CONSTRUCTION.
- 10. CONTRACTOR SHALL BE RESPONSIBLE FOR THE PUBLIC SAFETY AND FOR THE SAFETY OF THE BUILDING DURING CONSTRUCTION. THIS INCLUDES ALL NECESSARY SHORING, BRACING AND GUY WIRES WHICH SHALL CONFIRM TO ALL APPLICABLE SAFETY ORDINANCES. CONSULTANTS ARE AVAILABLE AT OSHA.
- 11. CONTRACTOR SHALL MAINTAIN THE SITE CLEAN OF RUBBISH SO AS NOT TO IMPEDE THE ACCESS AND WORK OF OTHER TRADES. THE CONTRACTOR SHALL PROVIDED BARRICADE/TEMPORARY FENCING/WARNING SIGNS TO PROTECT THE PUBLIC OR WORKMEN DURING CONSTRUCTION. BARRICADES/TEMPORARY FENCING SHALL BE LEFT IN PLACE UNTIL AUTHORIZED BY THE DEPARTMENT TO BE REMOVED BY THE CONTRACTOR, AND AFTER THE BARRICADES/TEMPARARY FENCING IS NOT LONGER REQUIRED FOR PROTECTION.
- 12. ALL ADJACENT FACILITIES SHALL CONTINUE IN NORMAL OPERATION DURING THE PERIOD OF THE CONTRACT. THE CONTRACTOR SHALL CONDUCT HIS WORK IN SUCH A MANNER NOT TO RESTRICT OR OBSTRUCT ENTRANCES. EXITS OR DISRUPT UTILITY SERVICES. THE CONTRACTOR SHALL PROVIDE TEMPORARY CONNECTIONS, LINES AND SERVICES TO THE LOS ANGELES
- 13. ALL AREAS AFFECTED OR DAMAGED BY ALTERATION, REMOVAL OF EXISTING CONSTRUCTION AND NEW WORK SHALL BE PATCHED AND REPAIRED TO MATCH EXISTING OR IN A SATISFACTORY MANNER APPROVED BY LOS ANGELES COUNTY PUBLIC WORKS. MATCH ADJACENT SIMILAR MATERIALS IN TEXTURE
- 14. SEPARATE BUILDING PERMITS SHALL BE TAKEN OUT FOR ELECTRICAL AND MECHANICAL PORTIONS. REQUIRED PERMITS SHALL BE OBTAINED FROM THE "STATE DIVISION OF INDUSTRIAL SAFETY" FOR ANY TRENCHES OR EXCAVATIONS 5 FEET OR MORE IN DEPTH INTO WHICH A PERSON IS REQUIRED TO DESCEND. SEPARATE PLANS SHALL BE PLAN CHECKED AND SEPARATE PERMITS SHALL BE OBTAINED FOR AUTOMATIC FIRE EXTINGUISHING SYSTEM AS APPLICABLE.
- 15. ALL WORK AND MATERIALS ARE NEW UNLESS OTHERWISE INDICATED. THE CONTRACT DOCUMENTS AND SPECIFICATIONS REPRESENT THE FINISHED STRUCTURE UNLESS OTHERWISE SHOWN. THEY DO NOT INDICATE THE METHOD OF CONSTRUCTION. CONTRACTOR SHALL SUPERVISE AND DIRECT THE WORK AND HE SHALL BE SOLELY RESPONSIBLE FOR ALL CONSTRUCTION MEANS, METHODS, TECHNIQUES, SEQUENCES AND PROCEDURES, INCLUDING BUT NOT LIMITED TO INSTALLATION OF ADEQUATE SHORING, BRACING, ETC., TO SAFELY EXECUTE ALL WORK.
- 16. DRAWINGS ARE DIVIDED INTO SEPARATE SHEETS FOR GENERAL CONVENIENCE ONLY. SHEET DESIGNATIONS OR NUMBERS SHALL NOT BE CONSIDERED TO LIMIT AREAS OF WORK, RESPONSIBILITY, OR TRADES. CONTRACTOR MUST COORDINATE THE DRAWINGS WITH EACH OTHER AND WITH PROJECT MANUAL IN ORDER TO COMPLETE THE PROJECT AS DESIGNED.
- 17. DIMENSIONS OF STUD WALLS ARE TO CENTERLINE OF STUDS UNLESS OTHERWISE NOTED. ALL DIMENSIONS ARE TO CENTER LINE OF COLUMNS UNLESS NOTED OTHERWISE. CONCRETE IS DIMENSIONED TO FACE OF WALL CMU DIMENSIONS ARE TO CENTERLINE OF MORTAR JOINTS UNLESS OTHERWISE NOTED. FOR EXACT OVERALL WALL DIMENSIONS SUBTRACT ONE MORTAR JOINT. FOR EXACT WALL OPENING DIMENSION ADD ONE MORTAR JOINT TO BOTH WIDTH AND HEIGHT. VERTICAL DIMENSIONS FROM FINISH FLOOR LINE ARE TO TO TOP OF UNIT UNLESS OTHERWISE NOTED.
- 18. TYPICAL DETAILS AND GENERAL NOTES APPLY TO ALL PARTS OF THE JOB, EXCEPT WHERE THEY CONTRADICT WITH DETAILS NOTES SPECIFIED ON OTHER SHEETS. ALL INFORMATION SHOWN ON THE DRAWINGS RELATIVE TO EXISTING CONDITIONS IS GIVEN AS BEST AS POSSIBLE, BUT WITHOUT GUARANTEE OF ACCURACY. WHERE ACTUAL CONDITIONS CONFLICT WITH THE DRAWINGS, THEY SHALL BE REPORTED TO LOS ANGELES COUNTY PUBLIC WORKS ARCHITECTS SO THAT THE PROPER REVISIONS MAY BE MADE. MODIFICATIONS OF DETAILS OF CONSTRUCTION SHALL NOT BE MADE WITHOUT WRITTEN APPROVAL OF LOS ANGELES COUNTY PUBLIC WORKS ARCHITECTS. WHERE NO SPECIFIC DETAIL IS SHOWN, THE FRAMING OR CONSTRUCTION SHALL BE IDENTICAL OR SIMILAR TO THAT FOR LIKE CASES OF CONSTRUCTION ON THIS PROJECT, AND BE SUBJECT TO REVIEW AND APPROVAL BY LA COUNTY PUBLIC WORKS (PW) ARCHITECTS.
- 19. PORTABLE FIRE EXTINGUISHERS SHALL BE INSTALLED AND MAINTAINED IN ALL OCCUPANCY GROUPS AND AT SUCH LOCATIONS AS REQUIRED BY FIRE CODE 906 AND CALIFORNIA CODE OF REGULATIONS, TITLE 19, DIVISION 1, $\angle 4$ CHAPTER 3. THE FINAL NUMBER AND LOCATION OF ALL EXTINGUISHERS SHALL BE DETERMINED BY THE LOCAL AREA FIRE INSPECTOR.

CAMP GLENN ROCKEY SECURITY UPGRADES CONTRACT NO. PW15739 PCA: P9700226 PCS ID:00002237

1900 SYCAMORE ROAD, SAN DIMAS, CA 91773

CALIFORNIA BUILDING CODE, 2022 EDITION

CALIFORNIA MECHANICAL CODE, 2022 EDITION

CALIFORNIA ELECTRICAL CODE, 2022 EDITION

CALIFORNIA PLUMBING CODE, 2022 EDITION

CALIFORNIA ENERGY CODE, 2022 EDITION

APPLICABLE CODES

W/ 2023 COUNTY OF LOS ANGELES BUILDING CODE (TITLE 26)

(W/ 2023 COUNTY OF LOS ANGELES AMENDMENTS FULLY

CALIFORNIA GREEN BLDG. STANDARDS CODE, 2022 EDITION

ATTACHMENT A

BEST MANAGEMENT PRACTICES

FOR CONSTRUCTION ACTIVITIES

Storm Water Pollution Control Requirements for Construction Activities Minimum Water Quality Protection Requirements for All Development Construction

The following is intended as minimum notes or as an attachment for building and grading plans and

· Eroded sediments and other pollutants must be retained on site and may not be transported from the site

• Fuels, oils, solvents and other toxic materials must be stored in accordance with their listing and are not to

Non-stormwater runoff from equipment and vehicle washing and any other activity shall be contained at the

• Excess or waste concrete may not be washed into the public way or any other drainage system. Provisions

· Trash and construction related solid wastes must be deposited into a covered receptacle to prevent

Sediments and other materials may not be tracked from the site by vehicle traffic. The construction

· Any slopes with disturbed soils or denuded of vegetation must be stabilized so as to inhibit erosion by wind

As the project owner or authorized agent of the owner, I have read and understand the requirements listed

above, necessary to control storm water pollution from sediments, erosion, and construction materials, and I

entrance roadways must be stabilized so as to inhibit sediments from being deposited into the public way.

Accidental depositions must be swept up immediately and may not be washed down by rain or other

shall be made to retain concrete wastes on site until they can be disposed of as solid waste.

contaminate the soil and surface waters. All approved storage containers are to be protected from the weather. Spills must be cleaned up immediately and disposed of in a proper manner. Spills may not be


represent the minimum standards of good housekeeping that must be implemented on all cor sites regardless of size. (Applies to all permits)

via sheetflow, swales, area drains, natural drainage courses or wind.

(Owner or authorized agent of the owner

the site by the forces of wind or water.

INTEGRATED INTO 2022 CALIFORNIA BUILDING CODE)

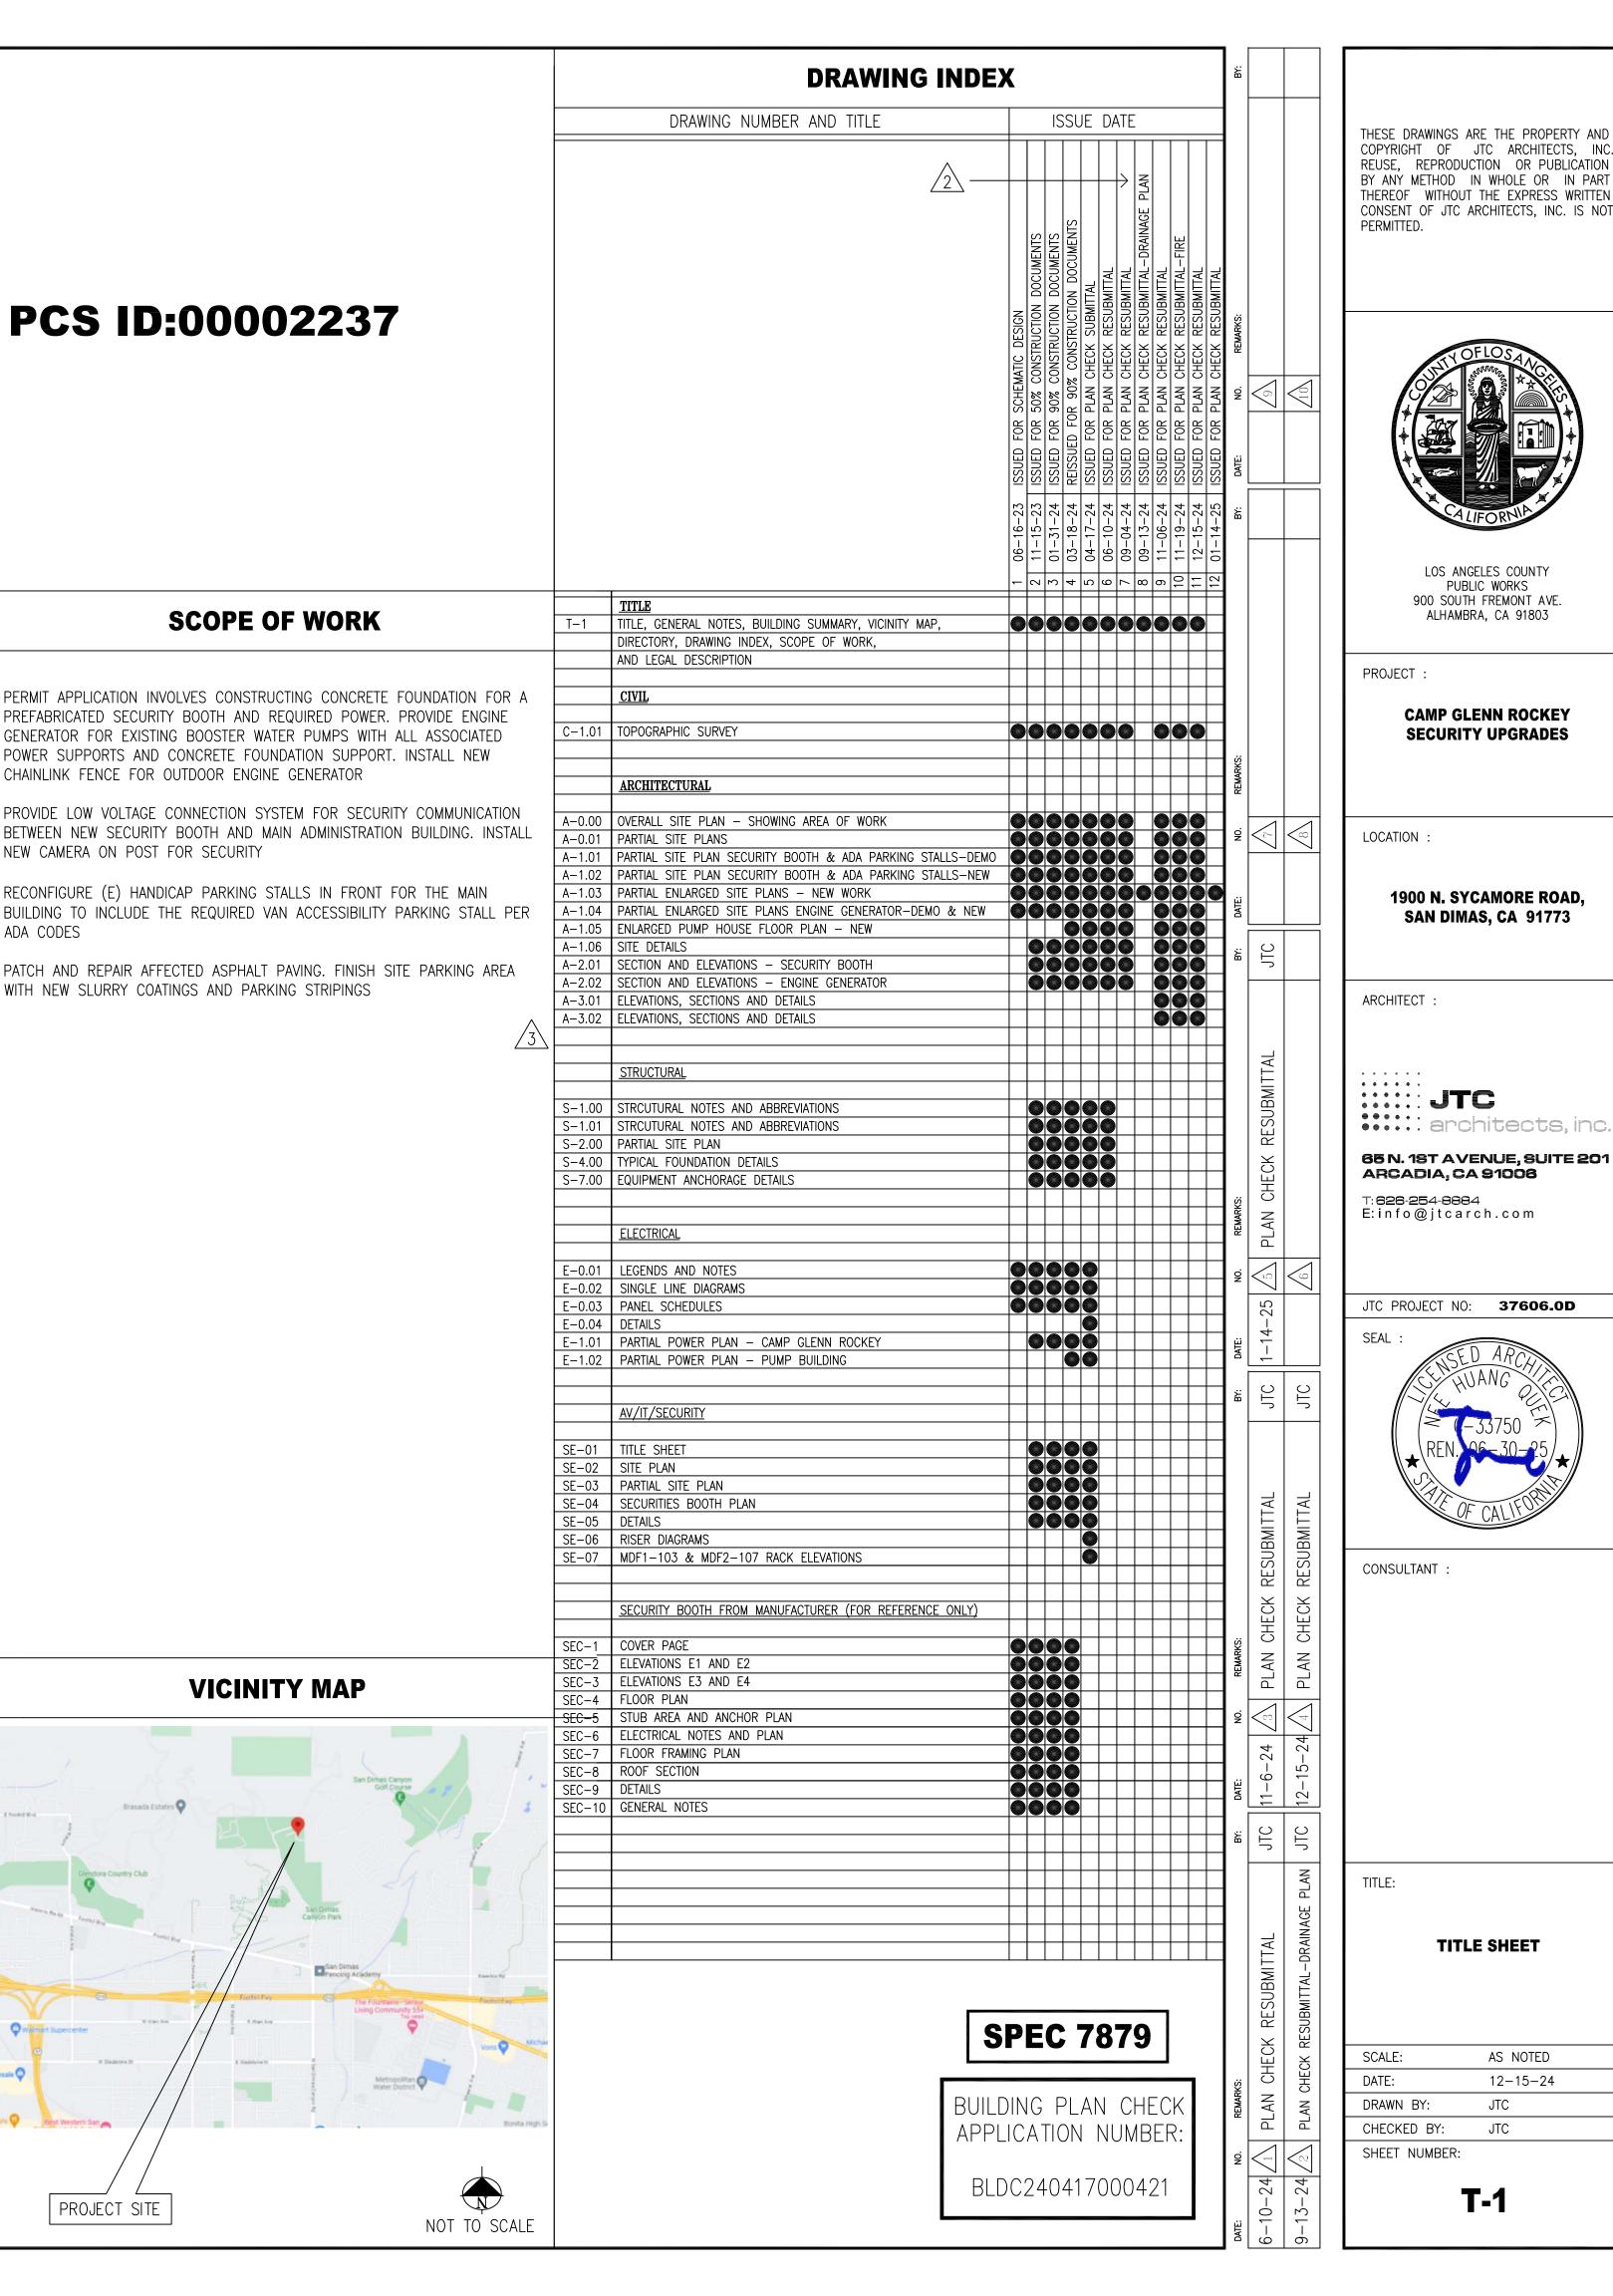

PUBLIC WORKS

TITLE SHEET

AS NOTED

12-15-24

JTC

JTC

T-1

BUILDING CODES:

PUBLIC WORK

BUILDING OCCUPANCY: I - 3

BUILDING USE:

JUVENILE DETENTION CENTER

CONSTRUCTION TYPE: MAIN BUILDING: APPROVED PLANS:

GROUP B

PROJECT SUMMARY

TYPE I —A (NON—FIRE SPRINKLER. MONITORED FIRE ALARM WITH SMOKE DETECTORS PROTECTION SYSTEM) LACC 6528 (PLAN DRAWINGS DATED 1974)

OCCUPANCY:

OUTDOOR SECURITY BOOTH APPROX. <u>45 SQ.FT</u>. TYPE V-B CONSTRUCTION

OUTDOOR ENGINE GENERATOR APPROX. 275 SQ.FT.

INSTALLATION OF AUTOMATIC TRANSFER SWITCH AT PUMP ROOM

PARKING:

NEW VAN ACCESSIBILITY ADA PARKING STALLS NEW ACCESSIBLE LOADING AREAS FOR ADA PARKING STALLS

DIRECTORY

OWNER'S REPRESENTATIVE

LOS ANGELES COUNTY PUBLIC WORKS 900 S. FREMONT AVENUE ALHAMBRA, CA 91803 ATTN.: CHAM WADU TEL: 626-300-3246

JTC ARCHITECTS, INC. 65 N. FIRST AVE., STE. 201 ARCADIA, CA 91006 ATTN.: JUNE QUEK TEL: 626-254-8884

STRUCTURAL ENGINEER

3900 COVER STREET LONG BEACH, CA 90808 ATTN.: RICK BEALL FAX: 562-985-3200

ELECTRICAL ENGINEERS

dHA+CALPEC 150 S. ARROYO PARKWAY, ATTN.: DEREK WEI (ELEC.) TEL.: 626-445-8580

PROJECT MANAGEMENT DIVISION II

<u>CIVIL ENGINEER</u> CALVADA SURVEYING, INC. 411 JENKS CIRCLE, SUITE 205 CORONA, CA 92878 ATTN.: ARMANDO DUPONT

TEL: 951-280-9960 AV/IT/SECURITY CONSULTANT INNOVAVE 12970 BRNAFORD ST, UNIT F ARLETA, CA 91331

ATTN.: JOE ALABASHYAN

TEL.: 818-630-5755

<u>MECHANICAL/</u>

STE. 100 PASADENA, CA 91105

LEGAL DESCIPTION

PROJECT SITE

NEW CAMERA ON POST FOR SECURITY

ADA CODES

ADDRESS: 1900 SYCAMORE CANYON RD., SAN DIMAS CA 91773-1220


PROPERTY BOUNDARY DESCRIPTION: THAT PARCEL (EX OF ST) IN SAN DIMAS CITY LTG DIST ZONE B OF LOT COM AT NW COR OF SEC 35 T IN R 9W TH S ON W LINE OF SD SEC 1305.15 FT. TH N 89 27'25" E TO E LINE OF SYCAMORE CYN. RD. TH S AND FOLLOWING SD RD TO SW LINE OF LAND DESC IN DDS 3922-283 TO L A CO TH SE THEREON TO A PT S O O2' W 405 FT FROM NW COR OF LOT 16 WESTERN WATER AND POWER CO'S TR TH NO 02' E 412.47 FT TH N 89 49' E


10.09 FT. TH N 0 18' E 2620.48 FT TH S 89 15'50" W 2606.34 FT TO BEG PARTOF W 1/2 OF SEC 35 T IN R 9W


ASSESSOR'S ID NO. : 8665-001-901


TOPOGRAPHIC SURVEY

GLENN ROCKEY CAMP SCHOOL 1900 SYCAMORE CANYON ROAD, SAN DIMAS, CA 91773

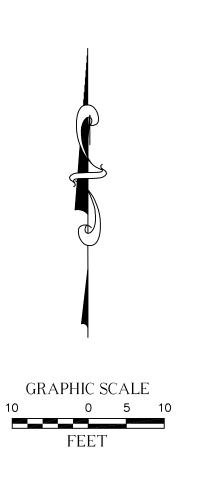

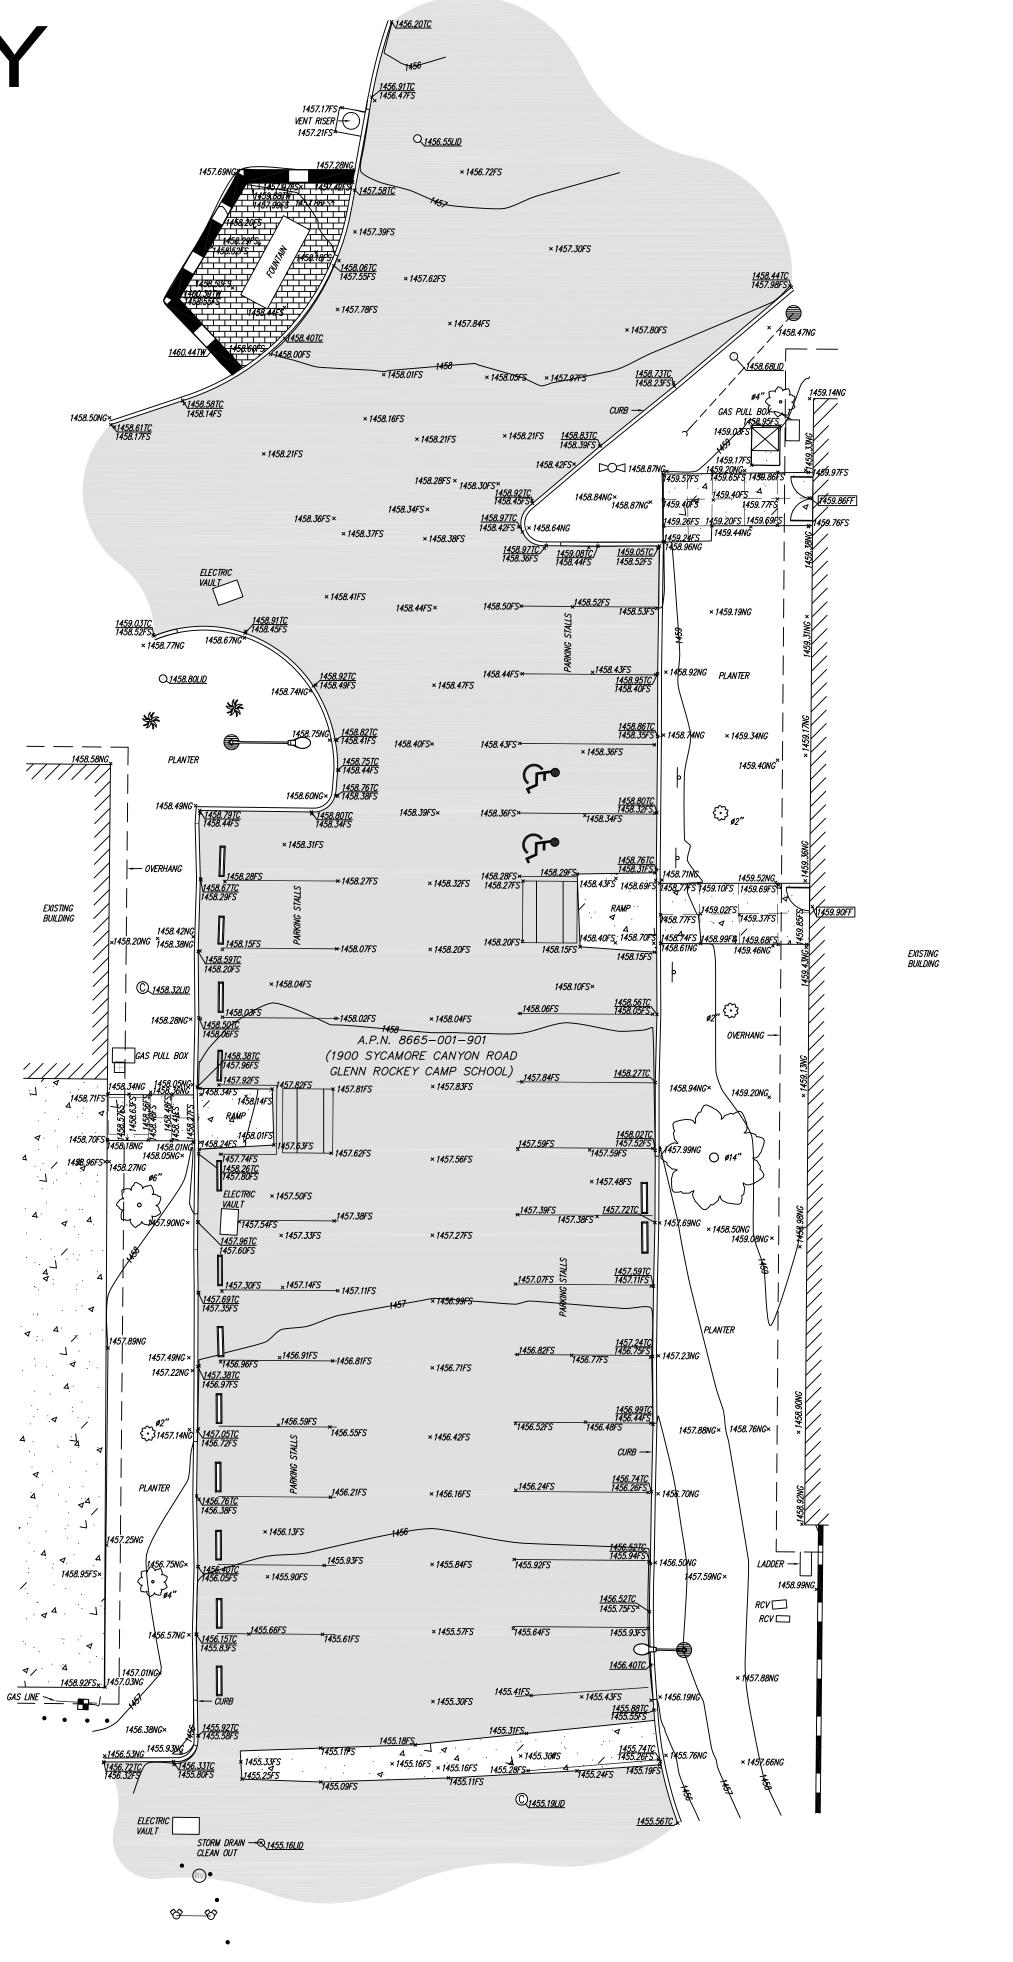

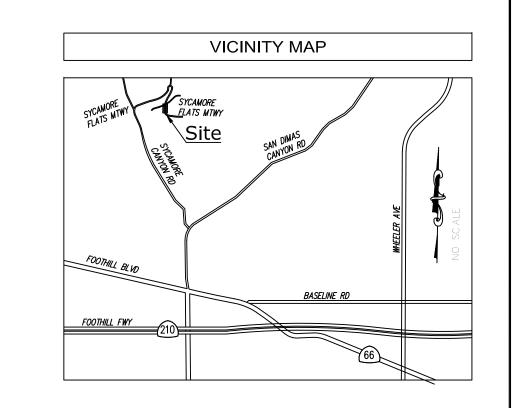

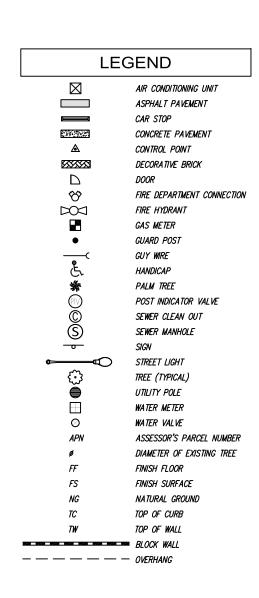

SPEC 7879


BUILDING PLAN CHECK APPLICATION NUMBER:

BLDC240417000421

DATE: 02-06-25

C-1.01

UNDERGROUND UTILITIES OR PIPE LINES ARE REQUIRED, THE UTILITY OR PIPELINE ML HAVE TO BE VERIFIED BY FIELD POTHOLING, CALVADA SURVEYING, INC. AND SHALL NOT BE HELD LIABLE FOR THE LOCATION OF RECORD SHALL NOT BE HELD LIABLE FOR THE LOCATION JOB NO. 2	REVISIONS	UTILITY STATEMENT	PREPARED FOR	BASIS OF COORDINATES	BENCHMARK	SITE INFORMATION	SURVEYOR OF RECORD	ELD COMPLETION DATE: APRIL 21, 2023
Armando D. DuPont Registration No. 7780 SHEE	O 05/02/23 SUBMITTAL VG	PER VISIBLE AND APPARENT SURFACE EVIDENCE, RECORD DRAWINGS OF THE CONSTRUCTED UTILITY LINES OBTAINED FROM RELIABLE AND RESPONSIBLE SOURCES NOT CONNECTED WITH CALVADA SURVEYING, INC. OR MARKINGS PROVIDED BY AN INDEPENDENT LOCATING CONTRACTOR. NO GUARANTEE OR WARRANTY, EITHER EXPRESSED OR IMPULED, INFORMATION. IF MORE ACCURACY OR THOROUGHNESS OF SUCH INFORMATION. IF MORE ACCURATE LOCATIONS OF UNDERGROUND UTILITIES OR PIPE LINES ARE REQUIRED, THE UTILITY OR PIPELINE WILL HAVE TO BE VERIFIED BY FIELD POTHOLING. CALVADA SURVEYING, INC. AND THE SURVEYOR OF RECORD SHALL NOT BE HELD LIABLE FOR THE LOCATION OF OR THE FAILURE TO NOTE THE LOCATION OF	65 N. 1ST AVENUE, SUITE 201 ARCADIA, CA 91006	(2018.00) IN ACCORDANCE TO THE CALIFORNIA PUBLIC RESOURCES CODE SECTIONS 8801–8819; SAID COORDINATE DETERMINED LOCALLY UPON FIELD-OBSERVED TIES TO THE FOLLOWING LEICA SMARTNET NORTH AMERICA (S. CONTINUOUSLY OPERATING REFERENCE STATIONS (C.O.R.S.): S.N.N.A. CAGD: NORTHING = 1869156.79' EASTING = 6614016.57' S.N.N.A. CANC:	S ARE ANGELES COUNTY BENCHMARK NG5339, ELEVATION N.N.A.) 1073.07 FEET (NAVD 88). DESCRIPTION: LACO BM TAG IN N CB SAN DIMAS CYN RD 3' W/O	SITE ADDRESS: 1900 SYCAMORE CANYON ROAD, SAN DIMAS, LOS ANGELES, CA 91773 ASSESSOR'S PARCEL NO.: 8665-001-901	SURVEYIN 411 Jenks Circle, Suite 205 Phone: 951-280-9960 Toll Free: 800-CALVADA EST. 1989 Armando D. DuPont	-

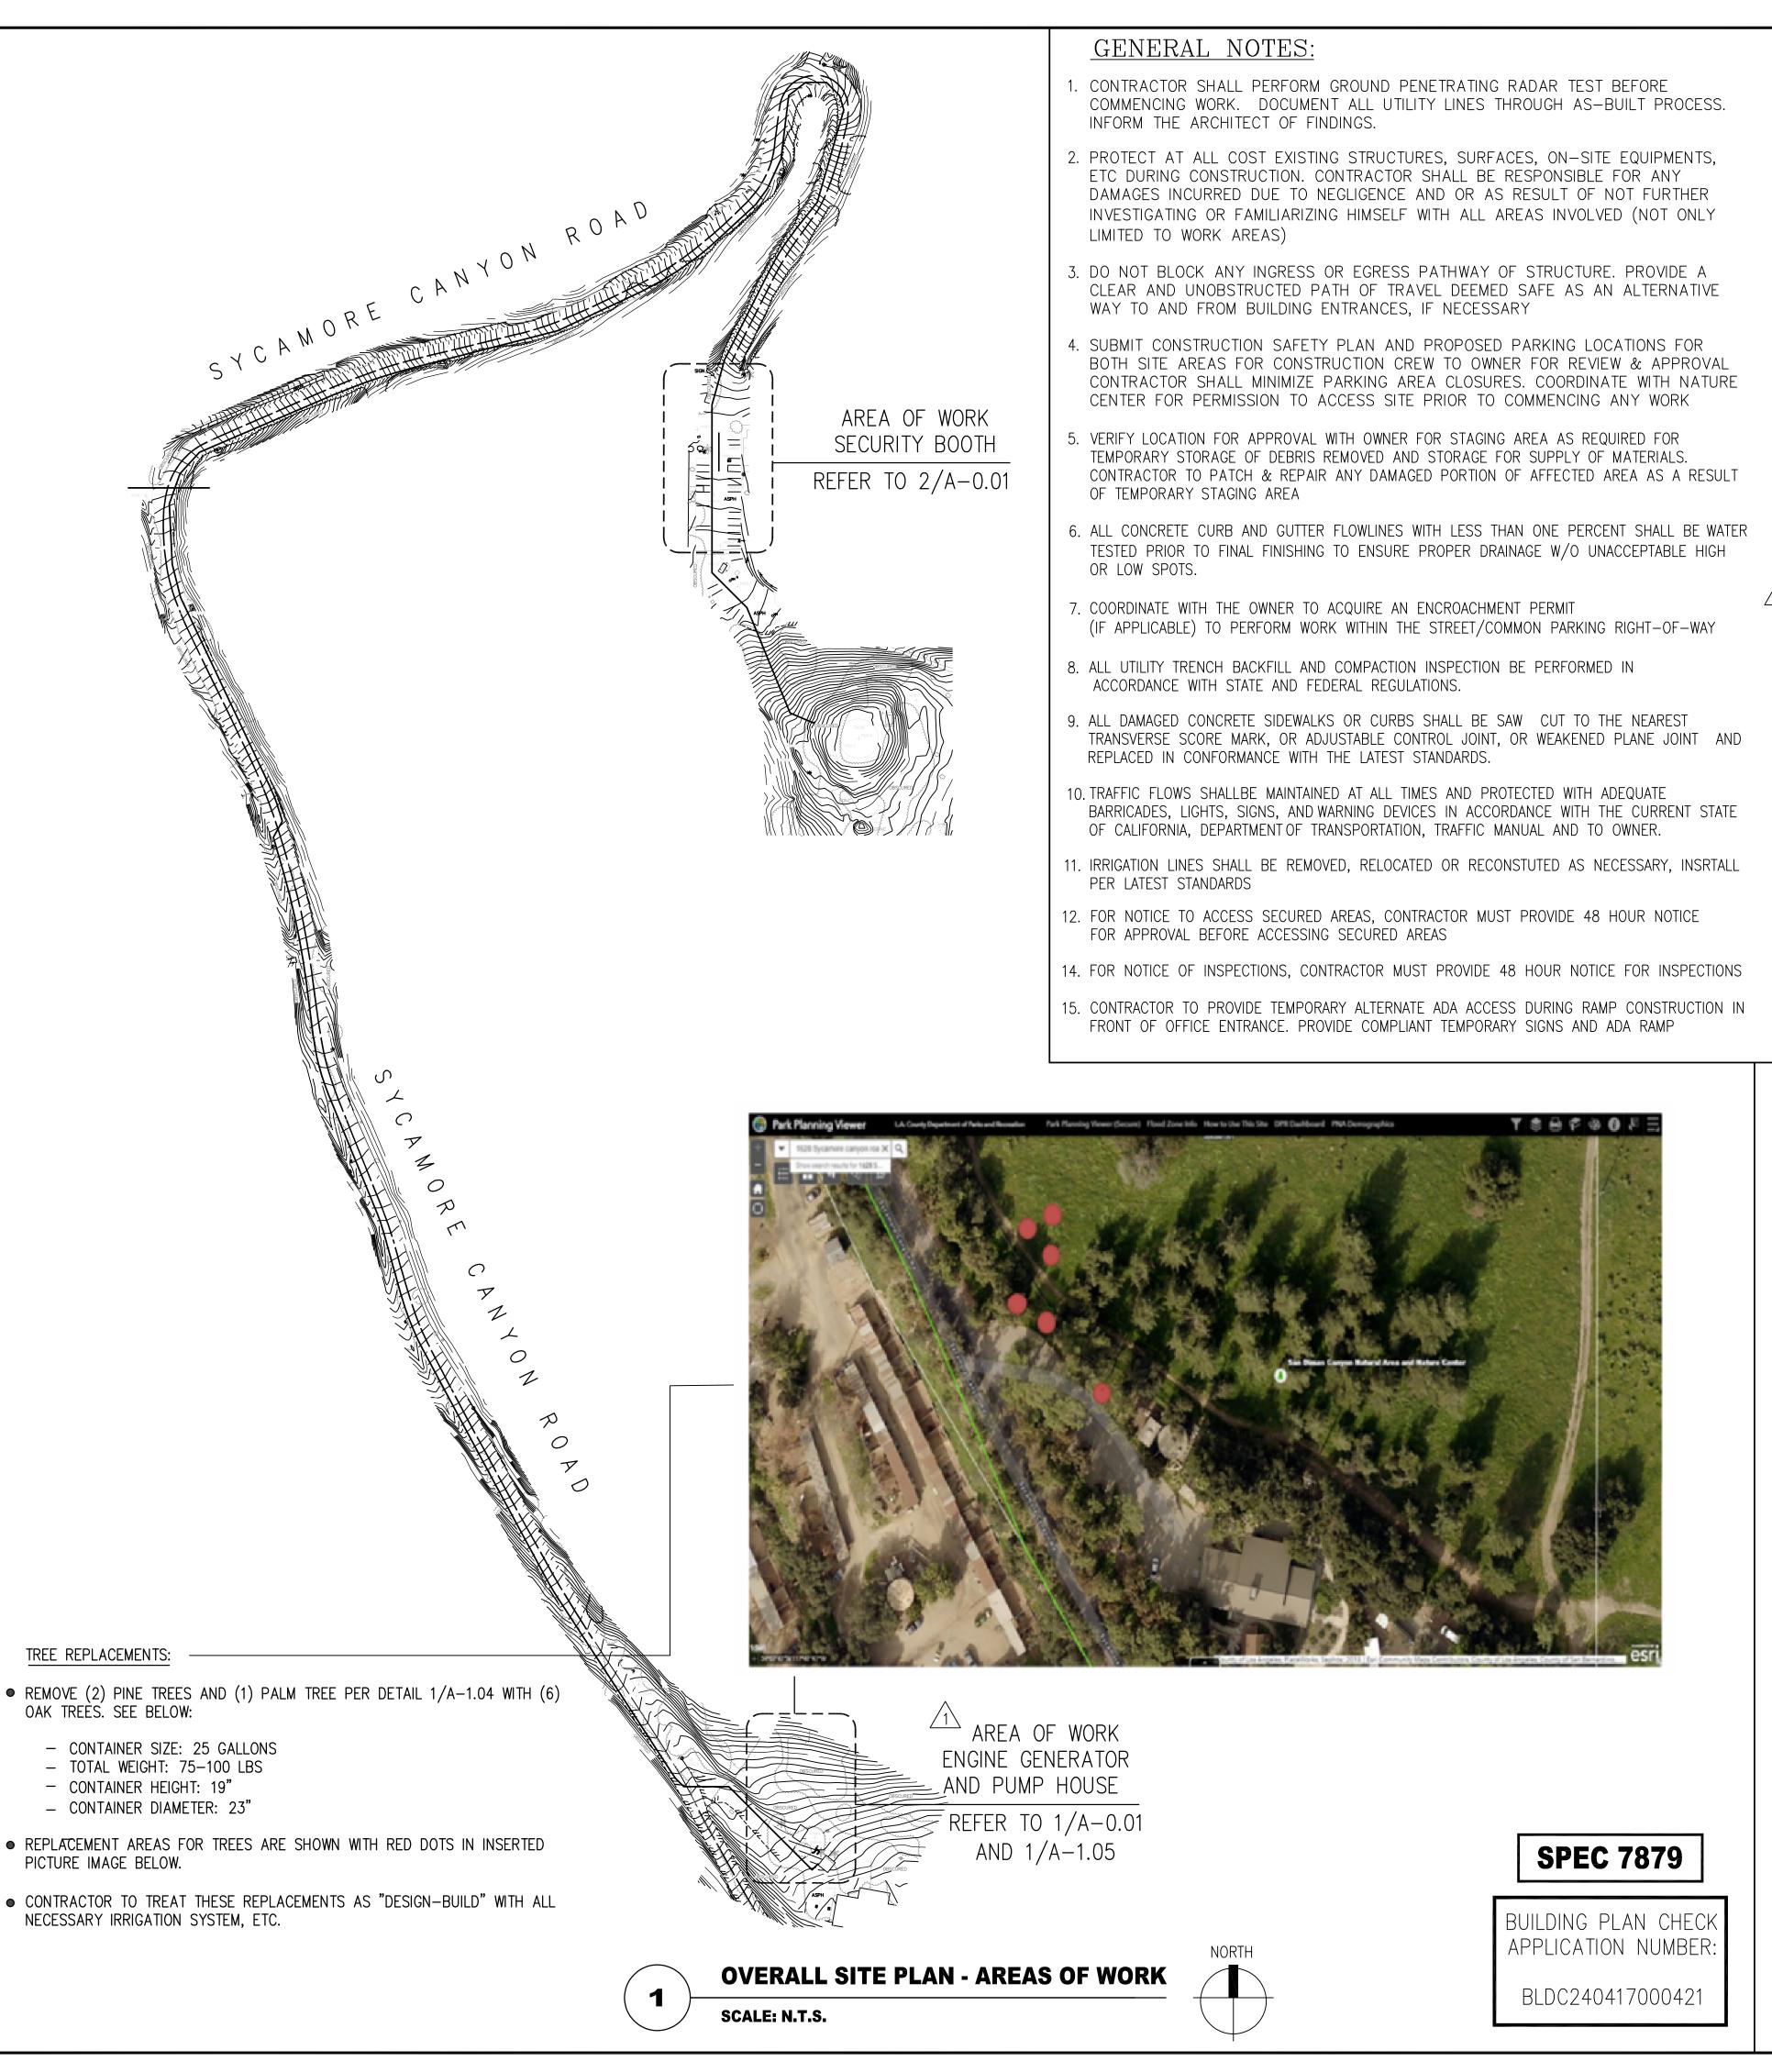

13. CONTRACTOR SHALL MAINTAIN ADJACENT STREETS IN A NEAT, CLEAN, DUST-FREE, AND SANITARY CONDITION AT ALL TIMES AND TO THE SATISFACTION OF THE OWNER. THE ADJACENT AREAS SHALL BE KEPT CLEAN OF DEBRIS, WITH DUST AND OTHER NUISANCE BEING CONTROLLED AT ALL TIMES. CONTRACTOR SHALL BE RESPONSIBLE FOR ANY CLEAN-UP ON ADJACENT STREETS AFFECTED CONSTRUCTION. METHOD OFSTREET CLEANING SHALL BE BY DRY SWEEPING OF ALL PAVED AREAS. NO STOCKPILING OF BLDG MATERIALS WILL BE ALLOWED WITHIN THE STREET RIGHT-OF-WAY WITHOUT THE PERMISSION OF THE OWNER.

- 16. CONTRACTOR TO PROVIDE HEAVY DUTY INDUSTRY STANDARDS PAD LOCKS FOR ALL LOW PULL BOXES FOR BOTH SECURITY BOOTH AND ENGINE GENERATOR PROJECT SITES
- 17. CONTRACTOR TO PROVIDE WARNING SIGNS ON EACH SIDE OF THE ENGINE GENERATOR CHAINLINK FENCE
- 18. REPLACE PLANTS OR GROUND COVER TO MATCH EXISTING. INCLUDE 90 DAY MAINTENANCE PERIOD FROM THE DATE OF ACCEPTANCE
- 19. CONTRACTOR SHALL BE REQUIRED TO SIGN AN AGREEMENT WITH NATURE CENTER FOR ACCESS TO THE GENERATOR AND RELATED CONSTRUCTION AREAS
- 20. LOCATIONS OF LOW WALL MOUNTED PULL BOXES SHALL BE APPROVED BY PROBATION OPERATIONS TO MITIGATE POTENTIAL USE OF THEM AS STEPPING STONE TO CLIMB ONTO ROOF CREATING AN ESCAPE PATH.
- 21. FIRE DEPARTMENT VEHICULAR ACCESS ROADS MUST BE INSTALLED AND MAINTAINED IN A SERVICEABLE MANNER PRIOR TO AND DURING THE TIME OF CONSTRUCTION.
- 22. PROVIDE APPROVED SIGNS OR OTHER APPROVED NOTICES OR MARKINGS THAT INCLUDE THE WORDS NO PARKING - FIRE LANE. SIGNS SHALL HAVE A MINIMUM DIMENSION OF 12 INCHES WIDE BY 18 INCHES HIGH AND HAVE RED LETTERS ON A WHITE REFLECTIVE BACKGROUND. SIGNS SHALL BE PROVIDED FOR FIRE APPARATUS ACCESS ROADS, TO CLEARLY INDICATE THE ENTRANCE TO SUCH ROAD, OR PROHIBIT THE OBSTRUCTION THEREOF AND AT INTERVALS, AS REQUIRED BY THE FIRE INSPECTOR. FIRE CODE 503.3
- 23. APPROVED BUILDING ADDRESS NUMBERS, BUILDING NUMBERS OR APPROVED BUILDING IDENTIFICATION SHALL BE PROVIDED AND MAINTAINED SO AS TO BE PLAINLY VISIBLE AND LEGIBLE FROM THE STREET FRONTING THE PROPERTY. THE NUMBERS SHALL CONTRAST WITH THEIR BACKGROUND, BE ARABIC NUMERALS OR ALPHABET LETTERS, AND BE A MINIMUM OF 4 INCHES HIGH WITH A MINIMUM STROKE WIDTH OF 0.5 INCH. FIRE CODE 505.1.
- 24. ALL FIRE HYDRANTS SHALL MEASURE 6" X 4"" X 2-1/2", BRASS OR BRONZE, CONFORMING TO AMERICAN WATER WORKS ASSOCIATION STANDARD C503. OR APPROVED EQUAL.
- 25. ALL REQUIRED PUBLIC FIRE HYDRANTS SHALL BE INSTALLED, TESTED AND ACCEPTED PRIOR TO BEGINNING CONSTRUCTION. FIRE CODE 501.4
- 26. ROOF GUTTERS SHALL BE PROVIDED WITH A MEANS TO PREVENT THE ACCUMULATION OF LEAVES AND DEBRIS IN THE GUTTER. (BUILDING CODE 705A.4)
- 27. CLEARANCE OF BRUSH AND VEGETATIVE GROWTH SHALL BE MAINTAINED PER FIRE CODE 325

ENVIRONMENTAL NOTES:

- 1. CONTRACTOR SHALL NOTIFY ALL OF HIS SUBCONTRACTORS THAT DUMPING OF CHEMICALS INTO THE STORM DRAIN SYSTEM OR THE WATERSHED IS PROHIBITED.
- CONTRACTOR SHALL MAINTAIN CONSTRUCTION SITE IN SUCH CONDITION THAT AN ANTICIPATED STORM DOES NOT CARRY WASTES OR POLLUTANTS OFF THE SITE. POTENTIAL POLLUTANTS INCLUDE BUT ARE NOT LIMITED TO: SOLID OR LIQUID CHEMICAL SPILLS; WASTES FROM PAINTS, STAINS, SEALANT, GLUES, LIMES, PESTICIDES, HERBICIDES, WOOD PRESERVATIVES AND SOLVENTS; ASBESTOS FIBERS, PAINTS FLAKES OR STUCCO FRAGMENTS; FUELS, OILS, LUBRICANTS, AND HYDRAULIC, RADIATOR, OR BATTERY FLUIDS; FERTILIZERS, VEHICLE/EQUIPMENT WASH WATER AND CONCRETE WASH WATER; CONCRETE, DETERGENT OR FLOATABLE WASTES; WASTES FROM ANY ENGINE/EQUIPMENT STEAM CLEANING OR CHEMICAL DEGREASING; AND SUPERCHLORINATED POTABLE WATER LINE FLUSHINGS.
- 3. DURING CONSTRUCTION, CONTRACTOR SHALL DISPOSE OF SUCH MATERIALS IN A SPECIFIED AND CONTROLLED TEMPORARY AREA ON-SITE, PHYSICALLY SEPARATED FROM POTENTIAL STORM WATER RUNOFF, WITH ULTIMATE DISPOSAL IN ACCORDANCE WITH LOCAL, STATE, AND FEDERAL REQUIREMENTS.
- 4. DEWATERING OF CONTAMINATED GROUNDWATER, OR DISCHARGING CONTAMINATED SOILS VIA SURFACE EROSION IS PROHIBITED. DEWATERING OF NON-CONTAMINATED GROUNDWATER REQUIRES AN APPROVAL FROM THE OWNER.

EROSION NOTES:

- 1. EQUIPMENT AND WORKERS FOR EMERGENCY WORK SHALL BE MADE AVAILABLE AT ALL TIMES DURING THE RAINY SEASON. NECESSARY MATERIALS SHALL BE AVAILABLE ONSITE OR STOCKPILED AT CONVENIENT LOCATIONS TO FACILITATE RAPID CONSTRUCTION OF TEMPORARY DEVICES WHEN RAIN IS IMMINENT.
- 2. EROSION CONTROL DEVICES SHALL NOT BE MOVED OR MODIFIED WITHOUT THE APPROVAL OF THE OWNER.
- 3. ALL REMOVABLE EROSION PROTECTIVE DEVICES SHALL BE IN PLACE AT THE END OF EACH WORKING DAY WHEN THE 5-DAY RAIN PROBABILITY FORECAST EXCEEDS 40 PERCENT.
- 4. AFTER A RAINSTORM, ALL SILT AND DEBRIS SHALL BE REMOVED FROM STREETS, CHECK BERMS, AND BASINS.
- 5. GRADED AREAS ON THE PERMITTED AREA PERIMETER MUST DRAIN AWAY FROM THE FACE OF SLOPES AT THE CONCLUSION OF EACH WORKING DAY. DRAINAGE TO BE DIRECTED TOWARD DESILTING FACILITIES.
- 6. THE CONTRACTOR SHALL BE RESPONSIBLE AND TAKE NECESSARY PRECAUTIONS TO PREVENT PUBLIC TRESPASS ONTO AREAS WHERE IMPOUNDED WATER CREATES A HAZARDOUS CONDITION.

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LOS ANGELES COUNTY PUBLIC WORKS 900 SOUTH FREMONT AVE. ALHAMBRA, CA 91803

PROJECT :

CAMP GLENN ROCKEY SECURITY UPGRADES

LOCATION :


1900 N. SYCAMORE ROAD, SAN DIMAS, CA 91773

ARCHITECT

.....JTC architects, inc.

65 N. 1ST AVENUE, SUITE 201 ARCADIA, CA 91006

:626-254-8884 E:info@jtcarch.com

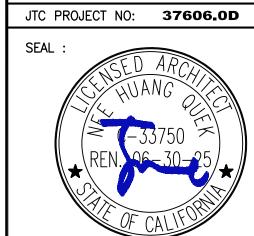

CONSULTANT:

BID SET

| | | | |


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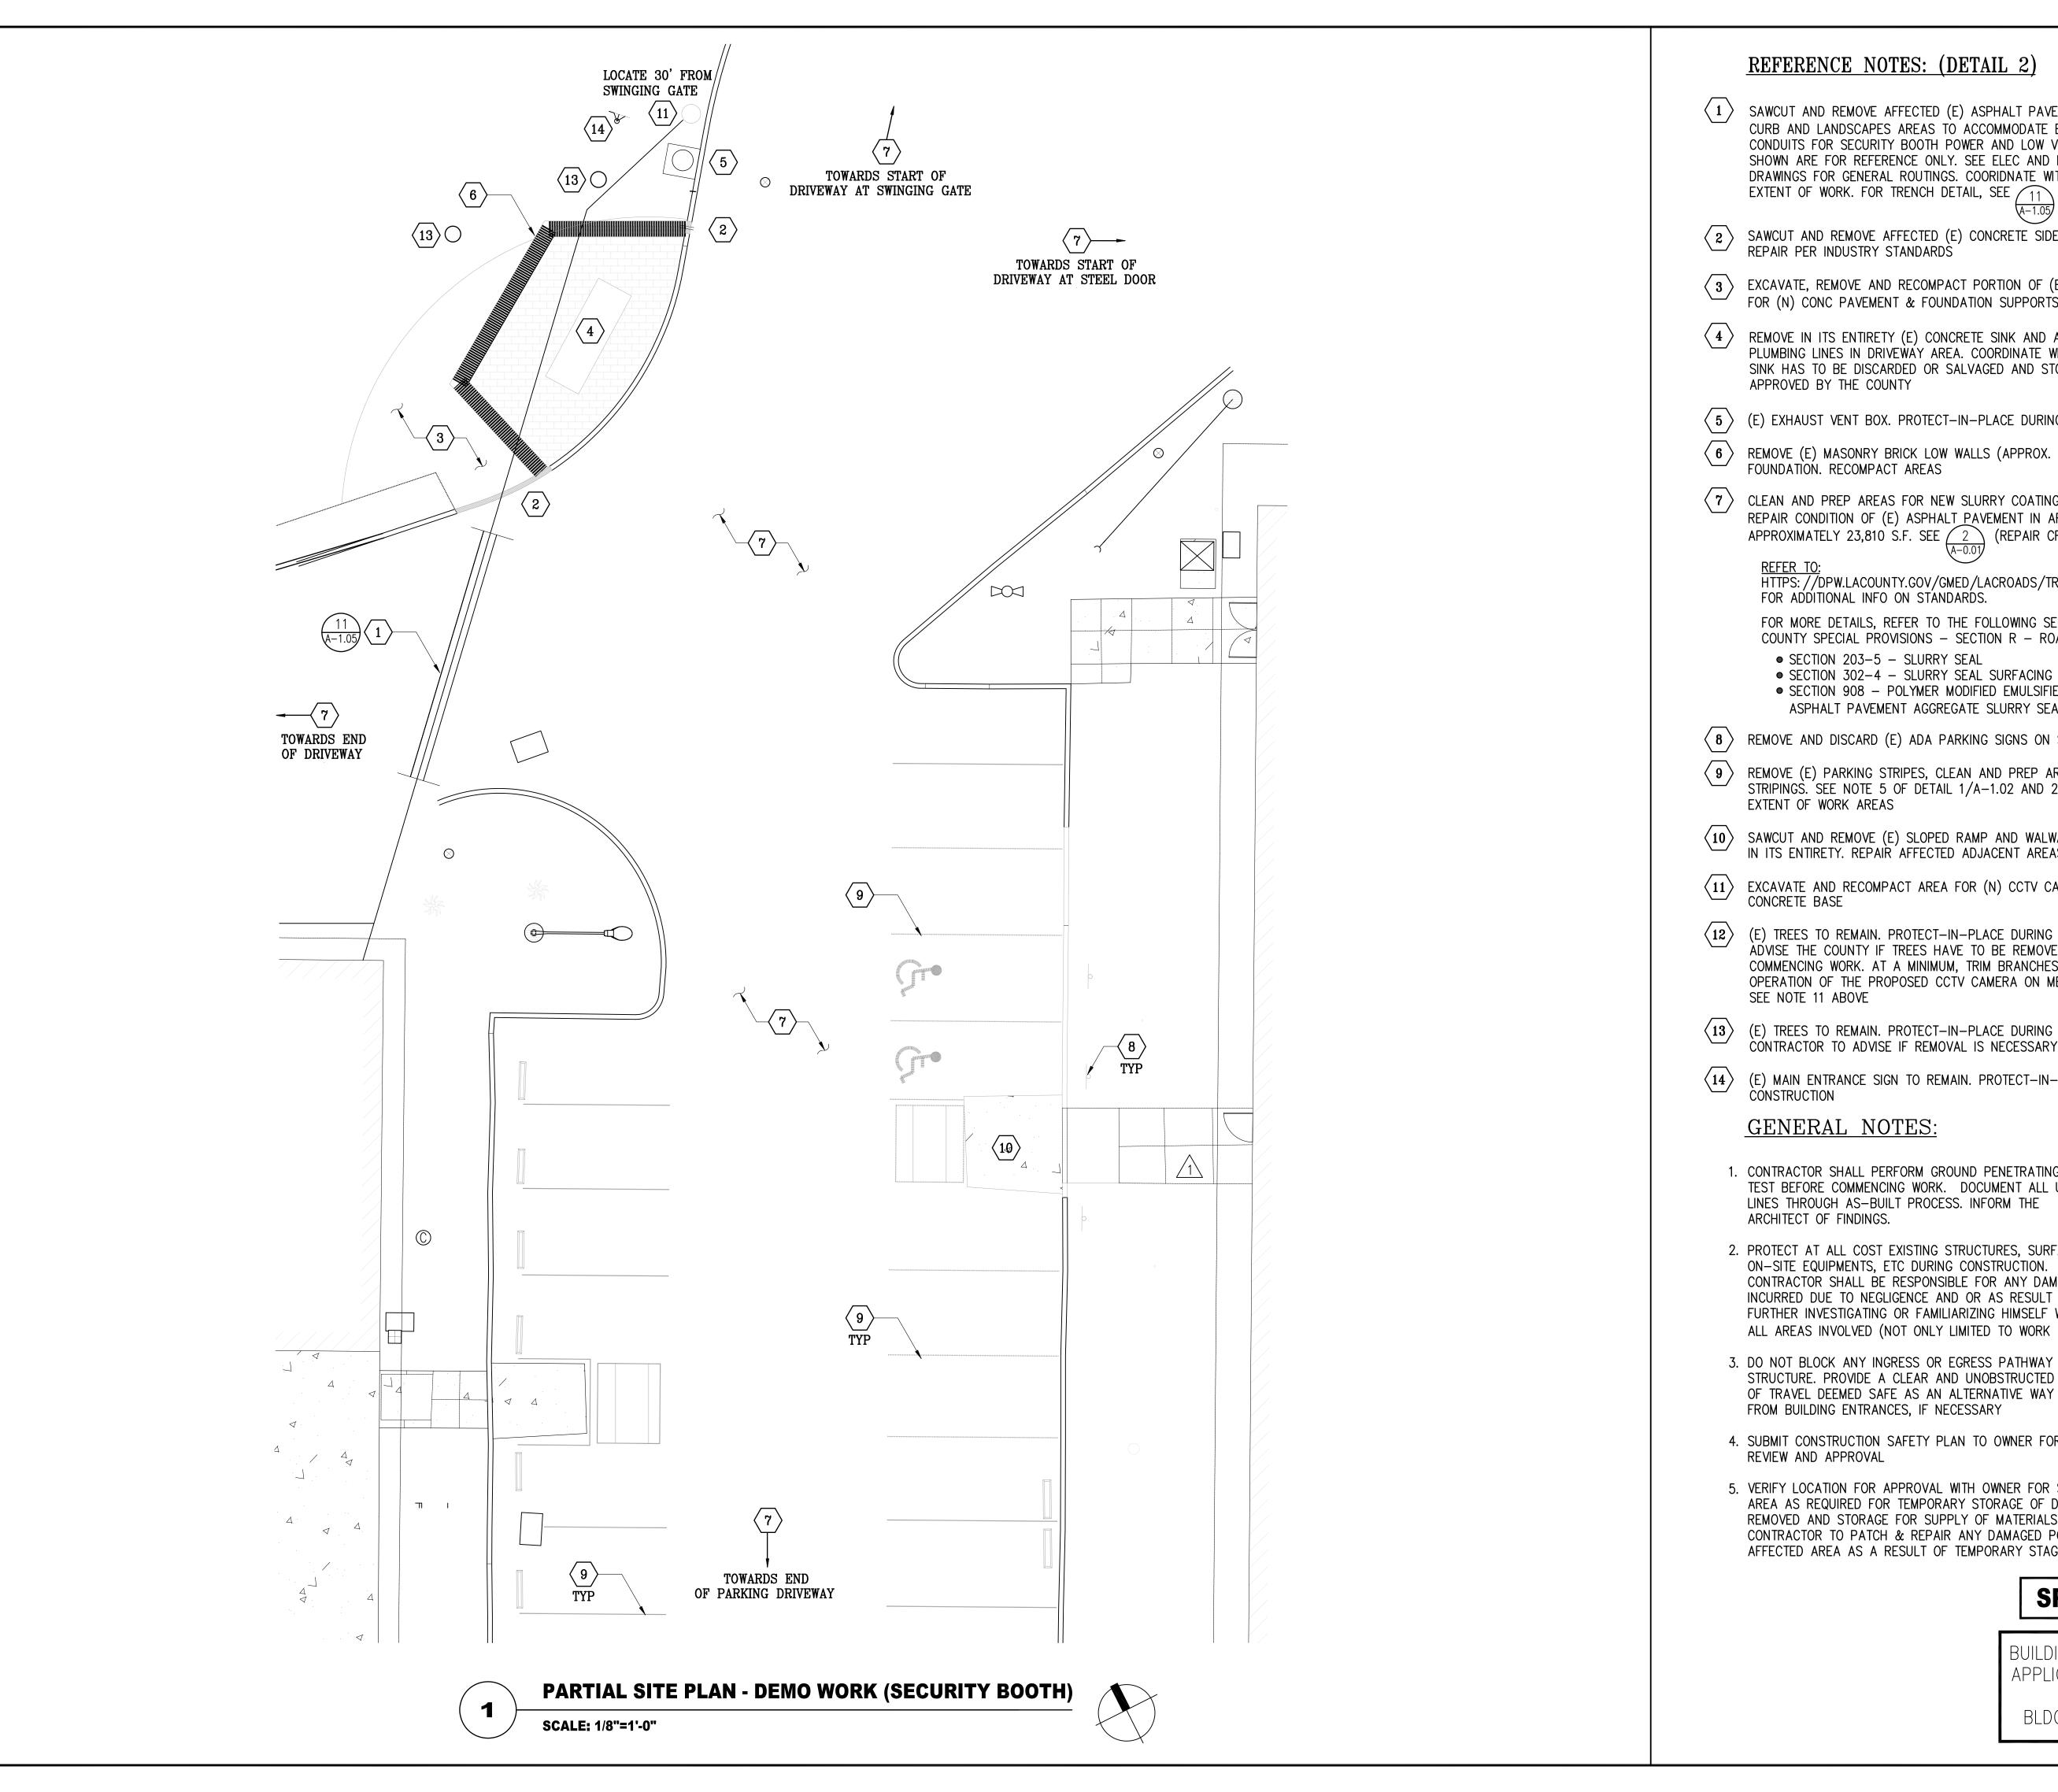
OVERALL SITE PLAN AREAS OF WORK

AS NOTED 02-06-25 DRAWN BY: JTC CHECKED BY: JTC

SHEET NUMBER:

A-0.00



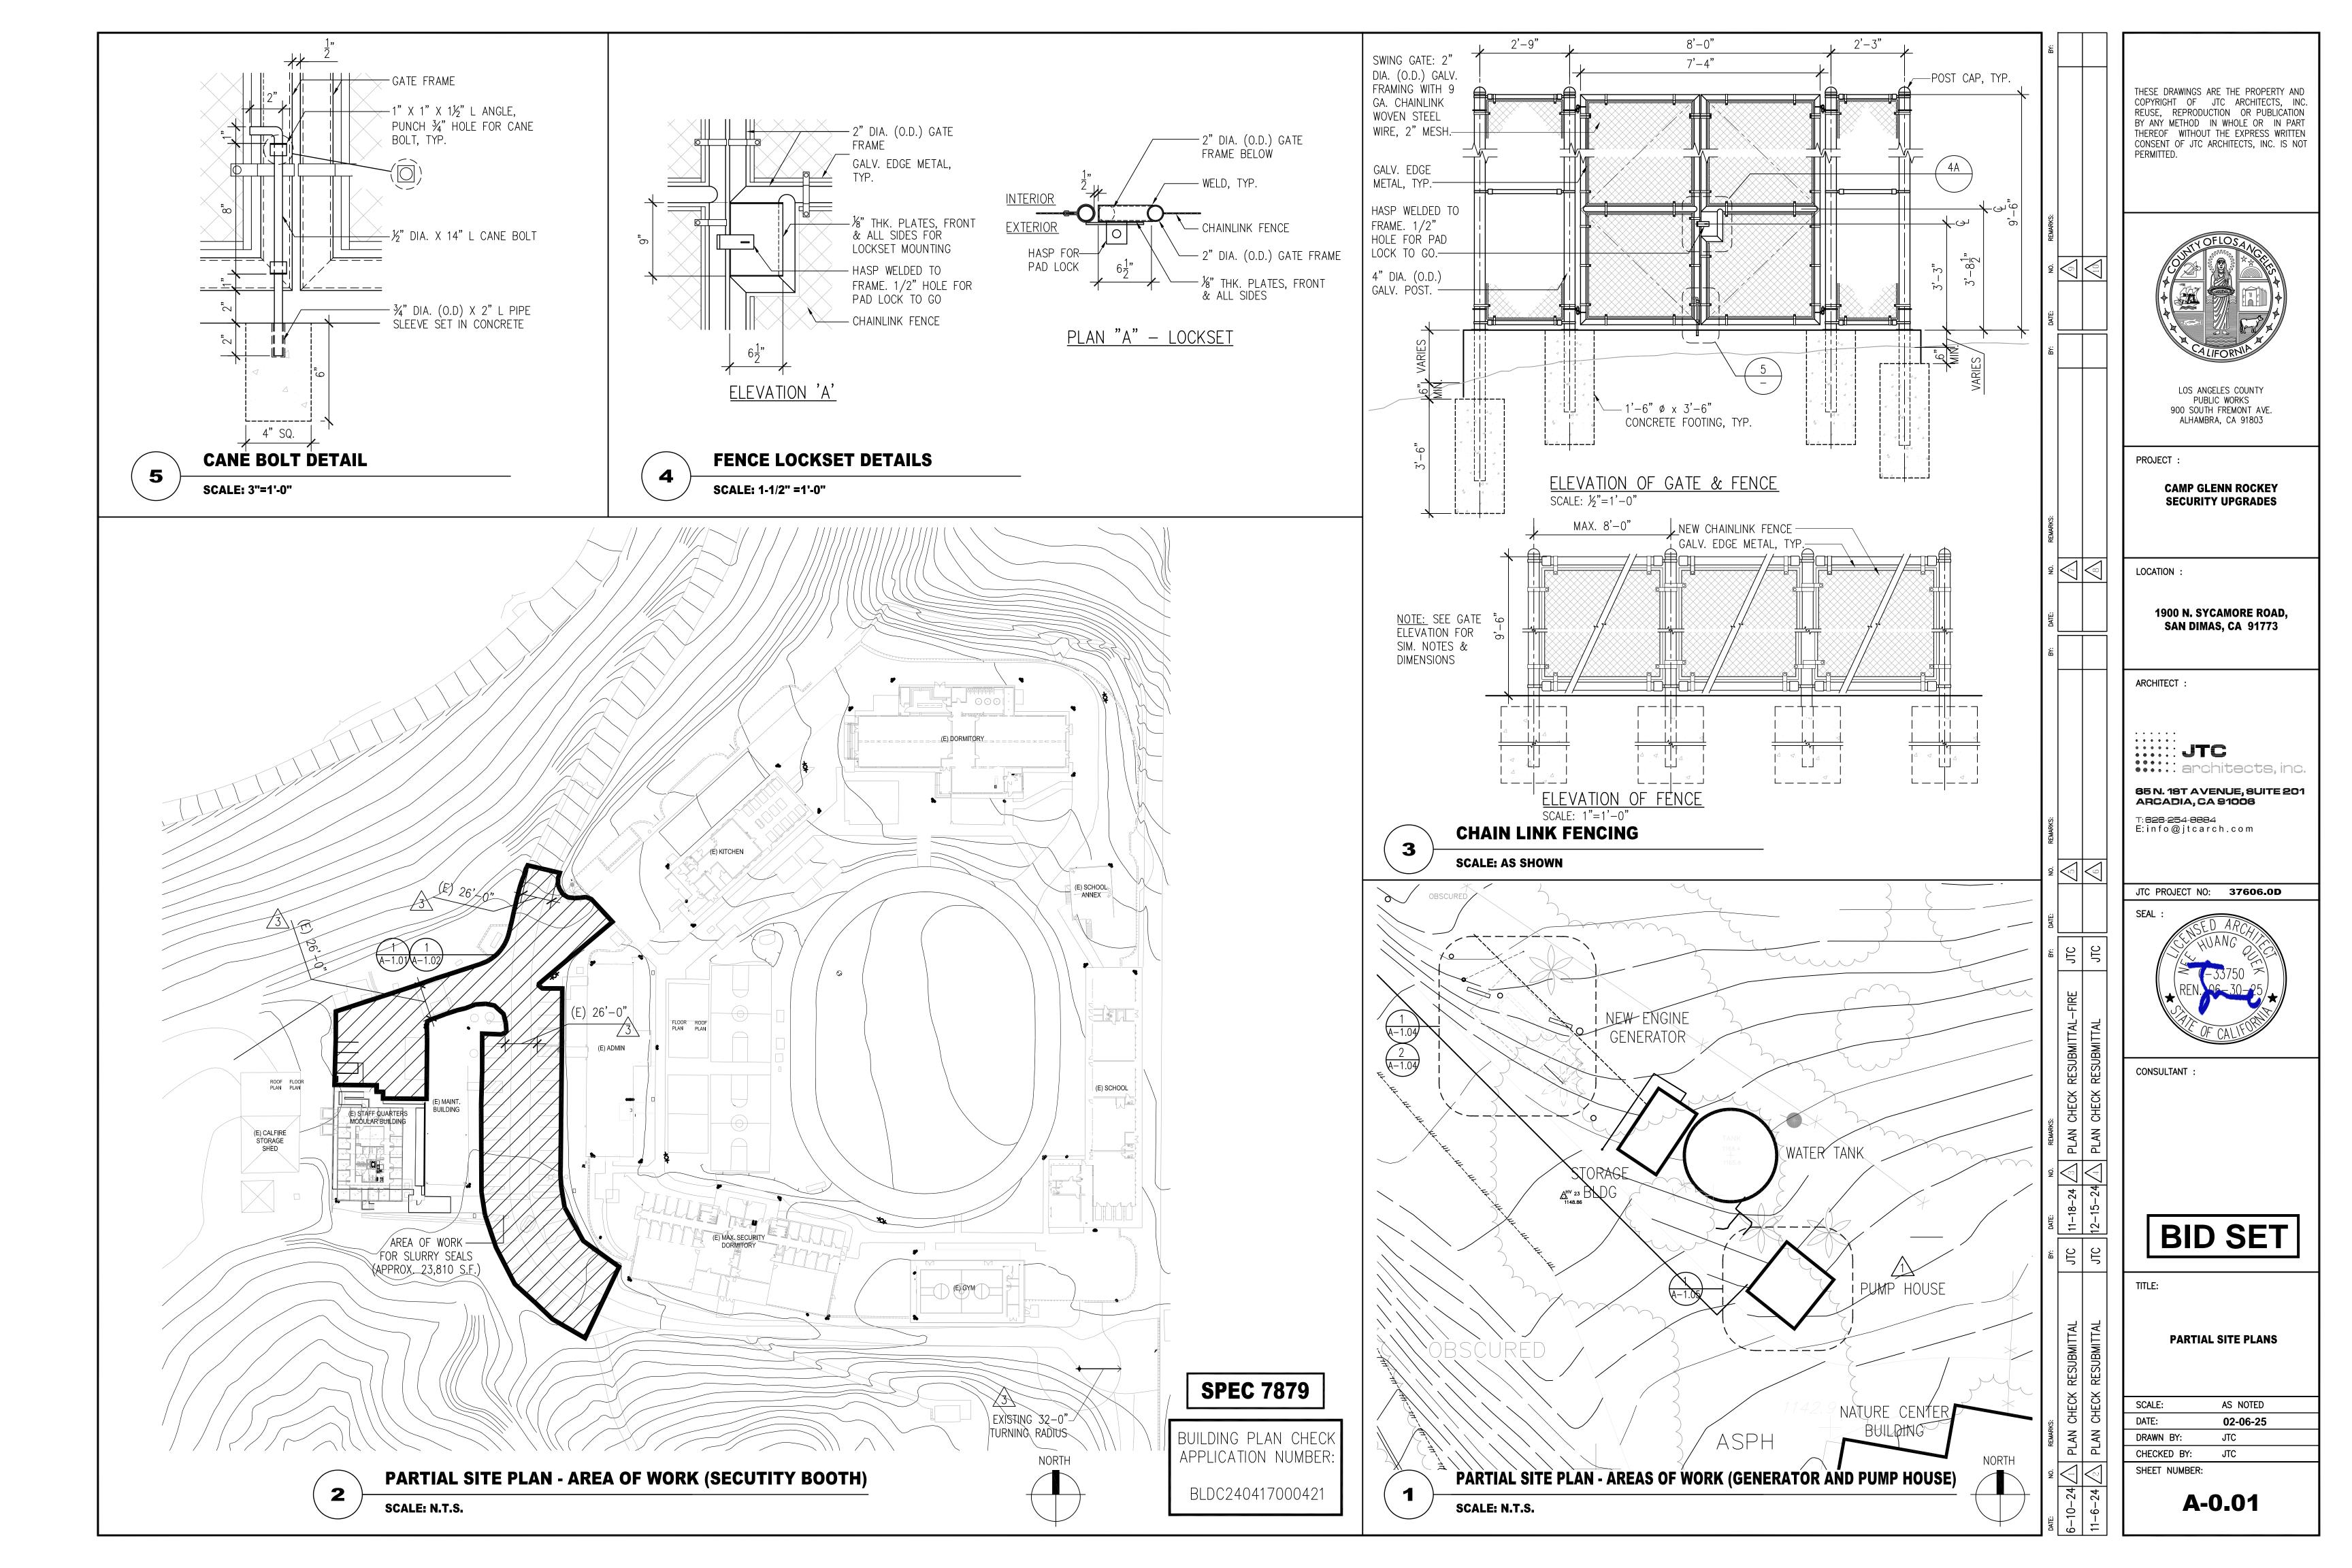

REFERENCE NOTES: (DETAIL 2)

- SAWCUT AND REMOVE AFFECTED (E) ASPHALT PAVEMENT, CONCRETE CURB AND LANDSCAPES AREAS TO ACCOMMODATE BELOW GROUND (N) CONDUITS FOR SECURITY BOOTH POWER AND LOW VOLTAGE. ROUTINGS SHOWN ARE FOR REFERENCE ONLY. SEE ELEC AND LOW VOLTAGE DRAWINGS FOR GENERAL ROUTINGS. COORIDNATE WITH OWNER FOR EXTENT OF WORK. FOR TRENCH DETAIL, SEE $\sqrt{11}$
- SAWCUT AND REMOVE AFFECTED (E) CONCRETE SIDEWALK. PATCH AND
- $\langle 3 \rangle$ EXCAVATE, REMOVE AND RECOMPACT PORTION OF (E) LANDSCAPED AREAS FOR (N) CONC PAVEMENT & FOUNDATION SUPPORTS (APPROX. 10,500 S.F.)
- 4 REMOVE IN ITS ENTIRETY (E) CONCRETE SINK AND ALL ACCESSORIES. CAP PLUMBING LINES IN DRIVEWAY AREA. COORDINATE WITH THE COUNTY IF SINK HAS TO BE DISCARDED OR SALVAGED AND STORED AT A LOCATION
- (E) EXHAUST VENT BOX. PROTECT-IN-PLACE DURING CONSTRUCTION
- 6 REMOVE (E) MASONRY BRICK LOW WALLS (APPROX. 46 L.F.) AND
- CLEAN AND PREP AREAS FOR NEW SLURRY COATING APPLICATIONS. REPAIR CONDITION OF (E) ASPHALT PAVEMENT IN AREAS OF WORK. APPROXIMATELY 23,810 S.F. SEE 2 (REPAIR CRACKS PER STANDARDS)

HTTPS: //DPW.LACOUNTY.GOV/GMED/LACROADS/TREATMENTSLURRYSEAL.ASPX

- FOR MORE DETAILS, REFER TO THE FOLLOWING SECTIONS OF LA COUNTY SPECIAL PROVISIONS - SECTION R - ROADWAY:
- SECTION 908 POLYMER MODIFIED EMULSIFIED ASPHALT-RECLAIMED ASPHALT PAVEMENT AGGREGATE SLURRY SEAL (PMERAPAS)
- (8) REMOVE AND DISCARD (E) ADA PARKING SIGNS ON STEEL POSTS
- 9 REMOVE (E) PARKING STRIPES, CLEAN AND PREP AREAS FOR (N) STRIPINGS. SEE NOTE 5 OF DETAIL 1/A-1.02 AND 2/A-0.01 FOR
- SAWCUT AND REMOVE (E) SLOPED RAMP AND WALWAY ENTRANCE IN ITS ENTIRETY. REPAIR AFFECTED ADJACENT AREAS OF WORK
- EXCAVATE AND RECOMPACT AREA FOR (N) CCTV CAMERA METAL POLE
- (E) TREES TO REMAIN. PROTECT—IN—PLACE DURING CONSTRUCTION. ADVISE THE COUNTY IF TREES HAVE TO BE REMOVED BEFORE COMMENCING WORK. AT A MINIMUM, TRIM BRANCHES TO ALLOW FOR THE OPERATION OF THE PROPOSED CCTV CAMERA ON METAL POLE.
- (E) TREES TO REMAIN. PROTECT-IN-PLACE DURING CONSTRUCTION. CONTRACTOR TO ADVISE IF REMOVAL IS NECESSARY WITH THE OWNER
- (E) MAIN ENTRANCE SIGN TO REMAIN. PROTECT-IN-PLACE DURING
- 1. CONTRACTOR SHALL PERFORM GROUND PENETRATING RADAR TEST BEFORE COMMENCING WORK. DOCUMENT ALL UTILITY LINES THROUGH AS-BUILT PROCESS. INFORM THE
- 2. PROTECT AT ALL COST EXISTING STRUCTURES, SURFACES, ON-SITE EQUIPMENTS, ETC DURING CONSTRUCTION. CONTRACTOR SHALL BE RESPONSIBLE FOR ANY DAMAGES INCURRED DUE TO NEGLIGENCE AND OR AS RESULT OF NOT FURTHER INVESTIGATING OR FAMILIARIZING HIMSELF WITH ALL AREAS INVOLVED (NOT ONLY LIMITED TO WORK AREAS)
- 3. DO NOT BLOCK ANY INGRESS OR EGRESS PATHWAY OF STRUCTURE. PROVIDE A CLEAR AND UNOBSTRUCTED PATH OF TRAVEL DEEMED SAFE AS AN ALTERNATIVE WAY TO AND FROM BUILDING ENTRANCES, IF NECESSARY
- 4. SUBMIT CONSTRUCTION SAFETY PLAN TO OWNER FOR
- 5. VERIFY LOCATION FOR APPROVAL WITH OWNER FOR STAGING AREA AS REQUIRED FOR TEMPORARY STORAGE OF DEBRIS REMOVED AND STORAGE FOR SUPPLY OF MATERIALS. CONTRACTOR TO PATCH & REPAIR ANY DAMAGED PORTION OF AFFECTED AREA AS A RESULT OF TEMPORARY STAGING AREA

SPEC 7879

BUILDING PLAN CHECK APPLICATION NUMBER

BLDC240417000421

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LOS ANGELES COUNTY PUBLIC WORKS 900 SOUTH FREMONT AVE. ALHAMBRA, CA 91803

PROJECT

CAMP GLENN ROCKEY SECURITY UPGRADES

LOCATION:

1900 N. SYCAMORE ROAD, SAN DIMAS, CA 91773

ARCHITECT

:::::JTC ••••• architects, inc.

65 N. 18T AVENUE, SUITE **20**1 ARCADIA, CA 91006

:626-254-8884 E:info@jtcarch.com

JTC PROJECT NO: 37606.0D

CONSULTANT :

BID SET

TITLE:


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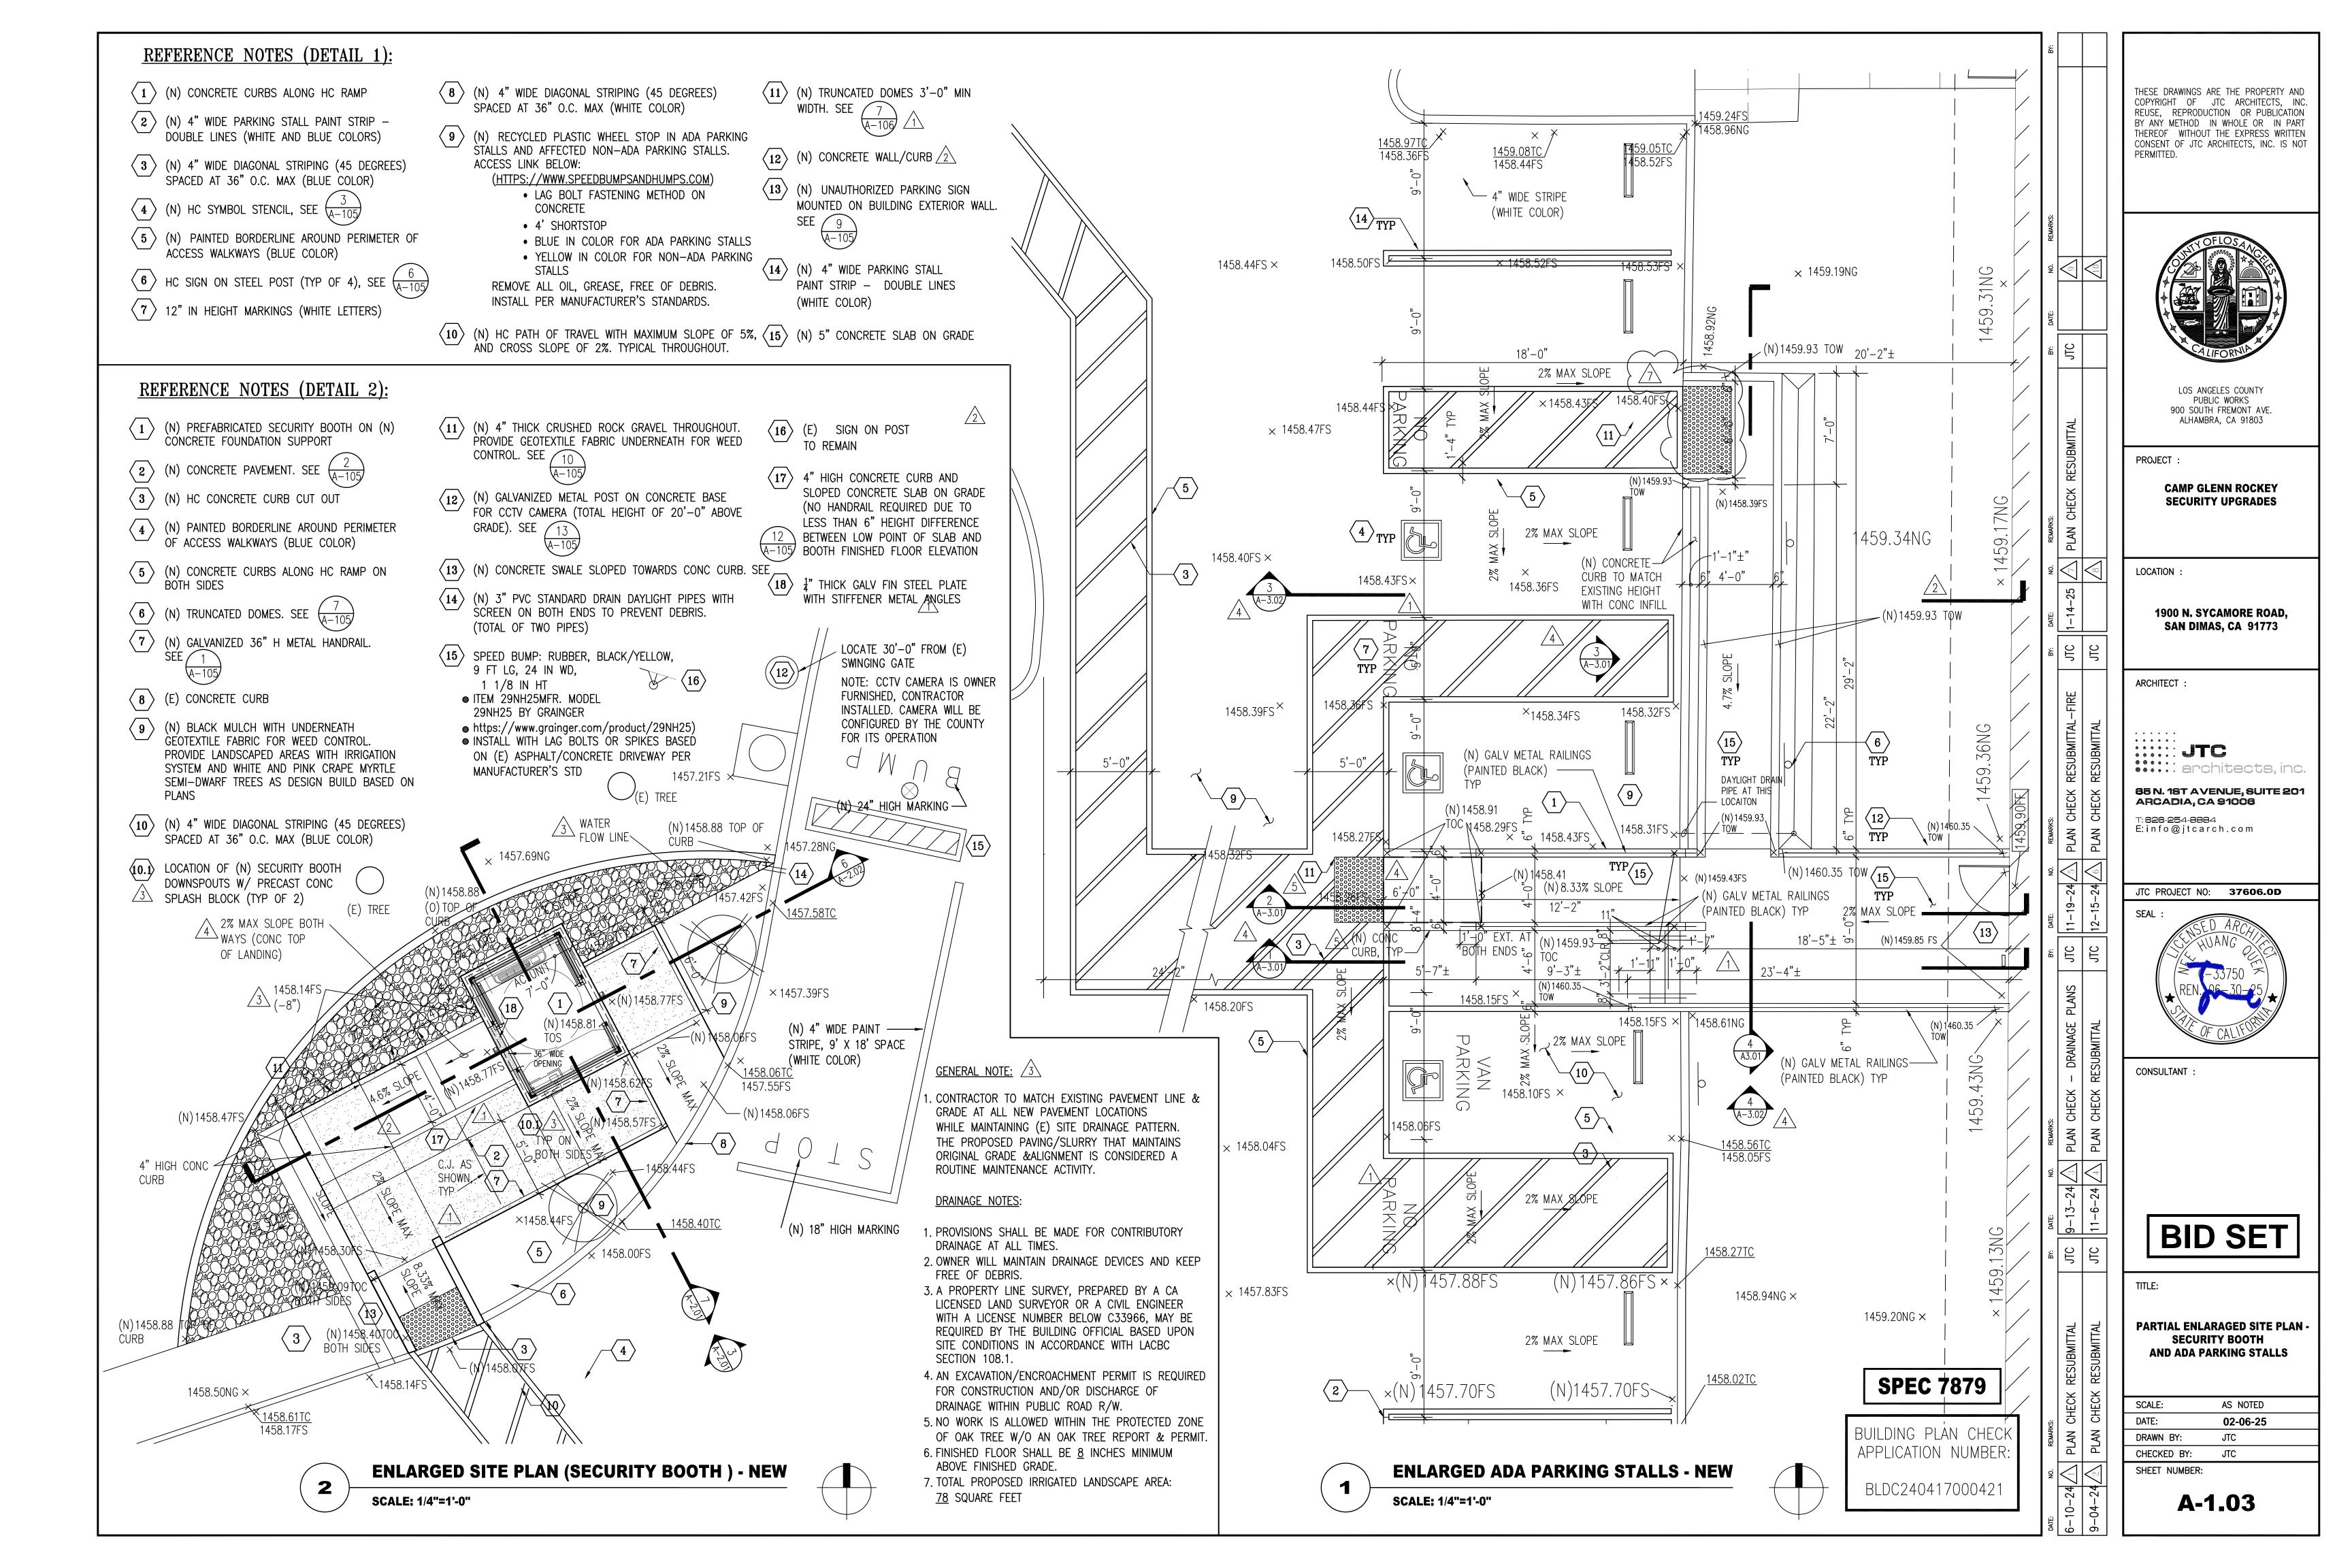
PARTIAL SITE PLAN **SECURITY BOOTH & ADA PARKING -DEMO WORK**


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A-1.01

SHEET NUMBER:





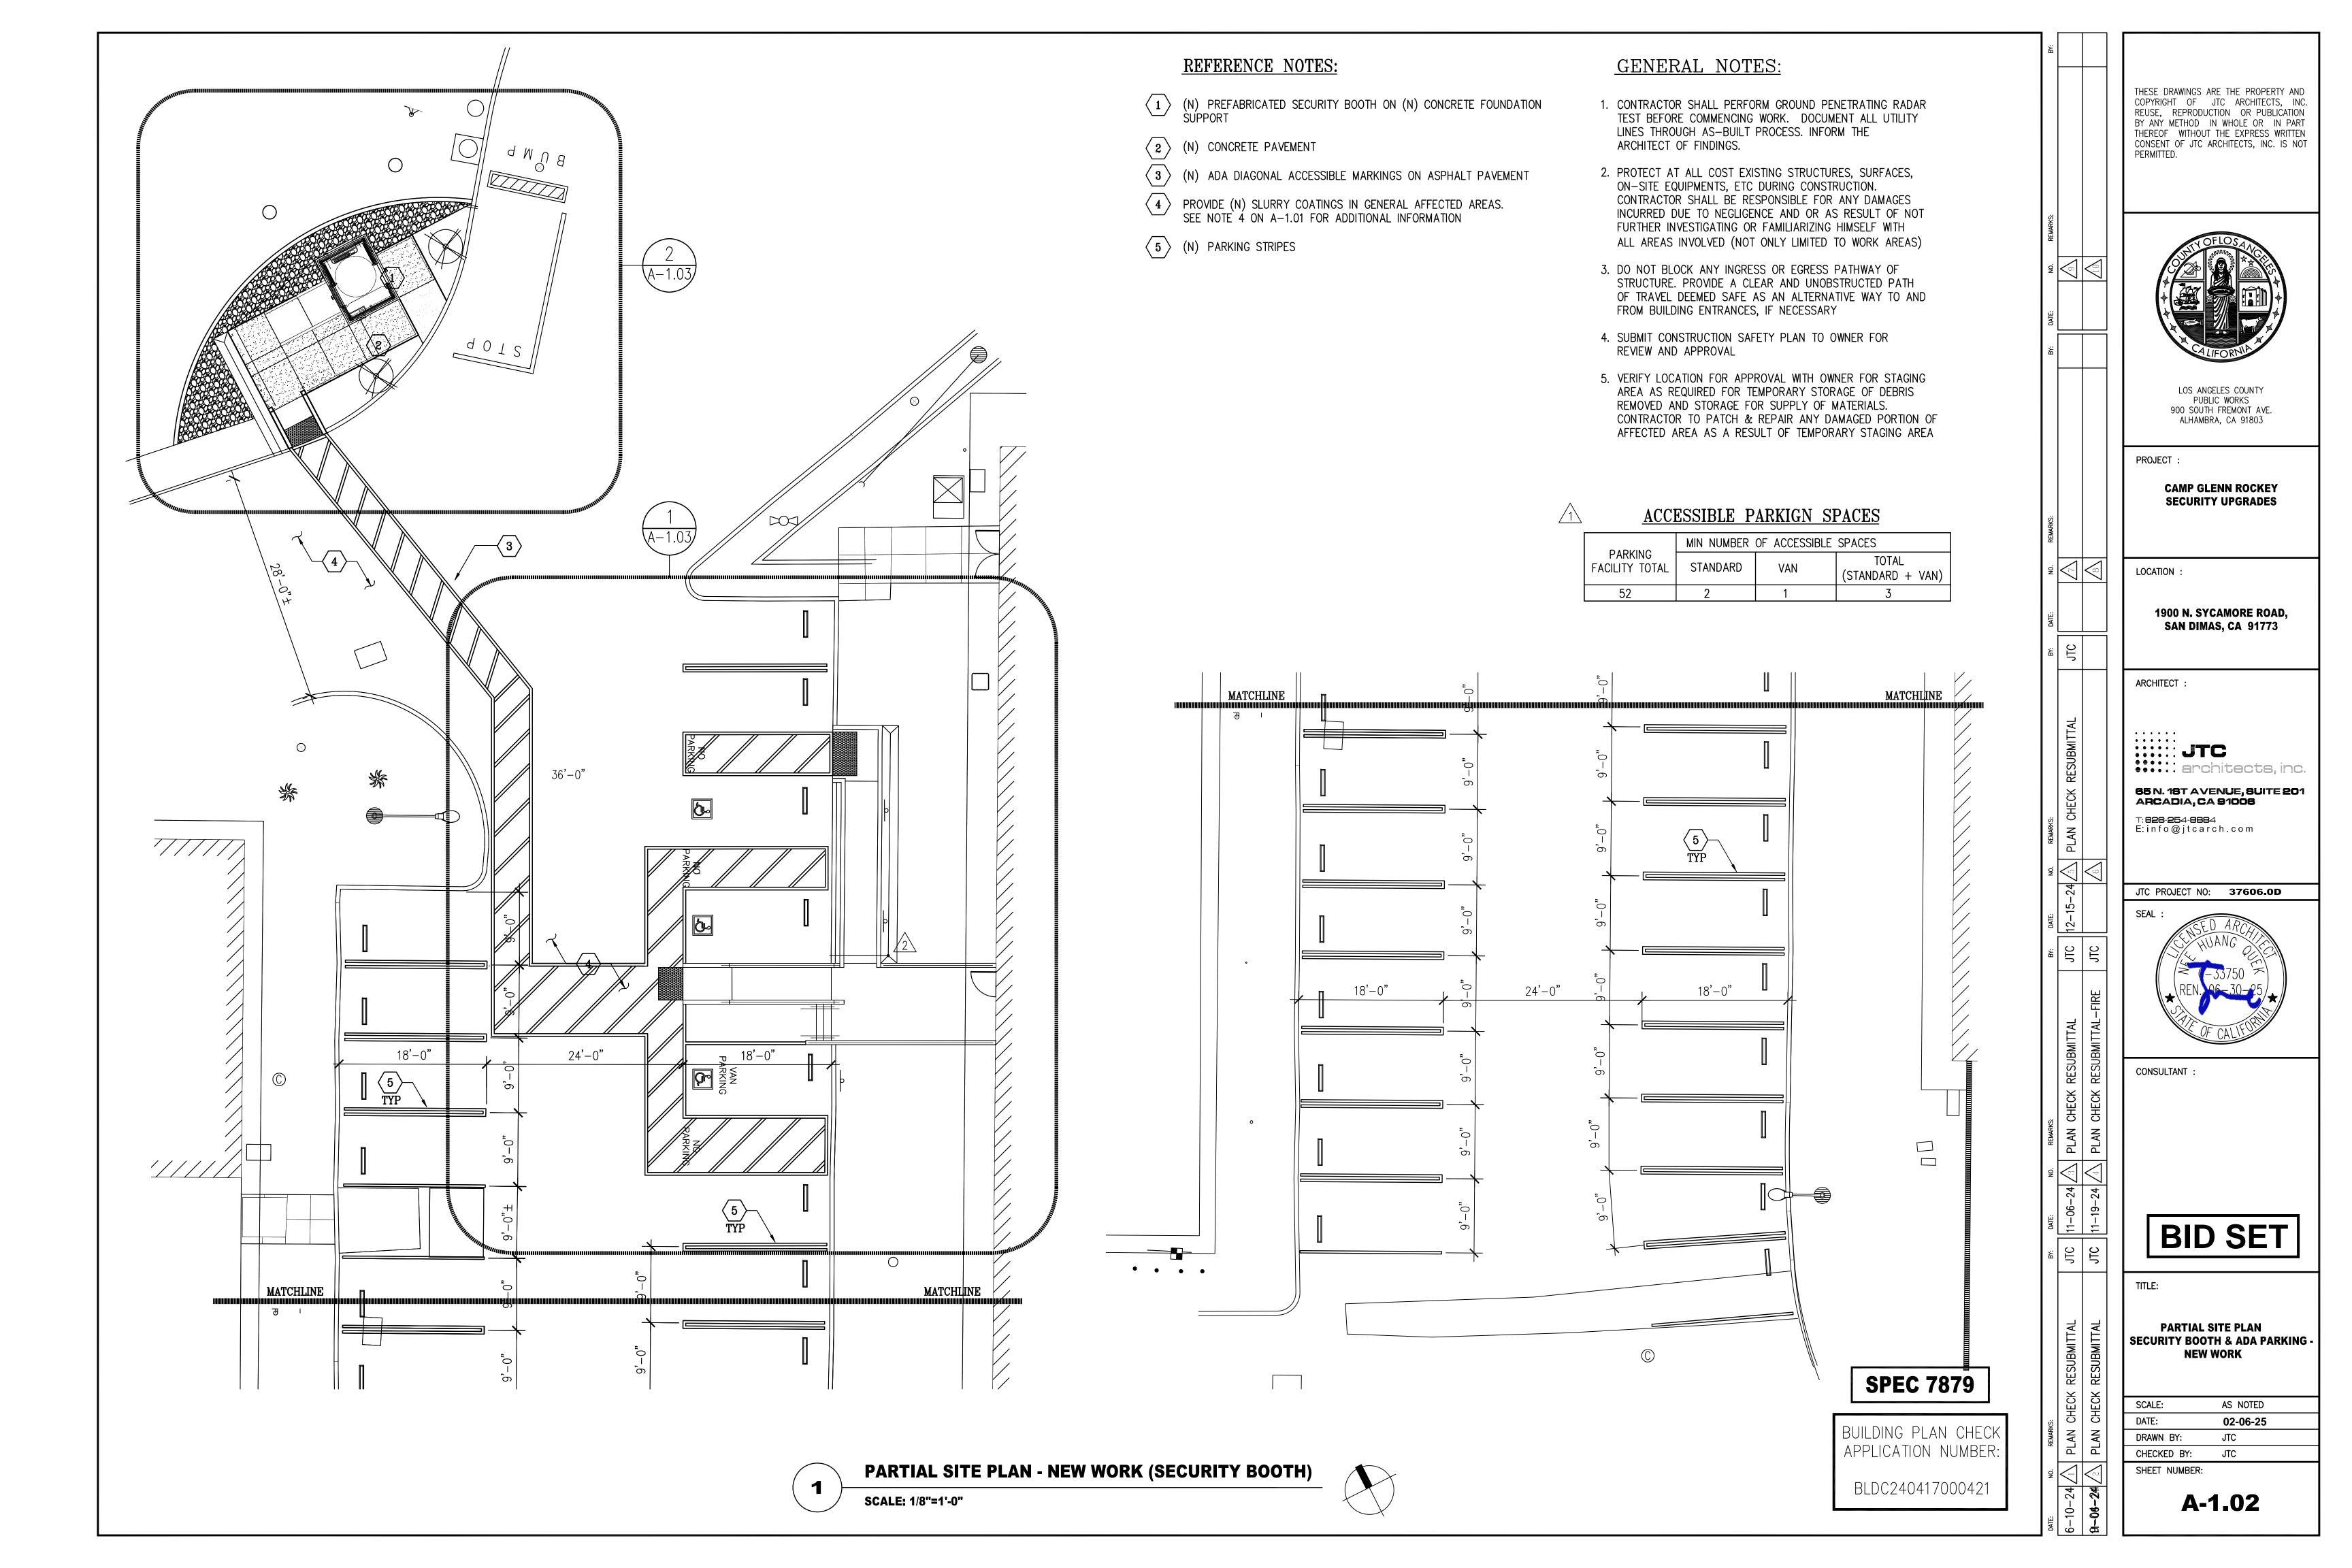

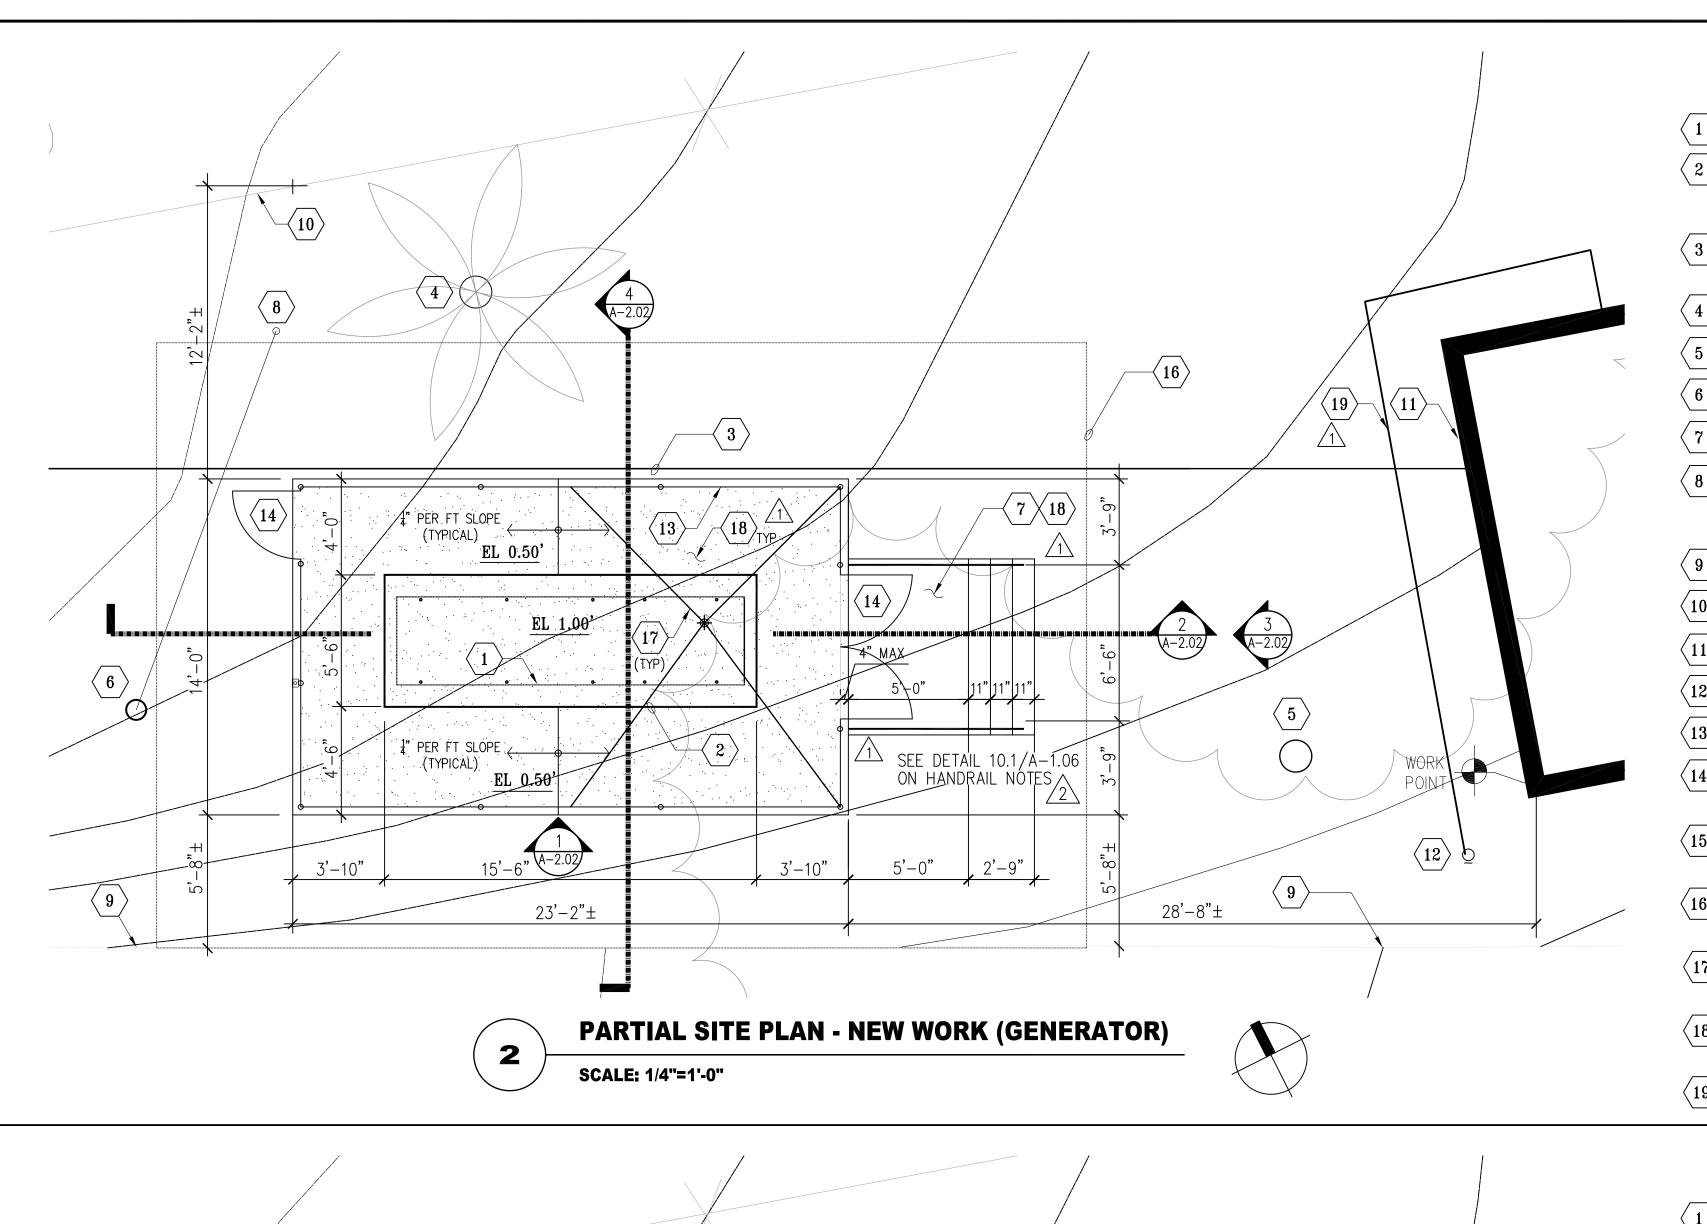 $\langle 7 \rangle$

PARTIAL SITE PLAN - DEMO WORK (GENERATOR)

EL 0.50'

EL 1.00'

23'-2"±

SCALE: 1/4"=1'-0"

 $\langle 12 \rangle$

 $\langle 17 \rangle$

9

 $\langle 2 \rangle$

 $\langle 10 \rangle$

EL 0.00'/

TYPICAL ON

 $\langle 6 \rangle$

 $\langle 18 \rangle$

ALL SIDES

(18)

 $\langle 13 \rangle$

28'-8"±

WOR

 $\langle 16 \rangle \dot{\nabla}$

REFERENCE NOTES

- (N) ENGINE GENERATOR SHOWN DASHED. SEE ELEC
- (N) CONCRETE FOUNDATION PAD. SEE STRUCTURAL. COORDINATE ACTUAL FOOTPRINT OF FOUNDATION PAD WITH APPROVED ENGINE GENERATOR SUBMITTAL AND REQUIRED CLEARANCES. SEE STRUCTURAL
- (E) 2" D.I. WATERLINE BELOW GRADE. SEE 3/A2.02 FOR ADDITIONAL
- $\langle 4 \rangle$ (E) 16"ø PALM TREE
- $\langle 5 \rangle$ (E) 16"ø PINE TREE
- $\langle 6 \rangle$ (E) 10" POWER POLE. PROTECT-IN-PLACE DURING CONSTRUCTION
- \langle 7 \rangle (N) CONCRETE STEPS AND LANDING W/ GALVANIZED RAILINGS
- (E) GUY WIRE SUPPORT. PROTECT-IN-PLACE DURING CONSTRUCTION COORDINATE WITH UTILITY COMPANY IF RELOCATION OF GUY WIRE SUPPORT IS NECESSARY
- $\langle 9 \rangle$ (E) ASPHALT CURB
- $\langle 10 \rangle$ (E) CHANLIK FENCE. PROTECT-IN-PLACE DURING CONSTRUCTION
- (E) METAL STRUCTURE. DO NOT BLOCK ENTRANCE INTO STRUCTURE
- $\langle 12 \rangle$ (E) FIRE HYDRANT
- $\langle 13 \rangle$ (N) 9'-6" HIGH GALVANIZED CHAINLINK FENCE AND POSTS
- (N) GALVANIZED CHAINLINK FENCE ACCESS GATE PANELS (3'-0" W AND PAIR OF 3'-0" W)
- TYPICAL 4'-0" CLEARANCE AROUND (N) ENGINE GENERATOR. PROVIDE 4'-6" CLEARANCE ON SOUTH SIDE
- (16) REGRADE (E) AFFECTED AREAS TO THEIR ORGINAL FINISHED ELEVATION. SLOPE TOWARDS NATURAL FLOW FOR AREA DRAINAGE.
- $\langle 17 \rangle$ (N) STEEL GUIDE WIRES FOR BRACING VENT PIPE PER ENGINE MÁNUFACTURER.
- PROVIDE #4 REBARS AT 18" O.C. EACH WAY IN CONCRETE SLAB ON
- $\langle 19 \rangle$ (E) WATERLINE BELOW GRADE FROM FIRE HYDRANT TO BLDG STRUCTURE /1

GENERAL NOTES:

- 1. CONTRACTOR SHALL PERFORM GROUND PENETRATING RADAR TEST BEFORE COMMENCING WORK. DOCUMENT ALL UTILITY LINES THROUGH AS-BUILT PROCESS. INFORM THE ARCHITECT OF FINDINGS.
- 2. PROTECT AT ALL COST EXISTING STRUCTURES, SURFACES, ON-SITE EQUIPMENTS, ETC DURING CONSTRUCTION. CONTRACTOR SHALL BE RESPONSIBLE FOR ANY DAMAGES INCURRED DUE TO NEGLIGENCE AND OR AS RESULT OF NOT FURTHER INVESTIGATING OR FAMILIARIZING HIMSELF WITH ALL AREAS INVOLVED (NOT ONLY LIMITED TO WORK AREAS)
- 3. DO NOT BLOCK ANY INGRESS OR EGRESS PATHWAY OF STRUCTURE. PROVIDE A CLEAR AND UNOBSTRUCTED PATH OF TRAVEL DEEMED SAFE AS AN ALTERNATIVE WAY TO AND FROM BUILDING ENTRANCES, IF NECESSARY
- 4. SUBMIT CONSTRUCTION SAFETY PLAN TO OWNER FOR REVIEW AND APPROVAL
- 5. VERIFY LOCATION FOR APPROVAL WITH OWNER FOR STAGING AREA AS REQUIRED FOR TEMPORARY STORAGE OF DEBRIS REMOVED AND STORAGE FOR SUPPLY OF MATERIALS. CONTRACTOR TO PATCH & REPAIR ANY DAMAGED PORTION OF AFFECTED AREA AS A RESULT OF TEMPORARY STAGING AREA
- 6. NOTE OF IMPORTANCE CONSTRUCTION SCHEDULE SHALL TAKE INTO ACCOUNT SEQUENCING OF ACTIVITIES OUTSIDE OF RED-TAILED HAWK NESTING PERIOD FROM JAN. 15 THRU SEPT 15. CONSTRUCTION NOISE SHALL ALSO NE REQUIRED TO BE LIMITED IN CERTAIN TIMES. A PRECONSTRUCTION STUDY AND A BIOLOGIST MONITORING SERVICES SHALL BE ADDED DURING CONSTRUCTION
- 7. CONTRACTOR PARKING IS NOT AVAILABLE FOR THE INSTALLATION OF THE ENGINE GENERATOR NEAR THE NATURE CENTER BUILDING

TRIMMING OF TREES: PROVIDE AN ALLOWANCE TO TRIM (E) TREES DIRECTLY OVERHEAD WITHIN 10 FT OF (N) CHAINLINK FENCE ENCLOSURE

REFERENCE NOTES

- EXCAVATE, REMOVE AND RECOMPACT PORTION OF (E) LANDSCAPED AREAS FOR (N) CONCRETE SLAB ON GRADE AND FOUNDATION SUPPORTS
- $\langle 2 \rangle$ CLEAR GENERAL AREAS FREE OF DEBRIS
- $\langle 3 \rangle$ (N) ENGINE GENERATOR SHOWN DASHED FOR REFERENCE
- 4 NOT USED
- (E) 2" D.I. WATERLINE BELOW GRADE. SEE 3/A2.02 FOR 2ADDITIONAL NOTES
- REMOVE (E) 16"Ø PALM TREE IN ITS ENTIRETY. UPON REMOVAL OF ROOTS, FILL ROOT HOLE WITH DIRT THEN 95% RECOMPACT AND ALL AFFECTED SURROUNDINGS (TYPICAL)
- $\langle \gamma \rangle$ (E) 20"ø PINE TREE (REMOVE)
- (E) 16"ø PINE TREE
- (E) 15"ø PINE TREE (REMOVE)
- $\langle 10 \rangle$ (E) 10" Ø POWER POLE. PROTECT-IN-PLACE DURING CONST.
- TEMPORARY CONSTRUCTION FENCE BARRIER. FOOTPRINT SHOWN FOR REFERENCE ONLY. CONTRACTOR SHALL ENSURE SAFETY OF THE PUBLIC AT ALL TIMES DURING AND AFTER CONSTRUCTION
- (E) GUY WIRE SUPPORT. PROTECT-IN-PLACE DURING CONSTRUCTION
- $\langle 13 \rangle$ (E) ASPHALT CURB
- (E) CHAINLINK FENCE. PROTECT—IN—PLACE DURING CONST/
- (E) METAL STRUCTURE. DO NOT BLOCK ENTRANCE INTO STRUCTURE
- $\langle 16 \rangle$ (E) FIRE HYDRANT
- $\langle 17 \rangle$ REMOVE (E) WOOD BENCHES IN THEIR ENTIRETY. COORDINATE WITH THE OWNER IF THESE WILL BE DISCARDED OR RELOCATED
- (E) WATERLINE BELOW GRADE FROM FIRE HYDRANT TO BLDG STRUCTURE 1

SAWCUT AND REMOVE AFFECTED (E) ASPHALT PAVEMENT CONCRETE CURB AND LANDSCAPES AREAS TO ACCOMMODATE BELOW GROUND (N) CONDUITS FOR SECURITY BOOTH POWER AND LOW VOLTAGE. ROUTINGS SHOWN ARE FOR REFERENCE ONLY. SEE ELEC AND LOW VOLTAGE DRAWINGS FOR GENERAL ROUTINGS. COORIDNATE WITH OWNER FOR EXTENT OF WORK. FOR TRENCH DETAIL, SEE 11

NOTES ON THE EMERGENCY ENGINE GENERATOR:

- DESIGN DRAWINGS FOR THE SUPPORT OF THE EMERGENCY ENGINE GENERATOR ARE BASED ON 125REOZJG WITH SOUND ENCLOSURE AND 316g SUBBASE STATE TANK AS MANUFACTURED BY KOHLER POWER SYSTEM
- SUBMIT TO YOUR CHOOSING ANOTHER MANUFACTURER BASED ON "OR APPROVED EQUAL"
 - CONTRACTOR SHALL PROVIDE STRUCTURAL SUPPORT DESIGN FOR THE SUBSTITUTE
 - DESIGN SHALL BE STAMPED BY A CALIFORNIA STATE LICENSED STRUCTURAL ENGINEER HIRED BY THE CONTRACTOR
 - SUBMIT TO ARCHITECT OF RECORDS FOR PEER
 - REVIEW - CONTRACTOR SHALL SUBMIT THE SUBSTITUTED DESIGN PACKAGE WITH STRUCTURAL CALCULATIONS TO LADPW BUILDING DEPT. FOR APPROVAL PRIOR TO COMMENCING WORK
 - CONTRACTOR SHALL COORDINATE WITH ALL AFFECTED TRADES ALL DEVIATIONS TO THEIR WORK DUE TO THE SUBSTITUTE
 - THERE SHALL BE NO ADDITIONAL COST INCURRED TO THE OWNER DUE TO YOUR CHOOSING
 - THERE SHALL BE NO CHANGE TO THE CONSTRUCTION SCHEDULE
 - REFER TO ELECTRCIAL DRAWINGS FOR ADDITIONAL NOTES

BUILDING PLAN CHECK APPLICATION NUMBER:

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ARCHITECT

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CONSULTANT:

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TITLE:


PARTIAL ENLARGED SITE PLANS ENGINE GENERATOR -DEMO AND NEW


AS NOTED DATE: 02-06-25

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A-1.04

SPEC 7879




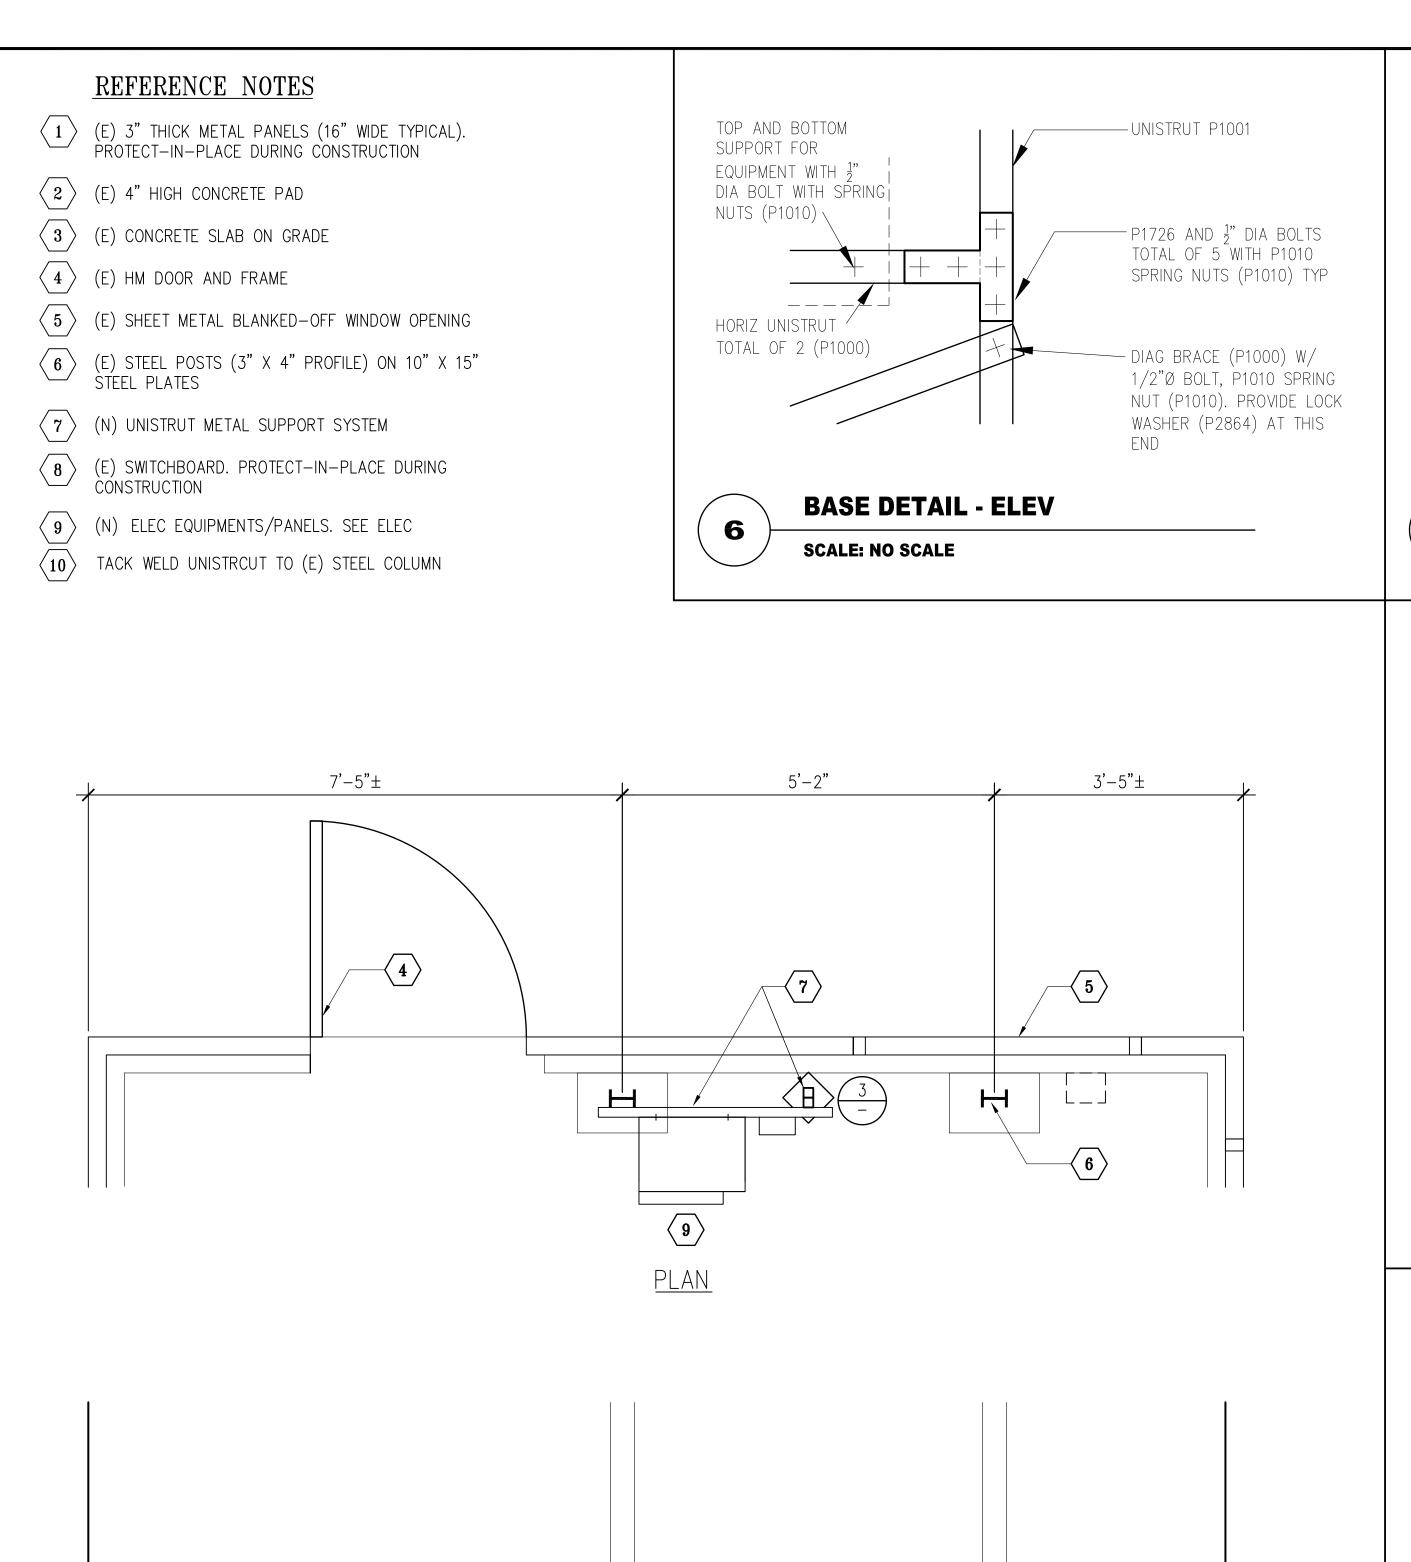


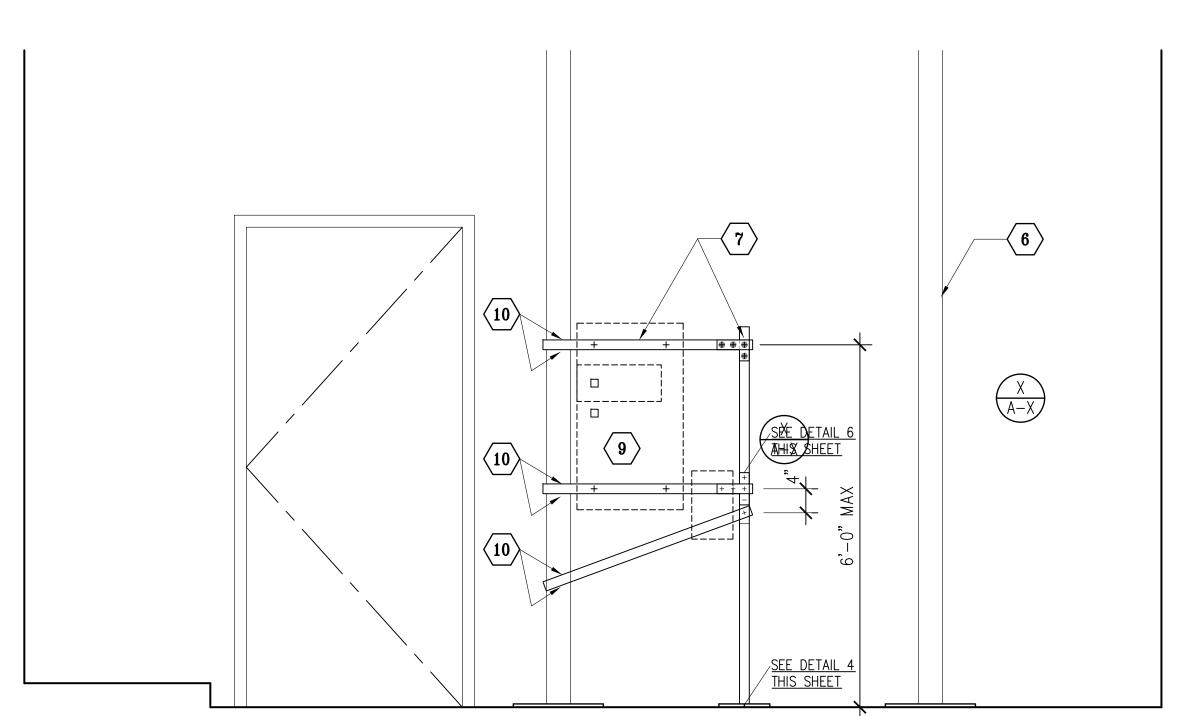
ELEVATION


SCALE: 3/4"=1'-0"

STEEL FRAME SUPPORT DETAIL

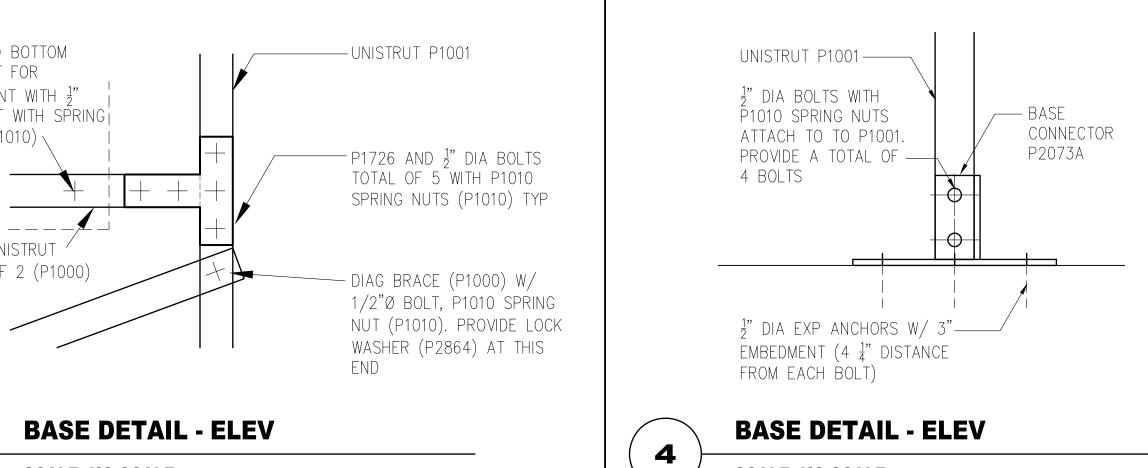

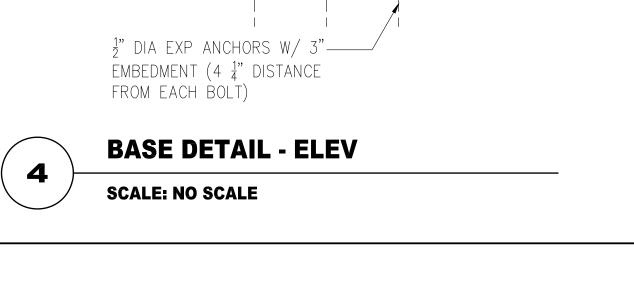

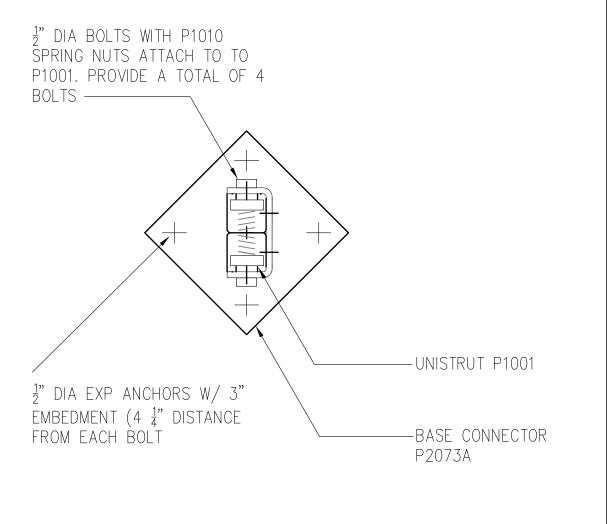

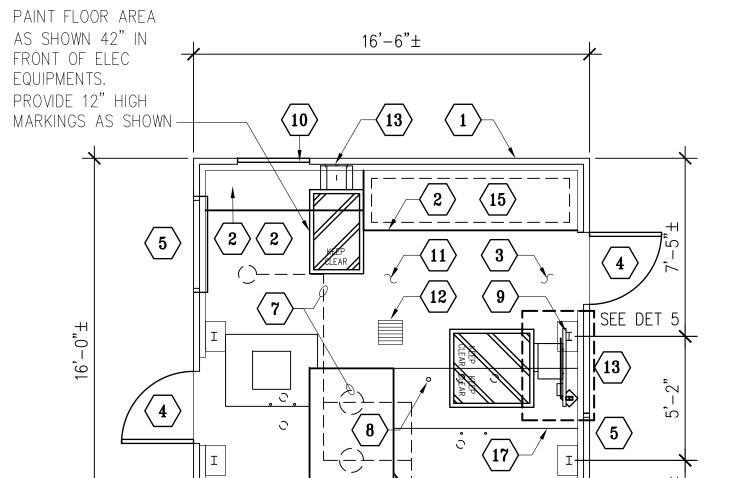

BASE DETAIL - PLAN

SCALE: NO SCALE

3

 $\langle 15 \rangle$ (E) SWITCHBOARD. PROTECT-IN-PLACE DURINF

- (E) SHEET METAL BLANKED-OFF DOOR OPENING
- $\langle 17 \rangle$ (E) ISOLATION JOINT IN CONCRETE FLOOR SLAB
- REMOVE (E) OUTDOOR MTS AND ITS SUPPORTS IN THEIR ENTIRETY.


- 1. REFER TO UL THROUGH PENETRATION FIRESTOP DETAIL, REFERENCED BELOW, FOR INFO NOT SHOWN HEREIN
- 2. F RATING = 4 HOUR
- T RATING = O HOUR
- 3. MAXIMUM DIAMETER (ϕ) OF OPENING = 8"
- 4. ANNULAR MINIMUM OPENING = 1/2" ANNULAR MAXIMUM OPENING = 1-1/4"

GENERAL NOTES, THIS DETAIL

5. PIPE, CONDUIT, OR TUBING TO BE RIGIDLY SUPPORTED ON BOTH SIDES OF WALL/PARTITION ASSEMBLY

KEYED REFERENCE NOTES, THIS DETAIL X

- 1. WALL/PARTITION ASSEMBLY: 1-HOUR RATING DESIGNATION
- 2. SINGLE CONCENTRIC OR ECCENTRIC THROUGH PENETRANT:
- A) STEEL PIPE: NOM MAX 6"Ø (SCHD 10 OR HEAVIER)
- B) STEEL CONDUIT: NOM MAX 4"Ø (STEEL EMT)
- C) COPPER TUBING: NOM MAX 6"ø (TYPE L OR HEAVIER)
- D) COPPER PIPE: NOM MAX 6"Ø (REGULAR OR HEAVIER)
- 3. FILL MATERIAL (SEALANT): MIN 1-1/2" THICK, APPLIED WITHIN ANNULUS, FLUSH WITH BOTH SURFACE OF WALL/PARTITION
- 4. NOM 8"ø (OR SMALLER) SCHD 40 (OR HEAVIER) FRICTION FIT; STEEL SLEEVE: SLEEVE LENGTH EQUAL TO PARTITION

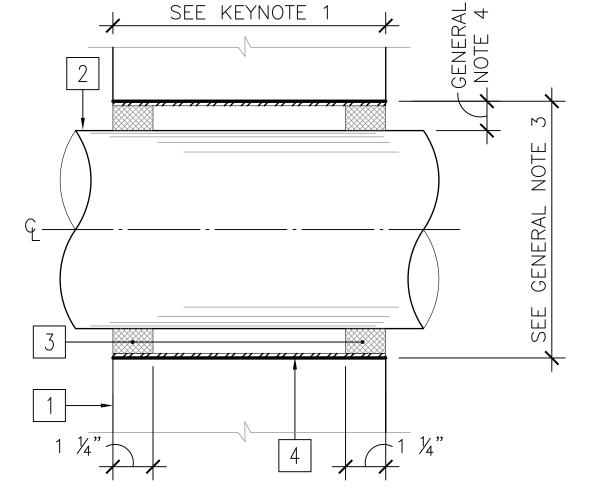

WALL PENETRATION DETAILS

SCALE: NO SCALE

REFERENCE NOTES

(E) 3" THICK METAL PANELS (16" WIDE TYPICAL). PROTECT—IN—PLACE DURING CONSTRUCTION

- $\langle 2 \rangle$ (E) 4" HIGH CONCRETE PAD
- $\langle 3 \rangle$ (E) CONCRETE SLAB ON GRADE
- $\langle 4 \rangle$ (E) HM DOOR AND FRAME
- $\langle 5 \rangle$ (E) SHEET METAL BLANKED-OFF WINDOW OPENING
- (E) CONCRETE BASE ALL AROUND PERIMETER OF STRUCTURE
- $\langle 7 \rangle$ (E) WATER PUMPS WITH ASSOCIATED PIPING AND
- \langle 8 \rangle (E) CONDUIT STUB OUTS. CUT AND CAP CONDUITS ÀS CLOSE TO FLOOR
- (E) STEEL POSTS (3" X 4" PROFILE) ON 10" X 15" STEEL PLATES
- $\langle 10 \rangle$ (E) EQUIPMENTS/PANELS. SEE ELEC
- CLEAN ENTIRE FLOOR AREA FREE OF DIRT AND DEBRIS
- (E) AREA DRAIN
- $\langle 13 \rangle$ (N) ELEC EQUIPMENTS/PANELS. SEE ELEC
- $\langle 14 \rangle$ (E) WINDOW GLAZING IN METAL FRAME



BUILDING PLAN CHECK APPLICATION NUMBER:

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PROJECT:

CAMP GLENN ROCKEY SECURITY UPGRADES

LOCATION:

1900 N. SYCAMORE ROAD, SAN DIMAS, CA 91773

ARCHITECT

.....JTC ****** architects, inc.

65 N. 18T AVENUE, SUITE 201

ARCADIA, CA 91006

T:**626-254-8884** E:info@jtcarch.com

JTC PROJECT NO: **37606.0D**

CONSULTANT:

BID SET

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ENLARGED PUMP HOUSE FLOOR PLAN - NEW WORK

AS NOTED 02-06-25 DRAWN BY: CHECKED BY:


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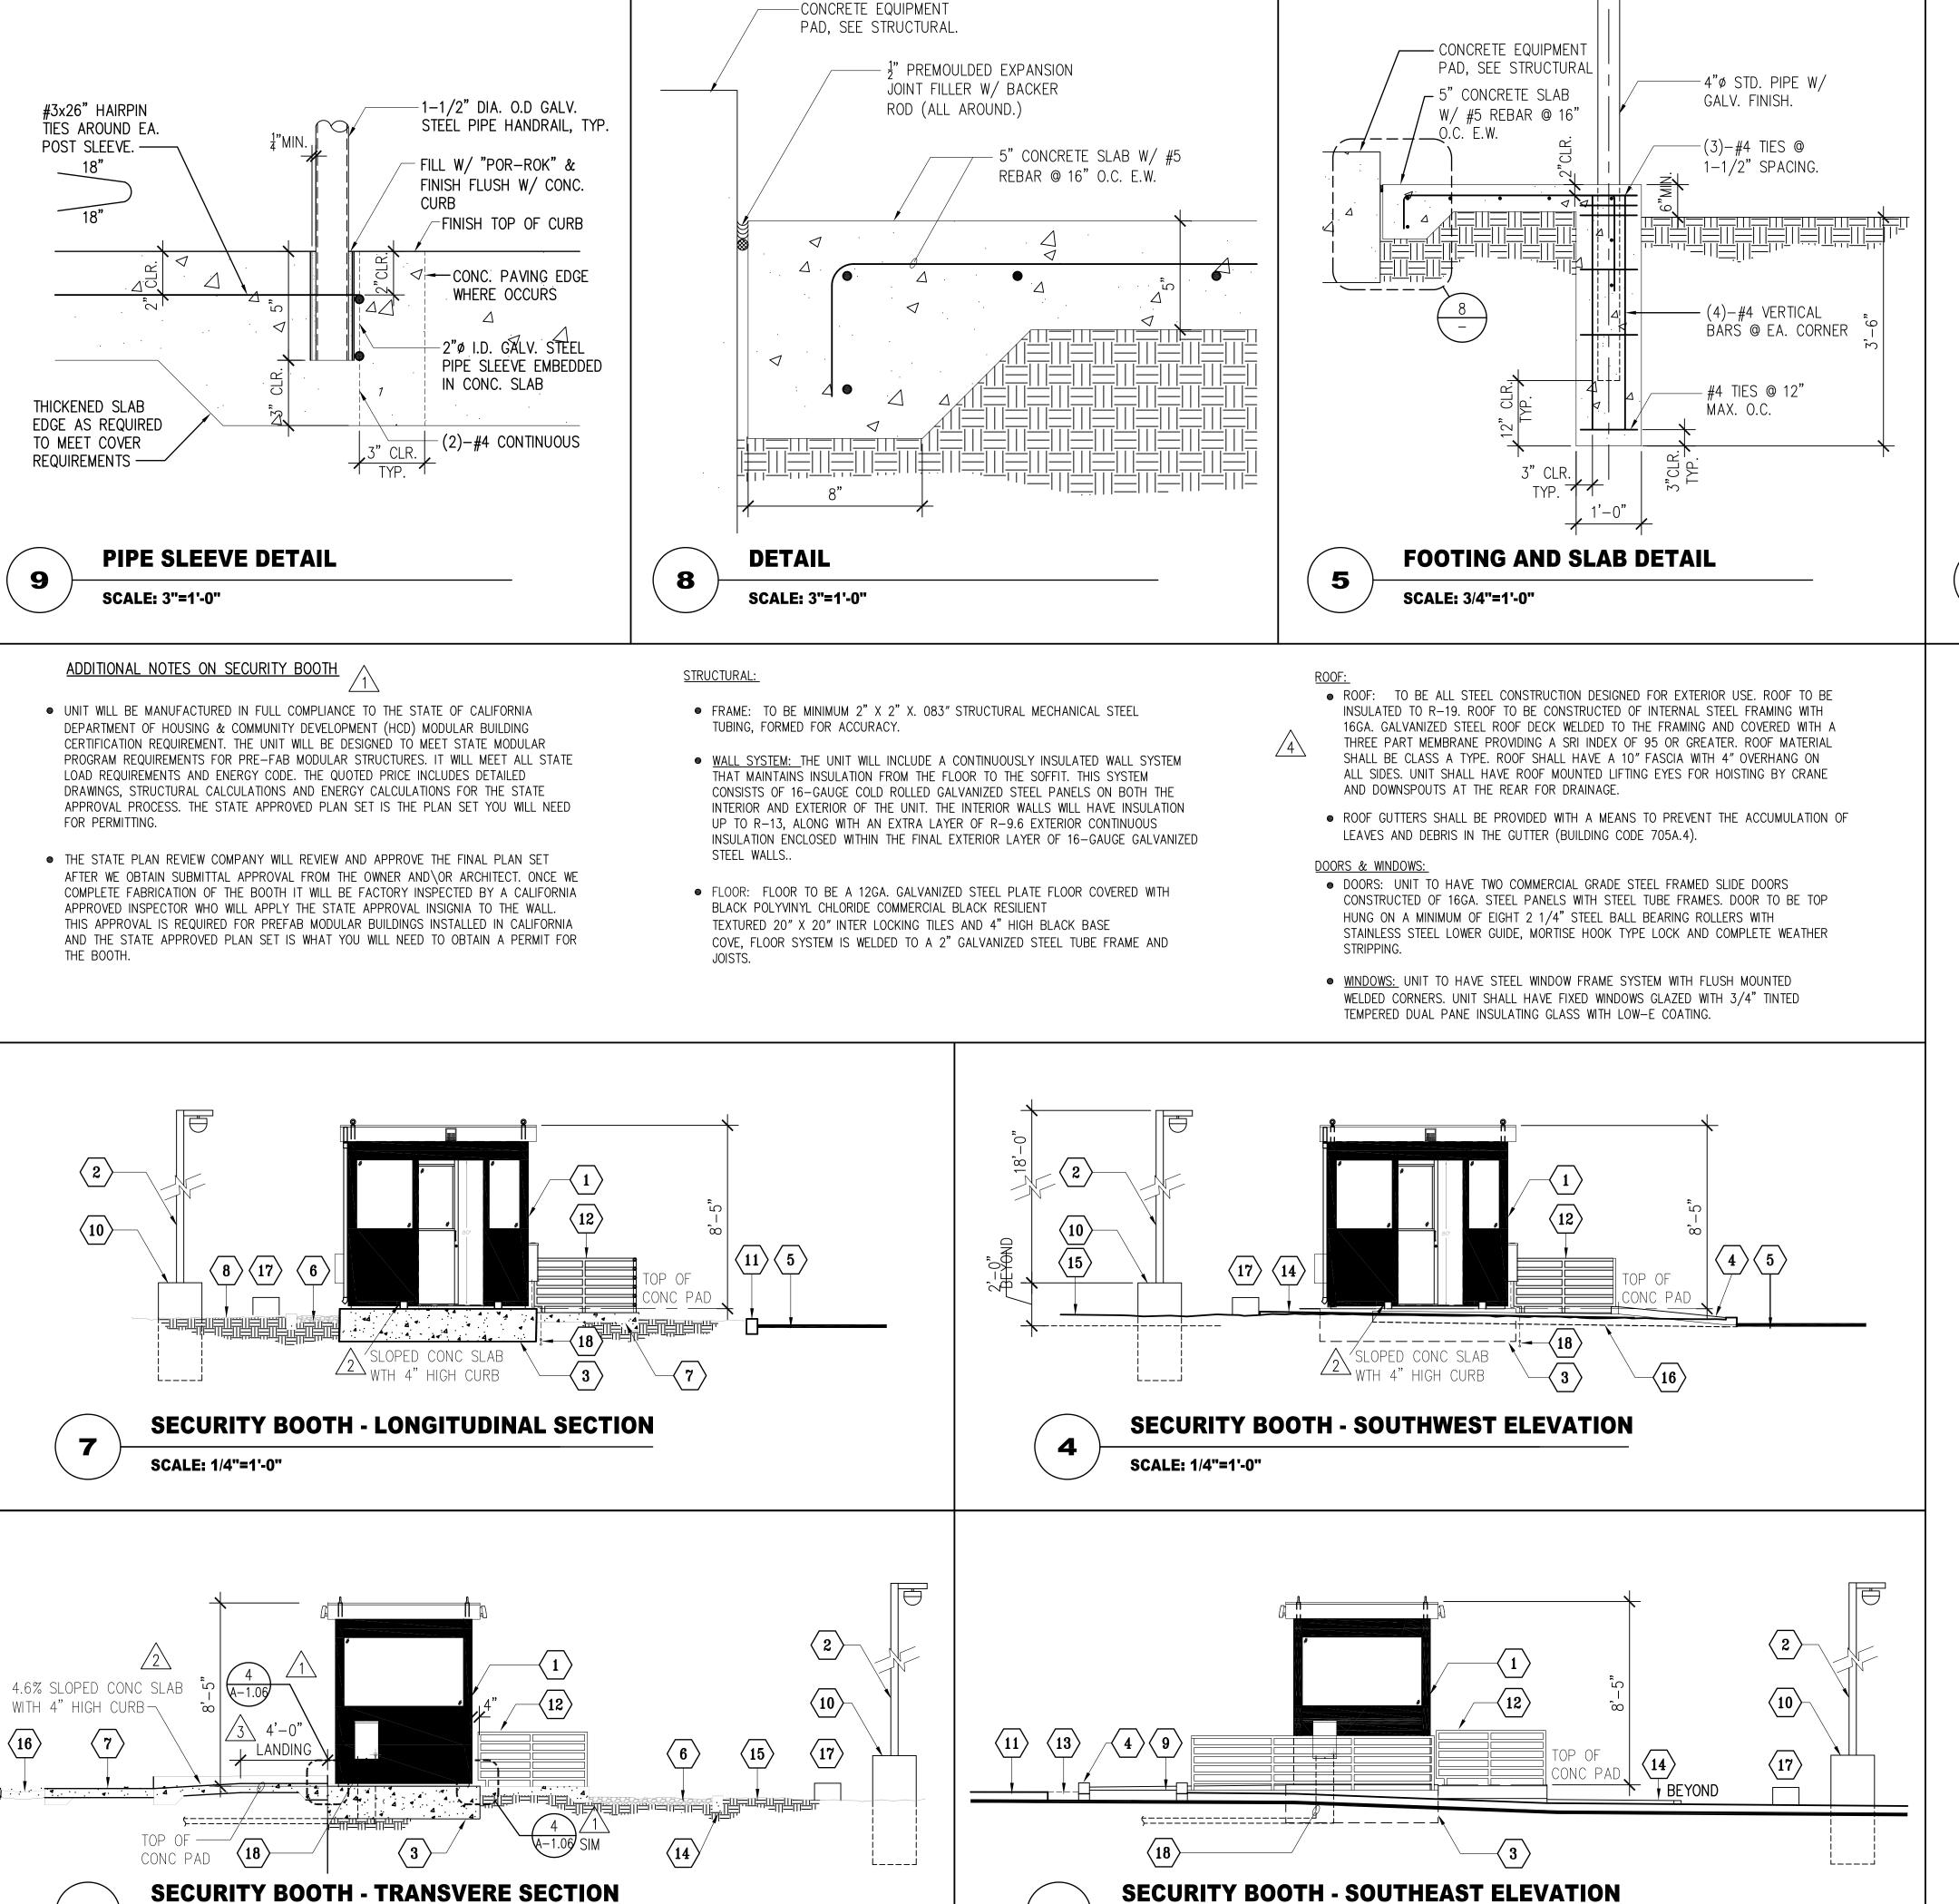
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ENLARGED PUMP HOUSE FLOOOR PLAN - NEW WORK

SPEC 7879






3

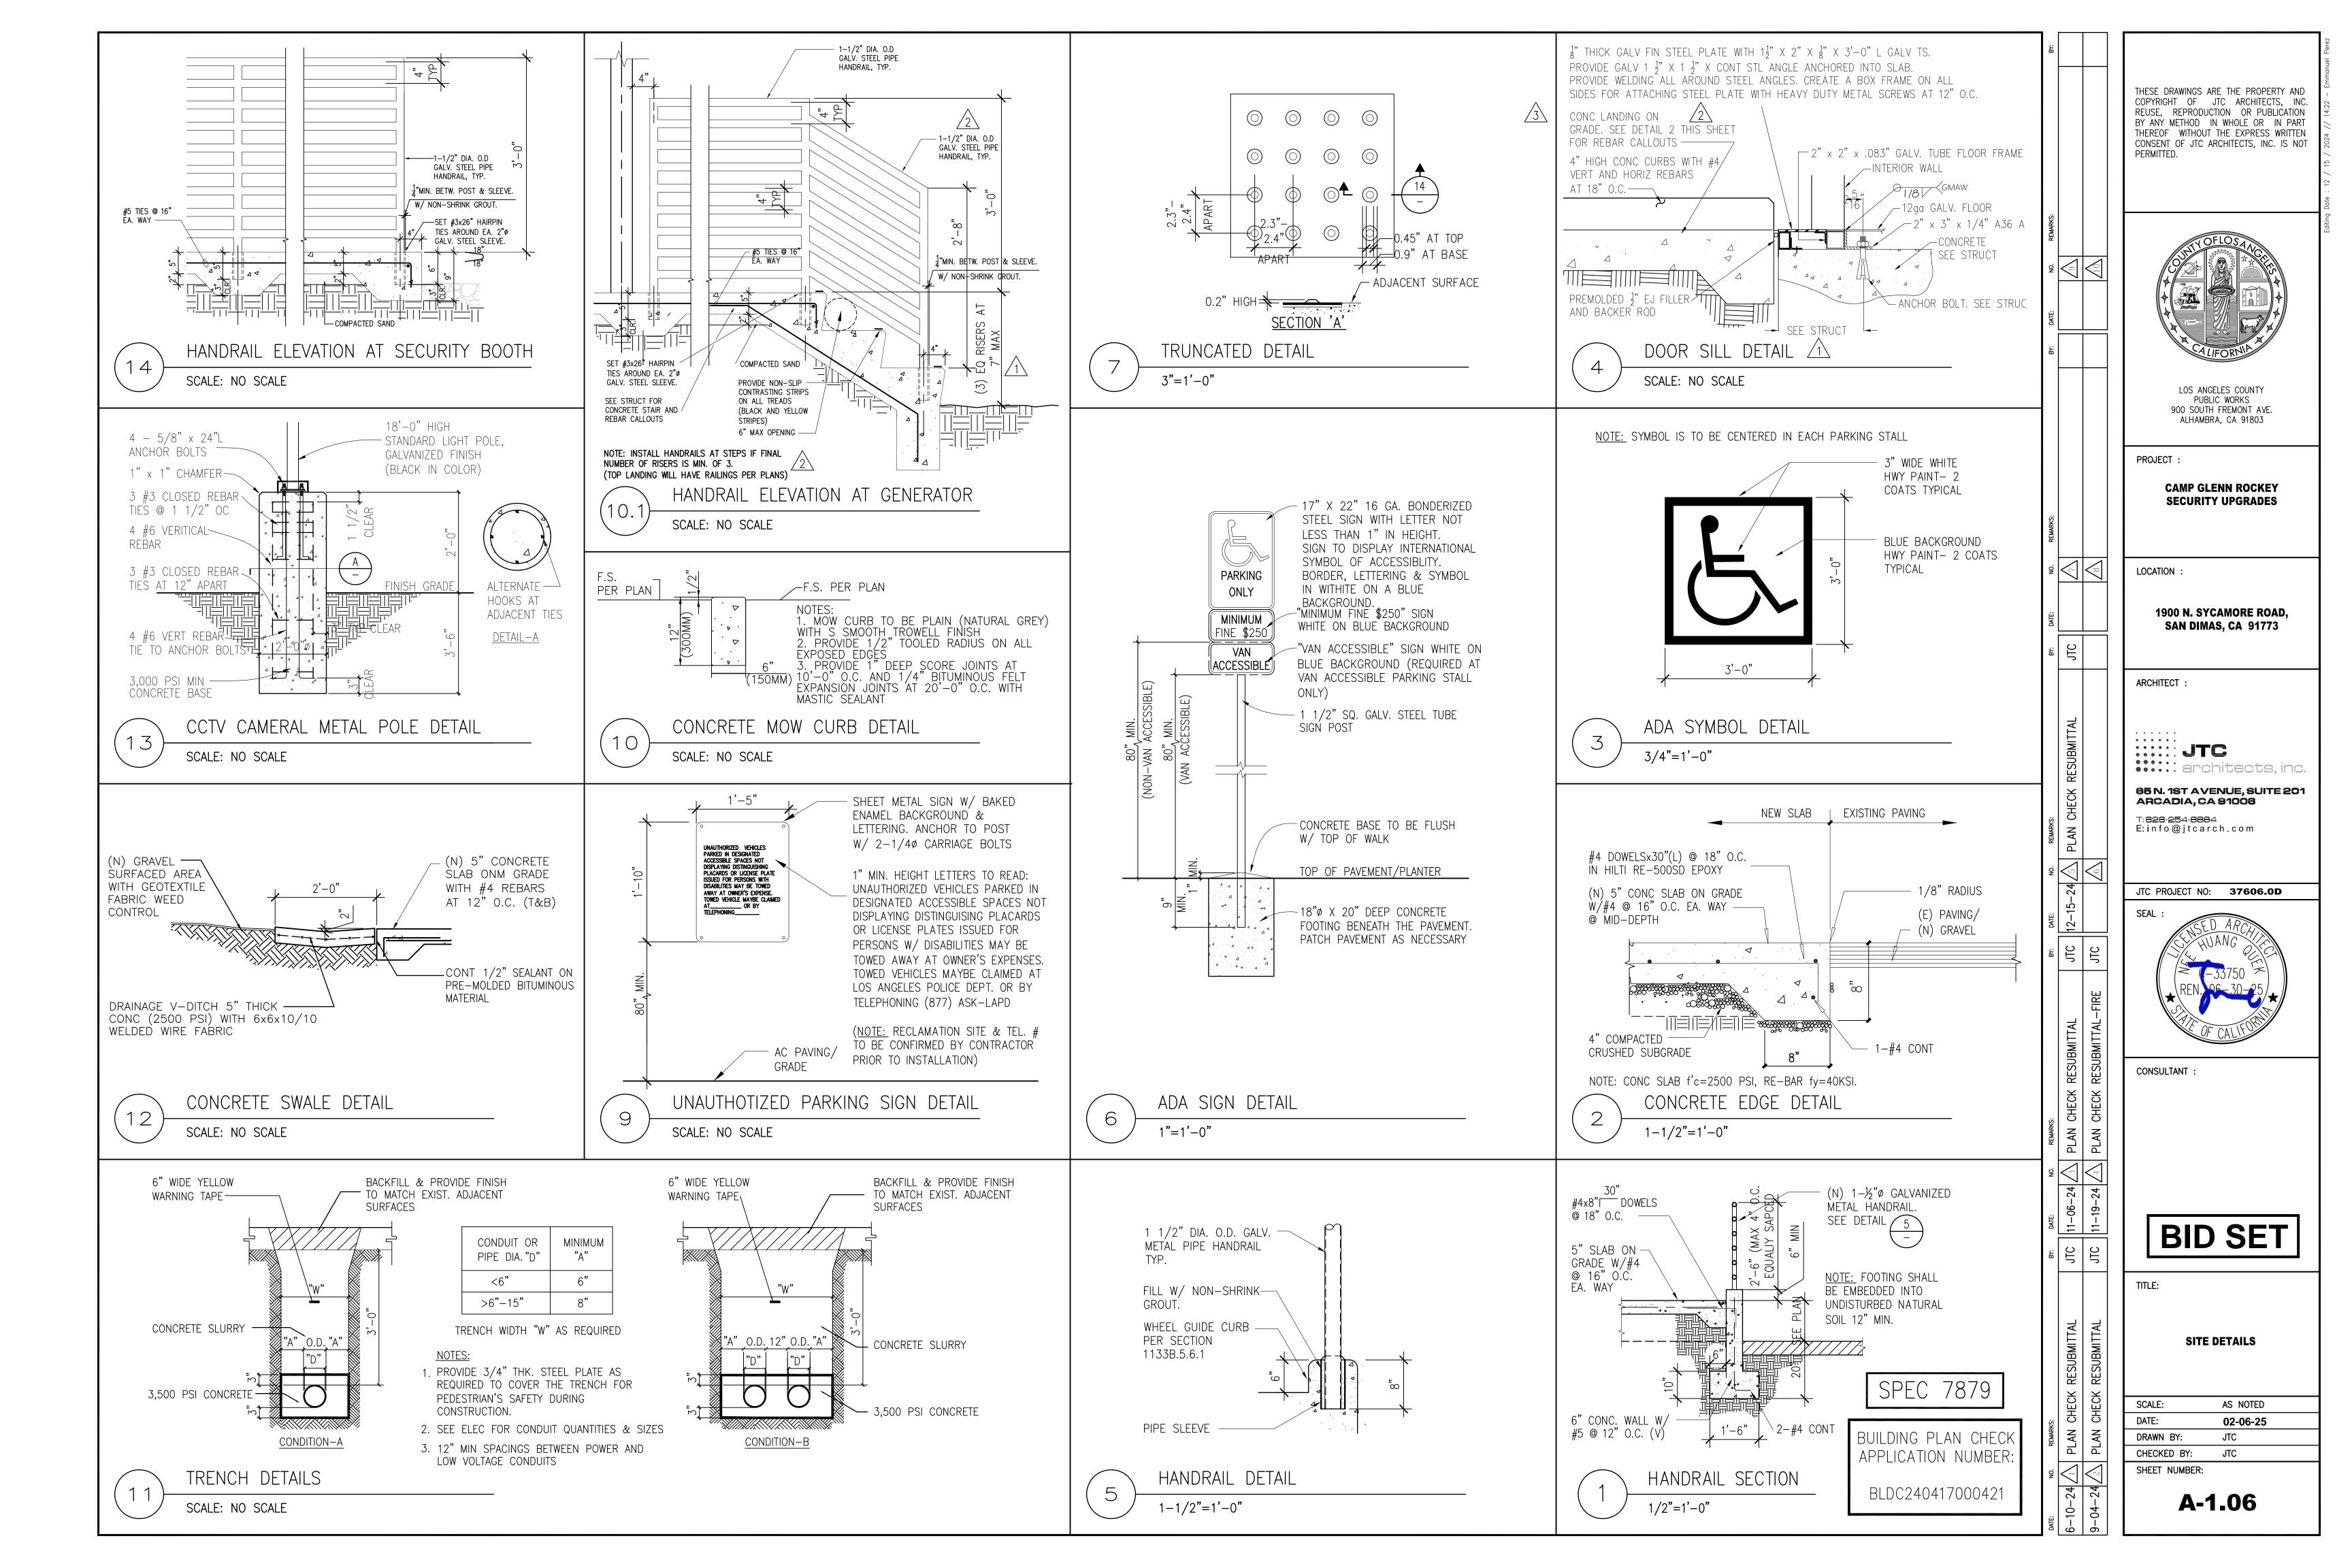SCALE: 1/4"=1'-0"

6

SCALE: 1/4"=1'-0"

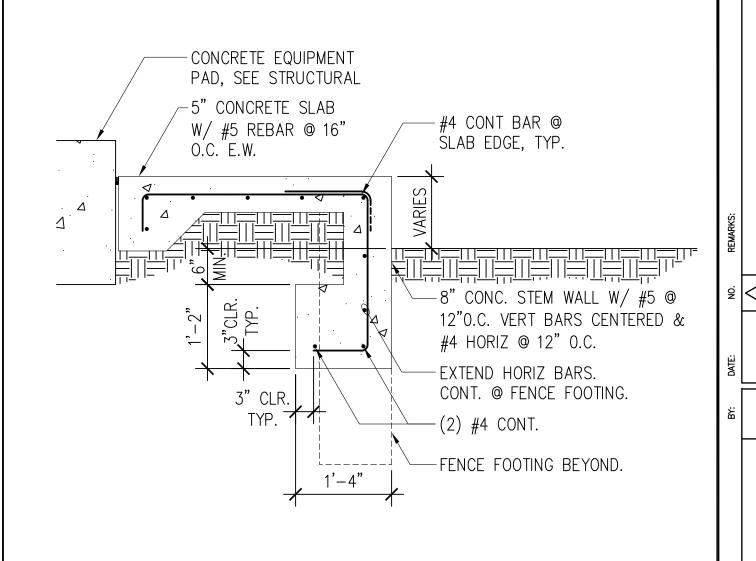

FOOTING AND SLAB DETAIL 2

SCALE: 3/4"=1'-0"

REFERENCE NOTES

(1) (N) PREFABRICATED METAL SECURITY BOOTH. SEE BELOW: • DELUXE GUARD BOOTH STYLE MODEL DS680B MANUFACTURER: B.I.G. ENTERPRISES 9702 E. RUSH STREET,

SOUTH EL MONTE, CA 91733

• 6'-0" X 8'-0" X 8'-5" HIGH SINGLE UNIT • REFERENCE SHEETS SEC-1 THRU SEC-10 FOR ADDITIONAL INFO

NOTES ON SECURITY BOOTH:

 DESIGN DRAWINGS ARE BASED ON THE PREFABRICATED SECURITY BOOTH AS MANUFACTURED BY B.I.G. ENTERPRISES.

• SUBMIT TO YOUR CHOOSING ANOTHER MANUFACTURER BASED ON "OR APPROVED EQUAL"

- CONTRACTOR SHALL PROVIDE STRUCTURAL SUPPORT DESIGN

FOR THE SUBSTITUTE DESIGN SHALL BE STAMPED BY A CALIFORNIA STATE LICENSED STRUCTURAL ENGINEER HIRED BY THE CONTRACTOR

- SUBMIT TO ARCHITECT OF RECORDS FOR PEER REVIEW - CONTRACTOR SHALL SUBMIT THE SUBSTITUTED DESIGN PACKAGE WITH STRUCTURAL CALCULATIONS TO LADPW BUILDING DEPT. FOR APPROVAL PRIOR TO COMMENCING WORK

- CONTRACTOR SHALL COORDINATE WITH ALL AFFECTED TRADES ALL DEVIATIONS TO THEIR WORK DUE TO THE SUBSTITUTE

- THERE SHALL BE NO ADDITIONAL COST INCURRED TO THE OWNER DUE TO YOUR CHOOSING

- THERE SHALL BE NO CHANGE TO THE CONSTRUCTION SCHEDULE

(N) CCTV CAMERA GALVANIZED METAL POLE (COLOR BLACK). SEE LOW VOLTAGE DWGS

 \langle 3 \rangle (N) CONCRETE FOUNDATION. SEE STRUCTURAL

(4) (N) CONCRETE CURB FOR ADA RAMP

 \langle 5 \rangle (E) ASPHALT PAVING. PATCH AND REPAIR DAMAGED AREA DUE CONST.

(N) 4" GRAVEL FINISH ON GEOTEXTILE FABRIC OVER COMPACTED SOIL

 \langle 7 \rangle (N) 5" CONCRETE PAVEMENT ON COMPACTED SOIL

 \langle 8 \rangle (E) FINISHED GRADE. PROVIDE SLOPE TOWARDS (E) FLOW LINE

 \langle 9 \rangle (N) CONCRETE ADA RAMP ON COMPACTED SOIL

 $\langle 10 \rangle$ (N) CONCRETE BASE. SEE 13 $\langle 11 \rangle$ (E) CONCRETE CURB

(N) 30" HIGH GALVANIZED STANDARD METAL HANDRAIL (PAINTED BLACK), SEE 14 1<u>4</u> \ A1.06

 $\langle 13
angle$ (N) CURB CUTOUT FOR DRAINAGE IN (E) CONCRETE CURB

 $\langle 14 \rangle$ (N) CONCRETE MOW STRIP

 $\langle 15 \rangle$ (E) GROUND DIRT

(N) CONCRETE SWALE TOWARDS
(N) CONCRETE BURN CUTOUT

(E) METAL VENT RISER. PROTECT-IN-PLACE DURING CONST

(N) UTILITY STUB OUTS. SEE ELEC AND LOW VOLTAGE DRAWINGS

SPEC 7879

BUILDING PLAN CHECK APPLICATION NUMBER

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ARCHITECT

:::::: JTC

•••• architects, inc. **65 N. 1ST AVENUE, SUITE 201** ARCADIA, CA 91008

:626-254-8884 E:info@jtcarch.com

JTC PROJECT NO: 37606.0D

CONSULTANT:

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CHECK CHECK

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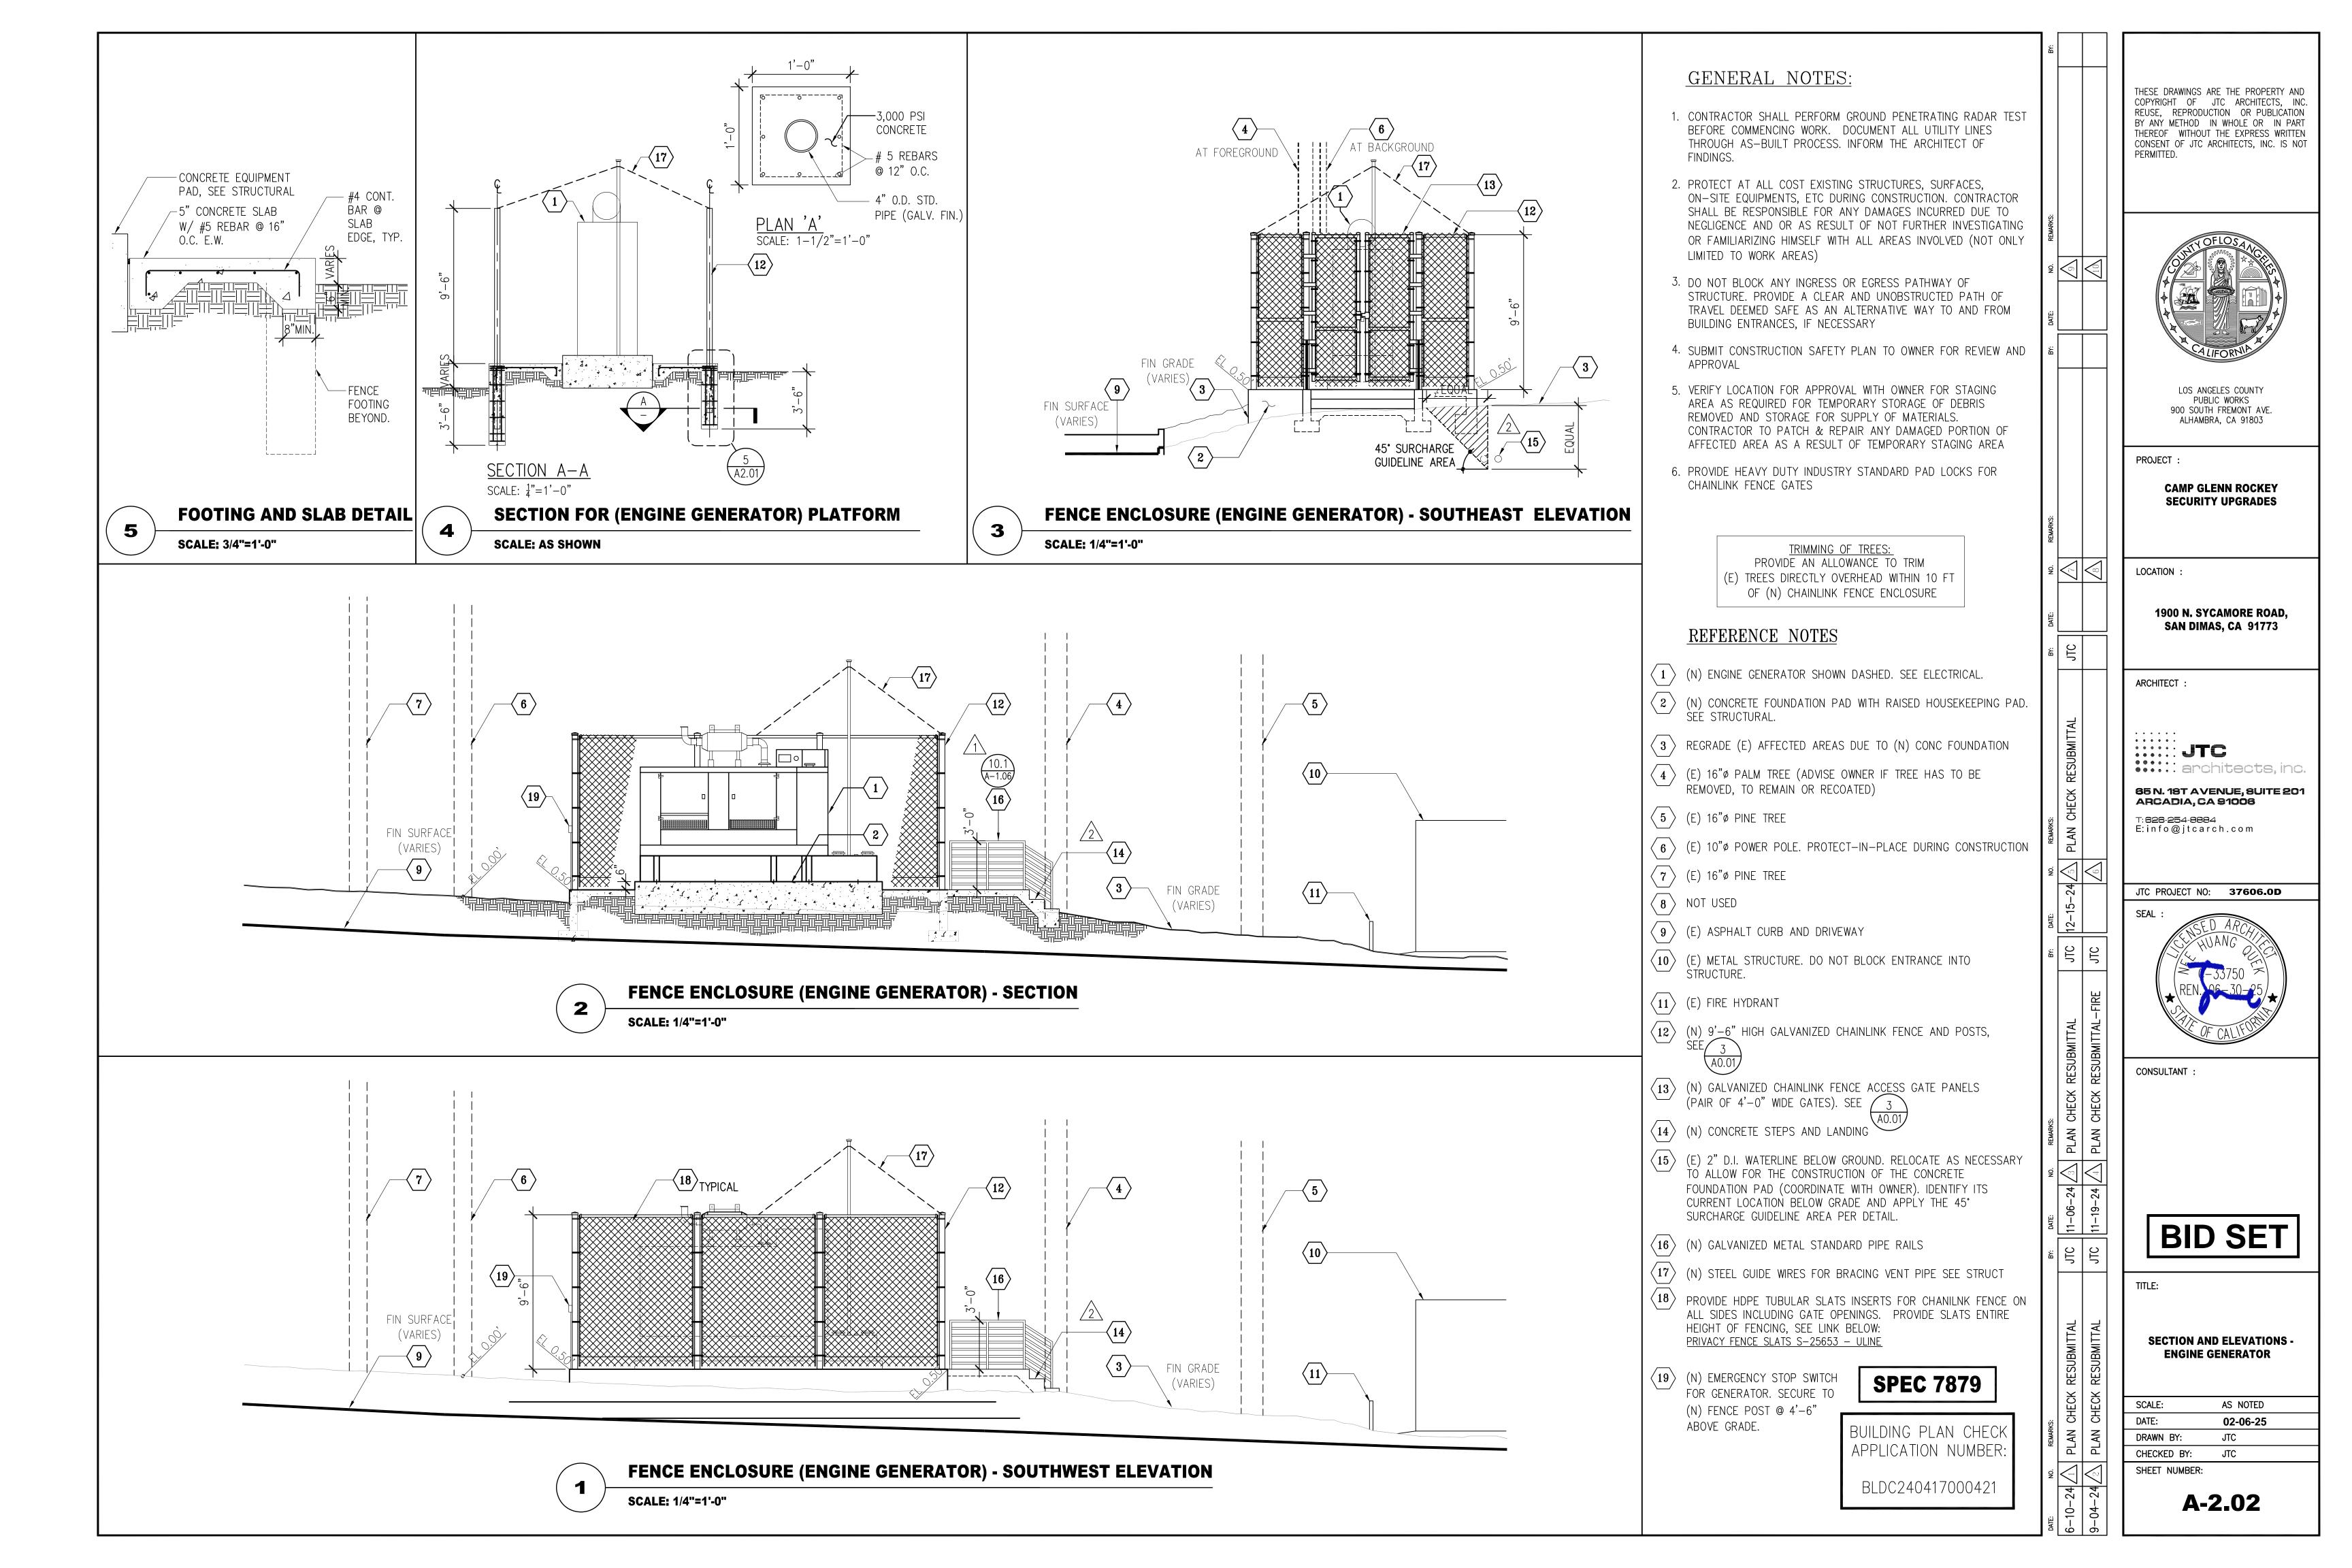
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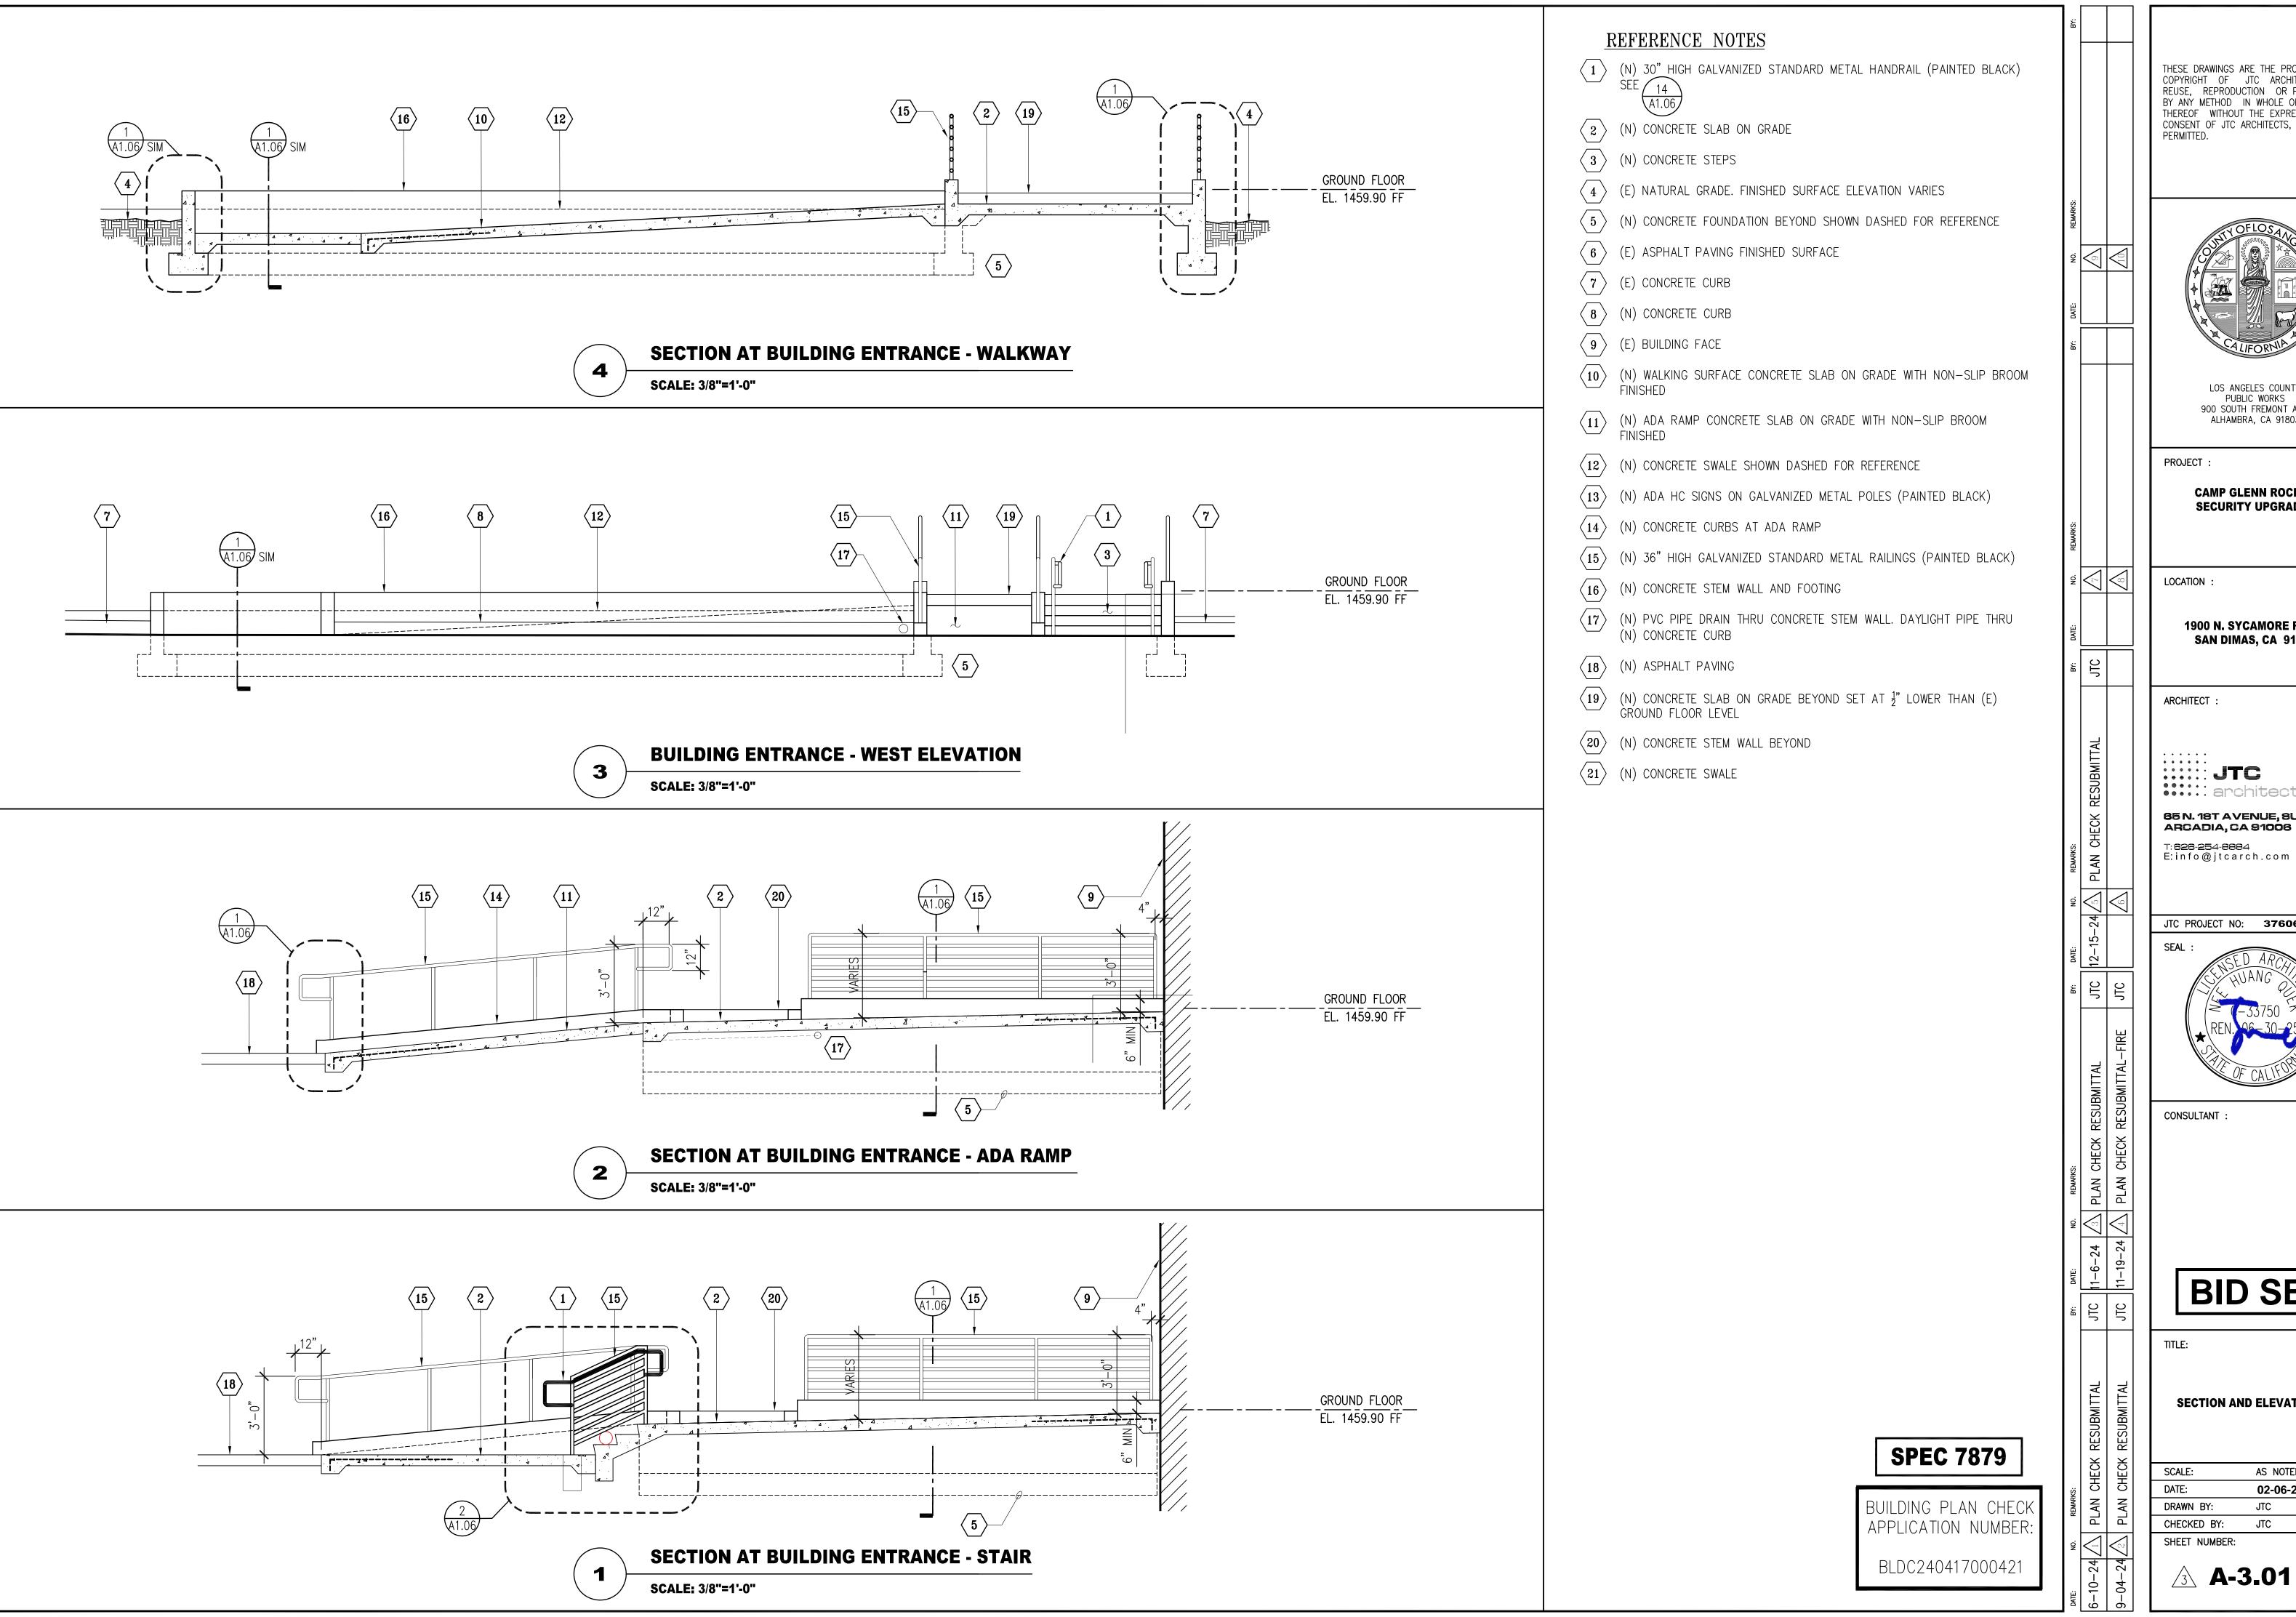
SECTION AND ELEVATIONS -SECURITY BOOTH

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65 N. 18T AVENUE, SUITE 201

T:**626-254-888**4 E:info@jtcarch.com


JTC PROJECT NO: 37606.0D

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SECTION AND ELEVATIONS

AS NOTED 02-06-25 JTC

△ A-3.01

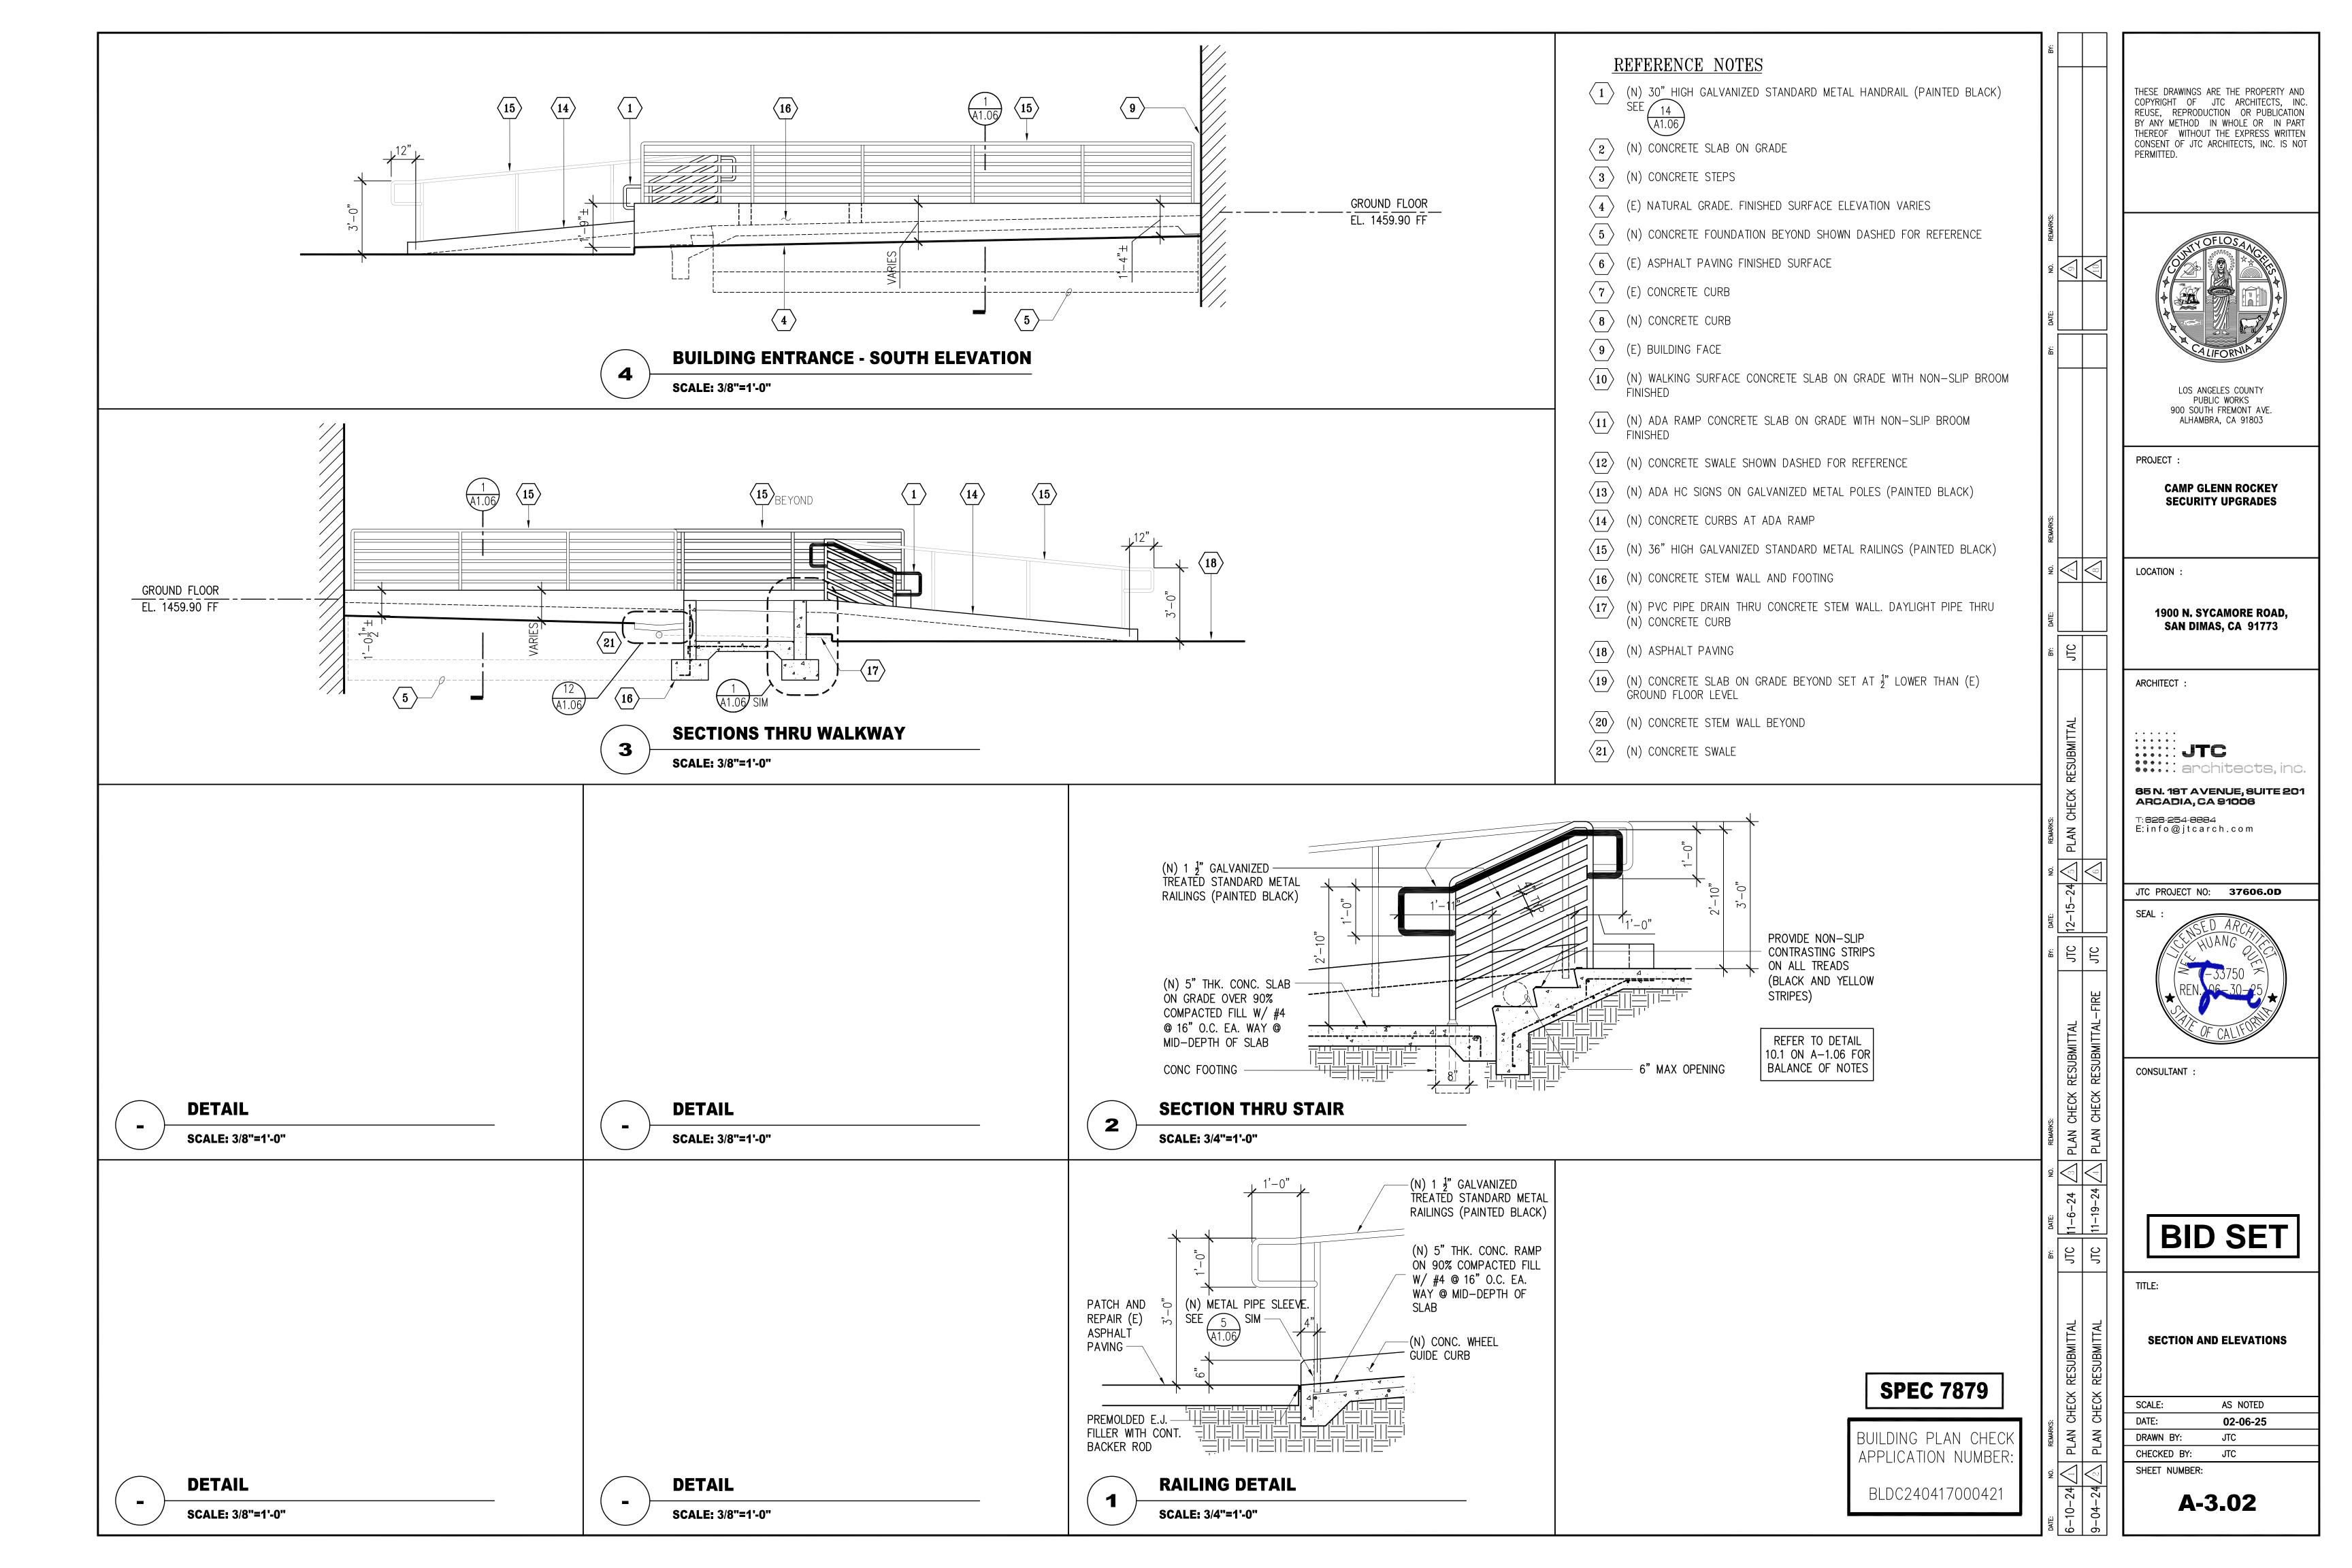

ABBREVIATIONS:	GENERAL STRUCTURAL NOTES:	FOUNDATIONS:	REINFORCING STEEL:
CODESINSTITUTIONS/ASSOCIATIONS ACI AMERICAN CONCRETE INSTITUTE (NDS) AIMERICAN FOREST & PAPER ASSOCIATION (NDS) AISC AMERICAN INSTITUTE OF STEEL CONSTRUCTION AISI AMERICAN INSTITUTE OF STEEL CONSTRUCTION AISI AMERICAN INSTITUTE OF STEEL CONSTRUCTION ASCE AMERICAN SOCIETY OF CIVIL ENGINEERS ASTM AMERICAN SOCIETY OF TRESTING AND MATERIALS AWS AMERICAN SOCIETY OF TRESTING AND MATERIALS AMERICAN SOCIETY AMERICA	DESIGN LOADS: BASIC WIND SPEED SEISMIC DESIGN LOADS: BASIC WIND SPEED SEISMIC DESIGN FOR NONSTRUCTURAL COMPONENTS (ASCE 7-16, CHAPTER 13) RISK CATEGORY RISK CATEGORY	1. RECOMMENDATIONS CONTAINED IN THE PROJECT GEOTECHNICAL/SOILS REPORT AS LISTED BELOW WERE USED FOR THE STRUCTURAL DESIGN OF FOUNDATIONS AND EARTH RETAINING ELEMENTS CONTAINED HEREIN, IF IT IS DETERMINED THAT ANY OF THE RECOMMENDATIONS IN THE PROJECT REPORT AFFECTING CONSTRUCTION WILL NOT BE FOLLOWED, A FORMAL CHARGE GORDE SHALL BE PREPARED WITH ADEQUARE THREFOR PROCESSING APPROVAL BY THE STRUCTURAL ENGINEER OF RECORD, THE GEOTECHNICAL ENGINEER AND THE GOVERNING AGENCY. MHIP ASSUMES NO RESPONSIBILITY FOR THE ACCURACY OF THE RECOMMENDATIONS CONTAINED WITHIN THE PROJECT REPORT. A. REPORT TITLE: PROPOSED CAMP GLENN ROCKEY SECURITY UPGRADES PROJECT B. REPORT OR PROJECT NUMBER: W1500.06.09 C. PREPARED BY: GEOCON WEST, INC. D. DATED: NOVEMBER 14, 2023 2. THE FOLLOWING DESIGN PARAMETERS WERE USED AS THE BASIS FOR ALLOWABLE FOUNDATION LOADS AND SOIL PRESSURES: A. ALLOWABLE SOIL BEARING PRESSURES: - MAT FOUNDATION: 2,000 PSF B. ALLOWABLE INCREASES FOR SOIL PRESSURE: - FOR LOAD COMBINATIONS INCLUDING WIND OR SEISMIC, A ONE-THIRD (1/3) INCREASE IS ALLOWED. C. MODULES OF SUBGRADE REACTION: 150 PCI D. RESISTANCE TO SLIDING: - FRICTION COEFFICIENT: 0.43 X DEAD LOAD (SLABS WITHOUT MOISTURE BARRIER) - O.15 X DEAD LOAD (SLABS WITH MOISTURE BARRIER) - PASSIVE PRESSURE: 270 PCF (2,700 PSF MAXIMUM) - WHEN COMBINED, REDUCE PASSIVE PRESSURE BY 1/3. 3. ALL SITE FILL, INCLUDING BACKFILL FOLLOWING OVER-EXCAVATION, IF REQUIRED, SHALL BE COMPACTED TO 90% OF MAXIMUM DENSITY IN ACCORDANCE WITH THE PROJECT SPECIFICATIONS, IF APPLICABLE, AND ASTM TEST METHOD D-1557. FLOODING IS NOT PERMITTED AND SHALL BE APPROVED BY THE PROJECT GEOTECHNICAL ENGINEER 4. ALL FULL AND BACKFILL EXTENTS AND MATERIAL SHALL BE APPROVED BY THE PROJECT GEOTECHNICAL ENGINEER. 5. ALL FULL AND BACKFILL EXTENTS AND MATERIAL SHALL BE APPROVED BY THE PROJECT GEOTECHNICAL ENGINEER. 6. WATER SHALL BE REMOVED FROM FOUNDATION EXCAVATION PRIOR TO PLACING OF CONCRETE. CARE SHALL BE TAKEN TO NOT AND OR THE RELEMENTS WHICH MAKE THE EXCAVATIONS INACCESSIBLE FOR ANY CORR	1. DETAILING, FABRICATION AND PLACING OF REINFORCING STEEL SHALL CONFORM TO STANDARDS AND RECOMMENDATIONS CONTAINED WITHIN THE CRSI "MANUAL OF STANDARD PRACTICE". DETAILING FABRICATION AND PLACING OF WELDED WIRE REINFORCING SHALL CONFORM TO THE STANDARD SAND RECOMMENDATIONS CONTAINED WITHIN THE WITH "ANNUAL OF STANDARD PRACTICE". STRUCTURAL WELDED WIRE REINFORCING SCONTAINED WITHIN THE WITH "ANNUAL OF STANDARD PRACTICE". STRUCTURAL WELDED WIRE REINFORCING SCONTAINED WITHIN THE WITH "ANNUAL OF STANDARD PRACTICE". STRUCTURAL WELDED WIRE REINFORCING SCONTAINED WWN SHALL CONFORM TO THE FOLLOWING ASTM SPECIFICATIONS, UND: A. REINFORCING (ALL BAR SIZES, UND): A. STM A-706, GR 60 B. REINFORCING BARS TO BE WELDED (ALL BAR SIZES UNO): ASTM A-706, GR 60 C. WELD WIRE REINFORCING: ASTM A-82 3. ALL REINFORCING STEEL SHALL BE BENT COLD, GRADE 60 BARS MAY ONLY BE BENT ONCE, STRAIGHTENING AND/OR RE-BENDING IS NOT ALLOWED. IT SHALL BE THE CONTRACTOR'S RESPONSIBILITY TO SEQUENCE PLACEMENT OF REINFORCING SUCH THAT INCIDENTAL BENDING DOES NOT OCCUR. 4. PRIOR TO PLACING CONCRETE: REINFORCING STEEL, INCLUDING WIRR, AND OTHER EMBEDDED ITEMS SHALL BE WELL-SECURED IN POSITION AND SHALL BE CLEAN OF RUST, GREASE OR OTHER MATERIAL LIKELY TO IMPAIR BOND. WHERE TWO LAYERS OF REINFORCING STEEL ARE REQUIRED (I.E. FOOTING PABS OR SLASS) PROVIDE APPROPRIATE CHAIRS TIED TO AND SUPPORTED SY LOWER MAY OF REINFORCING TO SUPPORT THE UPPER MAT OF REINFORCING. HOOK AND PULL" METHODS SHALL NOT BE ALLOWED. 5. CONCRETE PROTECTION FOR REINFORCING BARS SHALL BE AT LEAST EQUAL TO THE DIAMETER OF THE BAR. MINIMUM COVER FOR CAST IN PLACE CONCRETE SHALL BE AS FOLLOWS: A. CAST AGAINST AND PERMANENTLY IN CONTACT WITH GROUND: • ALL MEMBERS, 8,5 WIGHT ON DISTING AND SMALLER: • SLABS, JOISTS, WALLS; #11 BARS AND SMALLER: 11/2' • ALL MEMBERS, 8,5 WIGHT ON OR HOME LAYERS, BARS IN THE UPPER LAYERS SHALL BE TRACET LY ABOVE
	THEY SHALL BE REPORTED TO THE YOUR SERVICES ON MAY THE PROPER REVISION MAY BE MADE, MODIFICATIONS OF CONSTRUCTION, LIVER SHALL NOT BE MADE ON THE WORK AND SHALL BE SOLELY RESPONSIBLE FOR CONSTRUCTION, MUSES NOTED OTHERS THE COMPAND'S SHALL SHEPPINES AND DOLOR OF CONSTRUCTION. MUSES NOTED OTHERS THE COMPAND'S SHALL SHEPPINES AND DOLOR SHALL SHEPPINES AND PROPERTIES AND DOLORS SHALL BE SOLELY RESPONSIBLE FOR CONSTRUCTION MADE AND MY CONTROLLOR SHALL BE RESPONSIBLE FOR TEMPORARY CONSTRUCTION LOADING, INCLUDING LOADING FROM TOURISMS AND PROCESSORY SHALL BE SOLELY RESPONSIBLE FOR TEMPORARY CONSTRUCTION LOADING, INCLUDING LOADING FROM TOURISMS THE AND SHALL BE RESPONSIBLE FOR TEMPORARY CONSTRUCTION LOADING, INCLUDING LOADING FROM TOURISMS THE AND SHALL BE RESPONSIBLE FOR TEMPORARY CONSTRUCTION LOADING, INCLUDING LOADING FROM TOURISMS THE AND SHALL BE RESPONSIBLE FOR THE PROPERTY CONSTRUCTION LOADING PROPERTY ON THE STRUCTURE MY WHITE PROPERTY CON CONSTRUCTION MY THE AND SHALL BE RESPONSIBLE FOR THE PROPERTY CONSTRUCTION LOADING PROPERTY ON THE AND SHALL BE AND	This Plan has been reviewed and appears to be in general conformity with the recommendations of the referenced Geocon report(s) (and addenda). Project No. W1500-06-08 No representation is made regarding the design shown, or the accuracy of any measurement or dimension. Calculations by others were not reviewed by Geocon. Date: 06/07/24 By: Harry Derkalousdian	A. REBARN MONGRETE. SEE TYPICAL BILBIAS. REMAIN MASSANY SEE TYPICAL BILBIAS. REMAIN MASSANY SEE TYPICAL BILBIAS. C. WITKIN CONCRETE. I 12 X XWER CRID SPACES (9 Min) C. OWER THE REMONGROUP PLACEMENT DRAWINGS (15 PAGAMOST) AND SHALL BE SUBBILITED 10 THE SECRET FOR RESIDENT FOR ADDITIONAL MICROBALIDA AND REVIEW PRIOR TO FARBRICATION. A PROVIDED SHOT DRAWINGS SHALL BE MADE AND AND AND AND AND REMAINS (15 PAGAMOST) AND REMAINS (15 PAGAMOST). CONTRACTOR SHALL SECREDUE SPECIAL, RESPECTIONS SO THAT BAR SIZE, SPACING LAP SPLICE AND EMBERGMENT LENGTH OF REINFORCING SHEEL SHOULD SEPECIAL RESPECTIONS SO THAT BAR SIZE, SPACING LAP SPLICE AND EMBERGMENT LENGTH OF REINFORCING SHEEL, SHOULD SEED AND SHEED THE SHOULD REPORT THE SHOULD REPORT THE SHOULD SHEEL SHOULD SHEED THE SHOULD SHEED THE SHOULD REPORT THE SHOULD REPORT THE SHOULD SHEED THE SHOULD SHEED THE SHOULD REPORT THE SHOULD SHEED THE SHOULD SHEED THE SHOULD REPORT THE SHOULD SHEED THE SHEED THE SHOULD SHEED THE SHEED TH

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LOS ANGELES COUNTY
DEPARTMENT OF PUBLIC WORKS
900 SOUTH FREMONT AVE. 8TH FLOOR
ALHAMBRA, CA 91803

PROJECT :

CAMP GLENN ROCKEY SECURITY UPGRADES

LOCATION:

1900 N. SYCAMORE ROAD, SAN DIMAS, CA 91773

ARCHITECT :

architects, inc.

65 N. 18T AVENUE, SUITE 201 ARCADIA, CA 91006

T:**626-254-888**4 E: info@jtcarch.com

JTC PROJECT NO: **37606.0D**

LONG BEACH . SAN DIEGO

LONG BEACH OFFICE 3900 Cover Street, Long Beach CA 90808 • 562.985.3200 Project: 23-0177-00

STRUCTURAL NOTES AND ABBREVIATIONS

02-06-25 DRAWN BY: CHECKED BY: SHEET NUMBER:

S-1.00

- 1. ALL CONCRETE WORK SHALL CONFORM TO THE STANDARDS OF THE AMERICAN CONCRETE INSTITUTE (ACI), "ACI MANUAL OF CONCRETE PRACTICE" CURRENT EDITION, "SPECIFICATIONS FOR STRUCTURAL CONCRETE" (ACI 301), AND BUILDING CODE REQUIREMENTS FOR STRUCTURAL CONCRETE (ACI 318).
- WHEN SPECIFIED FOR USE, NORMAL WEIGHT (NWT) CONCRETE SHALL HAVE A DRY UNIT WEIGHT OF 150 ± 3 PCF. AGGREGATES FOR NORMAL WEIGHT CONCRETE SHALL CONFORM TO ASTM C33.
- WHEN SPECIFIED FOR USE LIGHTWEIGHT (LWT) CONCRETE SHALL HAVE A DRY UNIT WEIGHT OF 110 ± 3 PCF. AGGREGATES FOR LIGHTWEIGHT CONCRETE SHALL BE EXPANDED SHALE AGGREGATE CONFORMING TO ASTM C330.
- 4. CEMENT SHALL CONFORM TO PORTLAND CEMENT ASTM C-150 (TYPE II) UNLESS NOTED OTHERWISE. WHEN USED IN THE CONCRETE MIX, FLY ASH SHALL CONFORM TO ASTM C618 CLASS F OR N.
- 5. MIXING WATER SHALL CONFORM TO ASTM C1602.

B. MINIMUM COMPRESSIVE STRENGTH AT 28 DAYS:

- ADMIXTURES SHALL CONFORM TO THE FOLLOWING: A. WATER REDUCTION AND SETTING TIME MODIFICATION: ASTM C494 B. PRODUCING FLOWING CONCRETE: **ASTM C1017** C. AIR ENTRAINMENT ASTM C260 D. INHIBITING CHLORIDE-INDUCED CORROSION: **ASTM C1582**
- ALL NON-SHRINK GROUT SHALL CONFORM TO ASTM C1107/C1107M AND SHALL BE PRE-MIXED COMPOUND CONSISTING OF NON-METALLIC AGGREGATE, CEMENT AND WATER-REDUCING AND PLASTICIZING AGENTS.
- A. MINIMUM COMPRESSIVE STRENGTH AT 48 HOURS:
- 8. CONCRETE SHALL ATTAIN THE FOLLOWING MINIMUM COMPRESSIVE STRENGTH (F'C) AT 28 DAYS AND SHALL MEET THE
- OTHER REQUIREMENTS INDICATED BELOW: A. FOOTINGS: 3,000 PSI, NWT, 1 1/2" AGGREGATE, 0.45 W/C
- B. SLABS ON GRADE 3,000 PSI, NWT, 1" AGGREGATE, 0.45 W/C C. ALL OTHER CONCRETE: 3,000 PSI, NWT, 1" AGGREGATE, 0.45 W/C
- MAXIMUM SLUMP FOR CONCRETE MIXES SHALL BE 5" TYPICALLY AND 4" FOR ALL FLATWORK. WHETHER ON GRADE OR ELEVATED, EXCEPT WHEN A HIGH RANGE WATER REDUCING ADMIXTURE IS SPECIFIED FOR USE IN THE CONCRETE MIX DESIGN, SLUMP SHALL BE A MAXIMUM OF 9".
- 10. CONCRETE MIX DESIGN SHALL BE PREPARED BY AN APPROVED TESTING LAB AND A REGISTERED CIVIL ENGINEER AND SUBMITTED TO THE STRUCTURAL ENGINEER OF RECORD (SEOR) FOR REVIEW. CONCRETE MIX DESIGN SUBMITTALS SHALL BE STAMPED AND SIGNED BY THE LICENSED ENGINEER RESPONSIBLE FOR THE MIX DESIGN.
- 11. WHEN USED, AIR ENTRAINMENT SHALL NOT BE MORE THAN 5%.
- 12. ALL FURNISHED CONCRETE MIX DESIGNS SHALL REFLECT PROVEN CONCRETE SHRINKAGE CHARACTERISTICS OF 0.0004 IN/IN (0.04%) FINAL SHRINKAGE STRAIN OR LESS AT ALL SLABS (INCLUDING TOPPING SLABS WHERE THEY OCCUR), AND 0.0006 IN/IN (0.06%) FINAL SHRINKAGE STRAIN OR LESS AT OTHER CONCRETE ELEMENTS, AS DETERMINED IN ACCORDANCE WITH ASTM C157.
- 13. CONCRETE SHALL BE CONVEYED TO FINAL LOCATION BY METHODS THAT PREVENT SEGREGATION OR LOSS OF CONSTITUENTS AND ENSURE THE REQUIRED CONCRETE QUALITY.
- 14. WATER SHALL NOT BE ADDED TO CONCRETE AT THE SITE.
- 15. LOCATE CONSTRUCTION AND/OR CONTROL JOINTS AS INDICATED IN CONTRACT DOCUMENTS AND/OR SUBMIT INFORMATION FOR ACCEPTANCE OF PROPOSED LOCATION AND TREATMENT OF JOINTS NOT INDICATED IN CONTRACT
- 16. ALL CONSTRUCTION JOINTS SHALL BE ROUGHENED TO 1/4" AMPLITUDE, THOROUGHLY CLEANED AND ALL LAITANCE REMOVED. LONGITUDINAL KEYWAYS, 1 1/2" DEEP, SHALL BE USED WHERE INDICATED IN THE CONTRACT DOCUMENTS. ALL JOINTS SHALL BE THOROUGHLY DAMPENED, BUT WITHOUT STANDING WATER, IMMEDIATELY BEFORE PLACING NEW
- 17. THE CONTRACTOR(S) SHALL BE RESPONSIBLE FOR COORDINATING WITH ALL TRADES TO VERIFY THE LOCATION OF ALL ITEMS SUCH AS, BUT NOT LIMITED TO, SLEEVES, ANCHORS, ANCHOR BOLTS, CONDUITS, EMBED PLATES ETC. TO BE INSTALLED WITHIN CONCRETE ELEMENTS. EMBEDDED ITEMS NOT SPECIFICALLY SHOWN IN THE STRUCTURAL DRAWINGS SHALL BE LOCATED BY THE TRADES/SUB-CONTRACTORS INVOLVED, AND SHALL BE REVIEWED BY THE SEOR PRIOR TO PLACEMENT OF CONCRETE. IN COORDINATING THE LOCATION OF EMBEDDED ITEMS NOT OTHERWISE LOCATED IN THE STRUCTURAL DRAWINGS, PRIORITY SHALL BE GIVEN TO MAINTAIN SPACING AND CONTINUITY OF ALL REINFORCING. EMBEDDED ITEMS SHALL BE WELL DISTRIBUTED TO AVOID CLUSTERING IN SUCH A MANNER AS TO REQUIRE CUTTING OR RELOCATION OF REINFORCING STEEL.
- 18. UNLESS OTHERWISE NOTED, BOLTS EMBEDDED IN CONCRETE SHALL BE ASTM F-1554 GR 36. ALL EMBEDDED ANCHOR BOLTS SHALL BE HEADED-TYPE. DO NOT USE J-TYPE BOLTS.
- 19. UNLESS OTHERWISE NOTED, A 3/4" CHAMFER SHALL BE PROVIDED AT EXPOSED EDGES OF CONCRETE BEAMS AND
- 20. PRIOR TO PLACING CONCRETE, ALL EMBEDDED ITEMS, INCLUDING REINFORCING STEEL, SHALL BE WELL SECURED IN POSITION. CONCRETE SHALL NOT BE POURED UNTIL ALL FORMS AND REINFORCING HAVE BEEN INSPECTED, ALL PREPARATIONS FOR THE PLACEMENT HAVE BEEN COMPLETED, AND THE PREPARATIONS HAVE BEEN REVIEWED BY THE PROJECT INSPECTOR.
- 21. ONLY ONE GRADE OF CONCRETE SHALL BE ALLOWED AT THE JOB SITE AT ANY ONE TIME.
- 22. CONCRETE TO BE PLACED DURING COLD WEATHER SHALL COMPLY WITH ACI 306R. "GUIDE TO COLD WEATHER CONCRETING" AND ACI 306.1, "STANDARD SPECIFICATION FOR COLD WEATHER CONCRETING"
- 23. CONCRETE TO BE PLACED DURING HOT WEATHER SHALL COMPLY WITH ACI 305R. "GUIDE TO HOT WEATHER CONCRETING" AND ACI 305.1, "STANDARD SPECIFICATION FOR HOT WEATHER CONCRETING".
- 24. CONCRETE SHALL BE MAINTAINED IN A CONTINUOUSLY MOIST CONDITION ABOVE 50F FOR A MINIMUM OF SEVEN (7) DAYS AFTER PLACEMENT. THE 7-DAY REQUIREMENT MAY BE REDUCED TO 3 DAYS FOR HIGH-EARLY-STRENGTH CONCRETE. ALTERNATE ACCELERATED CURING METHODS MAY BE APPROVED BY THE SEOR IF SATISFACTORY PERFORMANCE CAN
- 25. EQUIPMENT SHALL NOT BE PLACED ON CONCRETE UNTIL CONCRETE HAS REACHED 75% OF THE MINIMUM REQUIRED COMPRESSIVE STRENGTH AND NO SOONER THAN A MINIMUM OF 72 HOURS AFTER CONCRETE PLACEMENT. IF EQUIPMENT IS TO BE ANCHORED WITH POST-INSTALLED ANCHORS. REFER TO POST-INSTALLED ANCHOR NOTES FOR MINIMUM CONCRETE STRENGTH AND SETTING TIME REQUIREMENTS FOR DRILLING HOLES FOR ANCHORS AND INSTALLATION, TORQUING, AND TESTING OF THE ANCHORS.
- 26. ALL CONCRETE SHALL BE TESTED AND INSPECTED AS REQUIRED PER THE SPECIAL INSPECTION SECTION OF THESE

POST-INSTALLED ANCHORS:

- 1. POST INSTALLED ANCHOR NOTES IN THIS SECTION SHALL APPLY TO ALL ANCHORS (INCLUDING THREADED ROD OR REINFORCING BARS) INSTALLED INTO HARDENED CONCRETE OR MASONRY EXCEPT FOR POWDER DRIVEN FASTENERS, AS APPLICABLE, SEE POWDER DRIVEN FASTENER GENERAL NOTES FOR MORE INFORMATION.
- 2. INSTALLATION SHALL CONFORM TO THE MANUFACTURER'S INSTRUCTIONS AND THE APPLICABLE EVALUATION REPORT AND SHALL BE INSTALLED BY PERSONNEL TRAINED TO INSTALL THE TYPE OF POST-INSTALLED ANCHOR BEING
- 3. LOCATE EXISTING REINFORCING BY NON-DESTRUCTIVE METHODS PRIOR TO DRILLING. EXISTING REINFORCING SHALL
- 4. CONCRETE SHALL HAVE A MINIMUM COMPRESSIVE STRENGTH OF F'C = 2500 PSI, BE A MINIMUM OF 21 DAYS OLD AND HAVE A MINIMUM TEMPERATURE OF 50 DEGREES FAHRENHEIT WHEN DRILLING OCCURS.
- 5. HOLES FOR INSTALLATION OF THE POST-INSTALLED ANCHOR SHALL BE DRILLED USING A DRILL THAT HAS A CARBIDE-TIPPED BIT THAT COMPLIES WITH ANSI B212.15. A REBAR CUTTING DRILL BIT IS NOT ALLOWED.
- 6. CONTRACTOR SHALL USE APPROPRIATE EQUIPMENT AND METHODS AS REQUIRED TO PROVIDE DRILLED HOLES FOR POST-INSTALLED ANCHORS IN ACCORDANCE WITH APPLICABLE STANDARDS. MANUFACTURER'S RECOMMENDATIONS AND QUALIFYING (ICC) TEST REPORTS. CARE SHALL BE TAKEN TO PREVENT OVERSIZING, OVALING, AND/OR BLOW-OUT THROUGH THE BACK FACE OF THE DRILLED MEMBER. IF OVERSIZING, OVALING, AND/OR BLOW-OUT OCCURS, THE EMPLOYED EQUIPMENT AND METHODS SHALL BE DISCONTINUED. ADDITIONAL DRILLING SHALL NOT BE RESUMED UNTIL THE SEOR HAS PROVIDED APPROVED REPAIR PROCEDURES. THE CONTRACTOR SHALL BE RESPONSIBLE FOR THE COST OF ALL SUCH REPAIRS. WHEN RESUMING DRILLING, THE CONTRACTOR SHALL MODIFY THE PROCEDURES AS NECESSARY TO PREVENT FURTHER DAMAGE.
- 7. HOLES SHALL BE CLEANED OF DUST AND DEBRIS, USING A WIRE BRUSH AND COMPRESSED AIR OR MANUFACTURER'S BLOW-OUT BULB (AS PER MANUFACTURER'S RECOMMENDATIONS) AS REQUIRED TO REMOVE PARTICULATE DEBRIS AND TO ACHIEVE A RELATIVELY DUST-FREE SURFACE.
- 8. OIL, SCALE, AND RUST SHALL BE REMOVED FROM THE POST-INSTALLED ANCHOR AND HOLES SHALL BE DRY, PRIOR TO
- 9. POST-INSTALLED EMBEDMENT DEPTHS NOTED ON THE PLANS OR DETAILS ARE NOMINAL (I.E. MEASURED FROM FACE OF CONCRETE OR MASONRY TO EMBEDDED TIP OF ANCHOR/REBAR). FOR CORRESPONDING HOLE DEPTH, REFER TO APPLICABLE EVALUATION REPORT.
- 10. ANCHORS IN APPROVED ADHESIVE ANCHOR SYSTEMS SHALL HAVE MINIMUM FY = 36 KSI AND SHALL BE ZINC ELECTROPLATED OR HOT-DIP GALVANIZED AS REQUIRED PER ESR.
- 11. APPROVED ADHESIVE ANCHOR SYSTEMS AND EVALUATION REPORTS ARE AS FOLLOWS:

Α.	CONCRETE:	
	■ HILTI HIT-RE 500 V3	ESR-3814
	 HILTI HIT-HY 200 V3 	ESR-4868
R	HORIZONTAL SLAB-ON-GRADE DOWELS:	

- B. HORIZONTAL SLAB-ON-GRADE DOWELS: HILTI HIT-RE 100 ESR-3829 HILTI HIT-HY 100 ESR-3574
- 12. WHERE NOTED ON SPECIFIC DETAILS, INSTALLATION OF ADHESIVE ANCHORS SHALL BE BY PERSONNEL CERTIFIED BY AN APPLICABLE CERTIFICATION PROGRAM PER ACI 318 SECTION 17.8.2.2. CERTIFICATION SHALL INCLUDE WRITTEN AND PERFORMANCE TESTS IN ACCORDANCE WITH ACI/CRSI ADHESIVE ANCHOR INSTALLER CERTIFICATION PROGRAM. CERTIFICATION DOCUMENTS SHALL BE SUBMITTED TO THE SEOR AND AHJ FOR REVIEW AND ACCEPTANCE PRIOR TO
- 13. APPROVED EXPANSION ANCHORS AND EVALUATION REPORTS ARE AS FOLLOWS:
- A. CONCRETE NOT EXPOSED TO WEATHER:
- HILTI KWIK BOLT-TZ2 ANCHORS ESR-4266 SIMPSON STRONG-TIE STRONG-BOLT 2
- WEDGE ANCHOR ESR-3037 B. CONCRETE EXPOSED TO WEATHER:
- STAINLESS STEEL HILTI KWIK BOLT-TZ2
- ANCHORS ESR-4266 DEWALT POWER-STUD+ SD4 OR SD6 ESR-2502
- STAINLESS STEEL SIMPSON STRONG-TIE STRONG-BOLT 2 WEDGE ANCHOR ESR-3037
- 14. WHERE APPLICABLE, EXPANSION ANCHORS SHALL BE INSTALLED WITH THE MINIMUM TORQUE, USING A CALIBRATED TORQUE WRENCH. WEDGE OR SLEEVE TYPE ANCHORS MUST ATTAIN THE SPECIFIED TORQUE WITHIN ONE HALF TURN OF THE NUT, EXCEPT 1/4" AND 3/8" DIAMETER WEDGE OR SLEEVE TYPE ANCHORS MUST ATTAIN SPECIFIED TORQUE WITHIN ONE QUARTER TURN OF THE NUT.
- 15. INSTALLATION TORQUES FOR EXPANSION ANCHORS SHALL BE AS NOTED BELOW:

EXPANSION ANCHOR MAXIMUM INSTALLATION TORQUE LOADS IN CONCRETE (FT-LB)										
NOMINAL ANCHOR DIAMETER	HILTI KWIK BOLT TZ2	SIMPSON STRONG BOLT 2								
1/4"	4CS/6SS	4								
3/8"	30	30								
1/2"	50CS/40SS	60								
5/8"	40CS/60SS	90CS/ 80 SS								
3/4"	110CS/125SS	150								
1"	185	N/A								

- 16. APPROVED SCREW ANCHORS AND EVALUATION REPORTS ARE AS FOLLOWS:
- A. CONCRETE:
- HILTI KH-EZ OR KH-EZ P ANCHORS ESR-3027
- DEWALT SCREW-BOLT+ ESR-3889 DEWALT ULTRACON+

ITW RED HEAD TAPCON+

- ESR-3068 SIMPSON TITEN HD ESR-2713
- 17. INSTALLATION TORQUES FOR SCREW ANCHORS SHALL BE AS NOTED BELOW:

ESR-3699

NOMINAL ANCHOR DIAMETER	HILTI KH-EZ OR KH-EZ P	SIMPSON TITEN HD	ITW RED HEAD TAPCON+	
1/4"	18	19 AT 1 5/8" EMBED / 25 AT 2 1/2" EMBED	24	20
3/8"	40 (19 AT EMBED < 1 5/8")	25 AT 2" & 2 1/2" EMBED / 40 AT 3 1/4" EMBED	50	50
1/2"	45	45 AT 2 1/2" & 3" EMBED / 60 AT 4 1/4" EMBED	65	70
5/8"	85	60	100	N/A
3/4"	95	70	150	N/A

SCREW ANCHOR MAYIMIM INSTALL ATION

18. SEE SPECIAL INSPECTION AND TESTING NOTES FOR INSPECTION REQUIREMENTS

SPECIAL INSPECTIONS:

- 1. THE OWNER, OR THE OWNER'S AUTHORIZED AGENT (OTHER THAN THE CONTRACTOR AS APPLICABLE) SHALL EMPLOY ONE OR MORE SPECIAL INSPECTORS, INCLUDING AS APPLICABLE AN INSPECTOR OF RECORD (IOR), WHO SHALL PROVIDE SPECIAL INSPECTIONS DURING CONSTRUCTION FOR CERTAIN TYPES OF WORK WHEN SO SPECIFIED IN THE CONTRACT DOCUMENTS AND PROJECT SPECIFICATIONS. WHERE AN IOR IS REQUIRED BY THE GOVERNING AGENCY, THE IOR MAY PERFORM SPECIAL INSPECTIONS IF THAT PERSON IS QUALIFIED PER THE GOVERNING AGENCY'S STANDARDS FOR THE SPECIAL INSPECTION REQUIRED. WHERE AN IOR IS NOT REQUIRED, THESE SPECIAL INSPECTIONS SHALL BE IN ADDITION TO AND COMPLEMENTARY WITH THE INSPECTIONS PROVIDED BY THE GOVERNING AGENCY.
- 2. THE SPECIAL INSPECTOR SHALL BE A QUALIFIED PERSON FROM AN APPROVED AGENCY CONFORMING TO ASTM C1077 WHO SHALL DEMONSTRATE COMPETENCE, TO THE SATISFACTION OF THE ARCHITECT, STRUCTURAL ENGINEER OF RECORD AND THE GOVERNING AGENCY, FOR INSPECTION OF THE PARTICULAR TYPE OF CONSTRUCTION OR OPERATION REQUIRING SPECIAL INSPECTION.
- 3. THE SPECIAL INSPECTOR SHALL OBSERVE THE WORK ASSIGNED FOR CONFORMANCE WITH THE DESIGN DRAWINGS, SPECIFICATIONS AND APPLICABLE WORKMANSHIP PROVISIONS OF THE CODE AND OTHER APPLICABLE REGULATIONS IDENTIFIED WITHIN THE CONSTRUCTION DOCUMENTS. ALL DISCREPANCIES SHALL BE BROUGHT TO THE IMMEDIATE ATTENTION OF THE GENERAL CONTRACTOR FOR CORRECTION AND THEN, IF UNCORRECTED, TO THE ATTENTION OF THE ARCHITECT, STRUCTURAL ENGINEER OF RECORD AND THE GOVERNING AGENCY. IT SHALL BE THE GENERAL CONTRACTOR'S RESPONSIBILITY TO COORDINATE WITH THE SPECIAL INSPECTOR AND SCHEDULE THE SPECIAL INSPECTIONS WITH ADEQUATE TIME TO ADDRESS ANY AND ALL POTENTIAL DISCREPANCIES PRIOR TO PROCEEDING WITH SUBSEQUENT WORK THAT COVERS OR OTHERWISE MAKES INACCESSIBLE ANY WORK IDENTIFIED AS DEVIATING FROM THE PROJECT REQUIREMENTS.
- 4. THE SPECIAL INSPECTOR SHALL FURNISH REGULAR INSPECTION REPORTS TO THE ARCHITECT, STRUCTURAL ENGINEER OF RECORD AND THE GOVERNING AGENCY IDENTIFYING THE WORK INSPECTED AND ANY UNCORRECTED DISCREPANCIES FROM THE CONSTRUCTION DOCUMENTS. AT THE CONCLUSION OF THE PROJECT OR THE SPECIAL INSPECTORS ASSIGNED SCOPE OF WORK, THE SPECIAL INSPECTOR SHALL SUBMIT A FINAL SIGNED REPORT STATING WHETHER THE WORK REQUIRING SPECIAL INSPECTION WAS, TO THE BEST OF HIS OR HER KNOWLEDGE, COMPLETED IN CONFORMANCE WITH THE CONSTRUCTION DOCUMENTS AND SPECIFICATIONS (INCLUDING APPROVED RFI'S, ADDENDUMS, ETC.) AND THE APPLICABLE WORKMANSHIP PROVISIONS OF THE CODE AND OTHER APPLICABLE REGULATIONS IDENTIFIED WITHIN THE CONSTRUCTION DOCUMENTS.
- 5. UNLESS NOTED OTHERWISE, SPECIAL INSPECTIONS INDICATED BELOW SHALL BE PROVIDED IN EITHER A CONTINUOUS OR PERIODIC CAPACITY, AS DEFINED BELOW, AS REQUIRED BY THE INDIVIDUAL CODE OR REFERENCED STANDARD.
- 6. CONTINUOUS SPECIAL INSPECTION BY THE SPECIAL INSPECTOR WHO IS PRESENT WHEN AND WHERE THE WORK TO BE INSPECTED IS BEING PERFORMED.
- 7. PERIODIC SPECIAL INSPECTION BY THE SPECIAL INSPECTOR WHO IS INTERMITTENTLY PRESENT WHERE THE WORK TO BE INSPECTED HAS BEEN OR IS BEING PERFORMED. FOR STRUCTURAL STEEL, PERIODIC INSPECTION IS FURTHER DEFINED SUCH THAT ITEMS ARE OBSERVED ON A RANDOM BASIS.
- 8. FOR STRUCTURAL STEEL WELDING AND BOLTING, SPECIAL INSPECTION SHALL BE PROVIDED IN EITHER AN OBSERVE OR PERFORM CAPACITY AS DEFINED BELOW:
- OBSERVE (O) INSPECTOR SHALL OBSERVE THESE ITEMS ON A RANDOM BASIS PERFORM (P) - INSPECTOR SHALL OBSERVE OR PERFORM SPECIFIED TASK FOR EACH WELDED OR BOLTED JOINT
- 9. QUALITY CONTROL (QC) INSPECTION TASKS SHALL BE PERFORMED BY THE FABRICATOR'S OR ERECTOR'S QC INSPECTOR (QCI) AS INDICATED. QUALITY ASSURANCE (QA) INSPECTION TASKS SHALL BE PERFORMED BY THE QA INSPECTOR (QAI) AS INDICATED. WHEN A TASK IS INDICATED TO BE PERFORMED BY BOTH THE QAI AND QCI, COORDINATION IS PERMITTED SO THAT THE INSPECTION FUNCTIONS ARE PERFORMED BY ONLY ONE PARTY. WHEN THE QAI RELIES ON THE QCI, THE APPROVAL OF THE SEOR AND AGENCY HAVING JURISDICTION IS REQUIRED.
- 10. THE FOLLOWING CONSTRUCTION ELEMENTS AND MATERIALS SHALL BE INSPECTED AND EVALUATED BY A SPECIAL INSPECTOR IN ACCORDANCE WITH THE NOTED CBC SECTIONS AND REFERENCED STANDARDS, WHERE ELEMENTS AND MATERIALS ARE PRESENT ON THE PROJECT. SEE GENERAL NOTES FOR EACH MATERIAL FOR ADDITIONAL REQUIREMENTS, IN ADDITION TO TABLES AND NOTES BELOW:

FOUNDATION SPECIAL INSPECTION TABLES:

OR MEMBER

REQUIRED VERIFICATION AND INSPECTION OF SOILS PER CBC TABLE 1705.6

	VERIFICATION AND INSPECTION	CONTINUOUS DURING TASK LISTED	PERIODICALLY DURING TASK LISTED
1.	VERIFY MATERIALS BELOW SHALLOW FOUNDATIONS ARE ADEQUATE TO ACHIEVE THE DESIGN BEARING CAPACITY		Х
2.	VERIFY EXCAVATIONS ARE EXTENDED TO PROPER DEPTH AND HAVE REACHED PROPER MATERIAL		Х
3.	PERFORM CLASSIFICATION AND TESTING OF COMPACTED FILL MATERIALS		Х
4.	VERIFY USE OF PROPER MATERIALS, DENSITIES AND LIFT THICKNESSES DURING PLACEMENT AND COMPACTION OF COMPACTED FILL	Х	
5.	PRIOR TO PLACEMENT OF COMPACTED FILL, INSPECT SUBGRADE AND VERIFY THAT SITE HAS BEEN PREPARED PROPERLY		Х

FOUNDATION SPECIAL INSPECTION NOTES: 1. FOR STEEL, CONCRETE OR CONCRETE-FILLED ELEMENTS PERFORM ADDITIONAL INSPECTIONS INDICATED BELOW AS APPLICABLE.

CONCRETE SPECIAL INSPECTION TABLE:

REQUIRED VERIFICATION AND INSPECTION OF CONCRETE CONSTRUCTION PER CBC TABLE 1705.3

CONTINUOUS PERIODICALLY

٧.	ERIFICATION AND INSPECTION	DURING TASK LISTED	DURING TASK LISTED	MISC. STANDARDS	CBC
1.	INSPECT REINFORCEMENT, INCLUDING PRESTRESSING TENDONS, AND VERIFY PLACEMENT		Х	ACI 318: CH. 20, 25.2, 25.3, 26.5.1-26.5.3	1908.4
2.	REINFORCING BAR WELDING: A. VERIFY WELDABILITY OF REINFORCING BARS OTHER THAN ASTM A706; B. INSPECT SINGLE-PASS FILLET WELDS, MAX. 5/16"; C. INSPECT ALL OTHER WELDS	X	x x	AWS D1.4 ACI 318: CH 26.5.4	
3.	INSPECTION OF ANCHORS CAST IN CONCRETE		Х	ACI 318: CH 17.8.2	
4.	INSPECT ANCHORS POST-INSTALLED IN HARDENED CONCRETE MEMBERS (SEE NOTE 1 BELOW): A. ADHESIVE ANCHORS INSTALLED IN HORIZONTALLY OR UPWARDLY INCLINED ORIENTATIONS TO RESIST SUSTAINED TENSION LOADS. B. MECHANICAL ANCHORS AND ADHESIVE ANCHORS NOT DEFINED IN 4A.	x	х	ACI 318: CH 17.8.2.4	
5.	VERIFY USE OF REQUIRED DESIGN MIX		Х	ACI 318: CH. 19, 26.4.3, 26.4.4	1904.1, 1904.2, 1908.2, 1908.3
6.	PRIOR TO CONCRETE PLACEMENT, FABRICATE SPECIMENS FOR STRENGTH TESTS (SEE NOTE 2 BELOW), PERFORM SLUMP AND AIR CONTENT TESTS, AND DETERMINE THE TEMPERATURE OF THE CONCRETE	х		ASTM C 172 ASTM C 31 ACI 318: CH 26.4.5, 26.12	1908.10
7.	INSPECT CONCRETE AND SHOTCRETE PLACEMENT FOR PROPER APPLICATION TECHNIQUES	Х		ACI 318: CH 26.4.5	1908.6, 1908.7, 1910.8
3.	INSPECTION FOR MAINTENANCE OF SPECIFIED CURING TEMPERATURE AND TECHNIQUES		Х	ACI 318: CH 5.11-5.13	1908.9
).	INSPECT PRESTRESSED CONCRETE FOR: A. APPLICATION OF PRESTRESSING FORCES B. GROUTING OF BONDED PRESTRESSING TENDONS	x x		ACI 318: CH 26.9.2.1, 26.9.2.3	
0.	INSPECT ERECTION OF PRECAST CONCRETE MEMBERS		Х	ACI 318: CH. 26.8	
1.	VERIFICATION OF IN-SITU CONCRETE STRENGTH, PRIOR TO STRESSING OF TENDONS IN POST- TENSIONED CONCRETE AND PRIOR TO REMOVAL OF SHORES AND FORMS FROM BEAMS AND STRUCTURAL SLABS		х	ACI 318: CH 26.10.2	
2.	INSPECT FORMWORK FOR SHAPE, LOCATION AND DIMENSIONS OF THE CONCRETE MEMBER BEING FORMED		Х	ACI 318: CH 26.10.1(B)	

SPECIFIC REQUIREMENTS FOR SPECIAL INSPECTION ARE INCLUDED IN THE RESEARCH REPORT FOR EACH POST-INSTALLED ANCHOR ISSUED BY AN APPROVED SOURCE. THESE SPECIAL INSPECTION REQUIREMENTS SHOULD BE FOLLOWED. WHERE SPECIFIC REQUIREMENTS ARE NOT PROVIDED, CONTACT STRUCTURAL ENGINEER FOR SPECIAL INSPECTION REQUIREMENTS PRIOR TO PROCEEDING WITH THE WORK. PROJECT SPECIFIC SPECIAL INSPECTION MEASURES SHALL BE APPROVED BY THE GOVERNING AGENCY PRIOR TO THE COMMENCEMENT OF THE WORK.

- 2. A STRENGTH TEST SHALL BE THE AVERAGE OF, AT A MINIMUM, TWO 6x12 CYLINDERS OR THREE 4x8 CYLINDERS MADE FROM THE SAME SAMPLE OF CONCRETE. A TESTING CONCRETE BUT NOT LESS THAN ONE SAMPLE SET FOR EACH 5,000 SQFT OF SURFACE AREA FOR SLABS OR WALLS. IF TOTAL VOLUME OF CONCRETE IS SUCH THAT FREQUENCY OF TESTING WOULD PRODUCE FEWER THAN 5 STRENGTH TESTS FOR A GIVEN CONCRETE MIXTURE, THEN STRENGTH TEST SPECIMENS SHALL BE MADE FROM AT LEAST 5 RANDOMLY SELECTED BATCHES OR FROM EACH BATCH IF FEWER THAN 5 BATCHES ARE USED.
- 3. CONTINUOUS INSPECTION IS REQUIRED DURING THE FABRICATION AND SUBSEQUENT INSPECTION OF SHOTCRETE PRE-CONSTRUCTION TEST PANELS.

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LOS ANGELES COUNTY DEPARTMENT OF PUBLIC WORKS 900 SOUTH FREMONT AVE. 8TH FLOOR ALHAMBRA, CA 91803

PROJECT

CAMP GLENN ROCKEY SECURITY UPGRADES

LOCATION :

1900 N. SYCAMORE ROAD. SAN DIMAS, CA 91773

ARCHITECT



65 N. 1ST AVENUE, SUITE 201 ARCADIA, CA 91006

626-254-8884

E: info@jtcarch.com

JTC PROJECT NO: **37606.0D**






3900 Cover Street, Long Beach CA 90808 • 562.985.3200 Project: 23-0177-00

STRUCTURAL NOTES

02-06-25

DRAWN BY: CHECKED BY: GM/SH SHEET NUMBER:

S-1.01

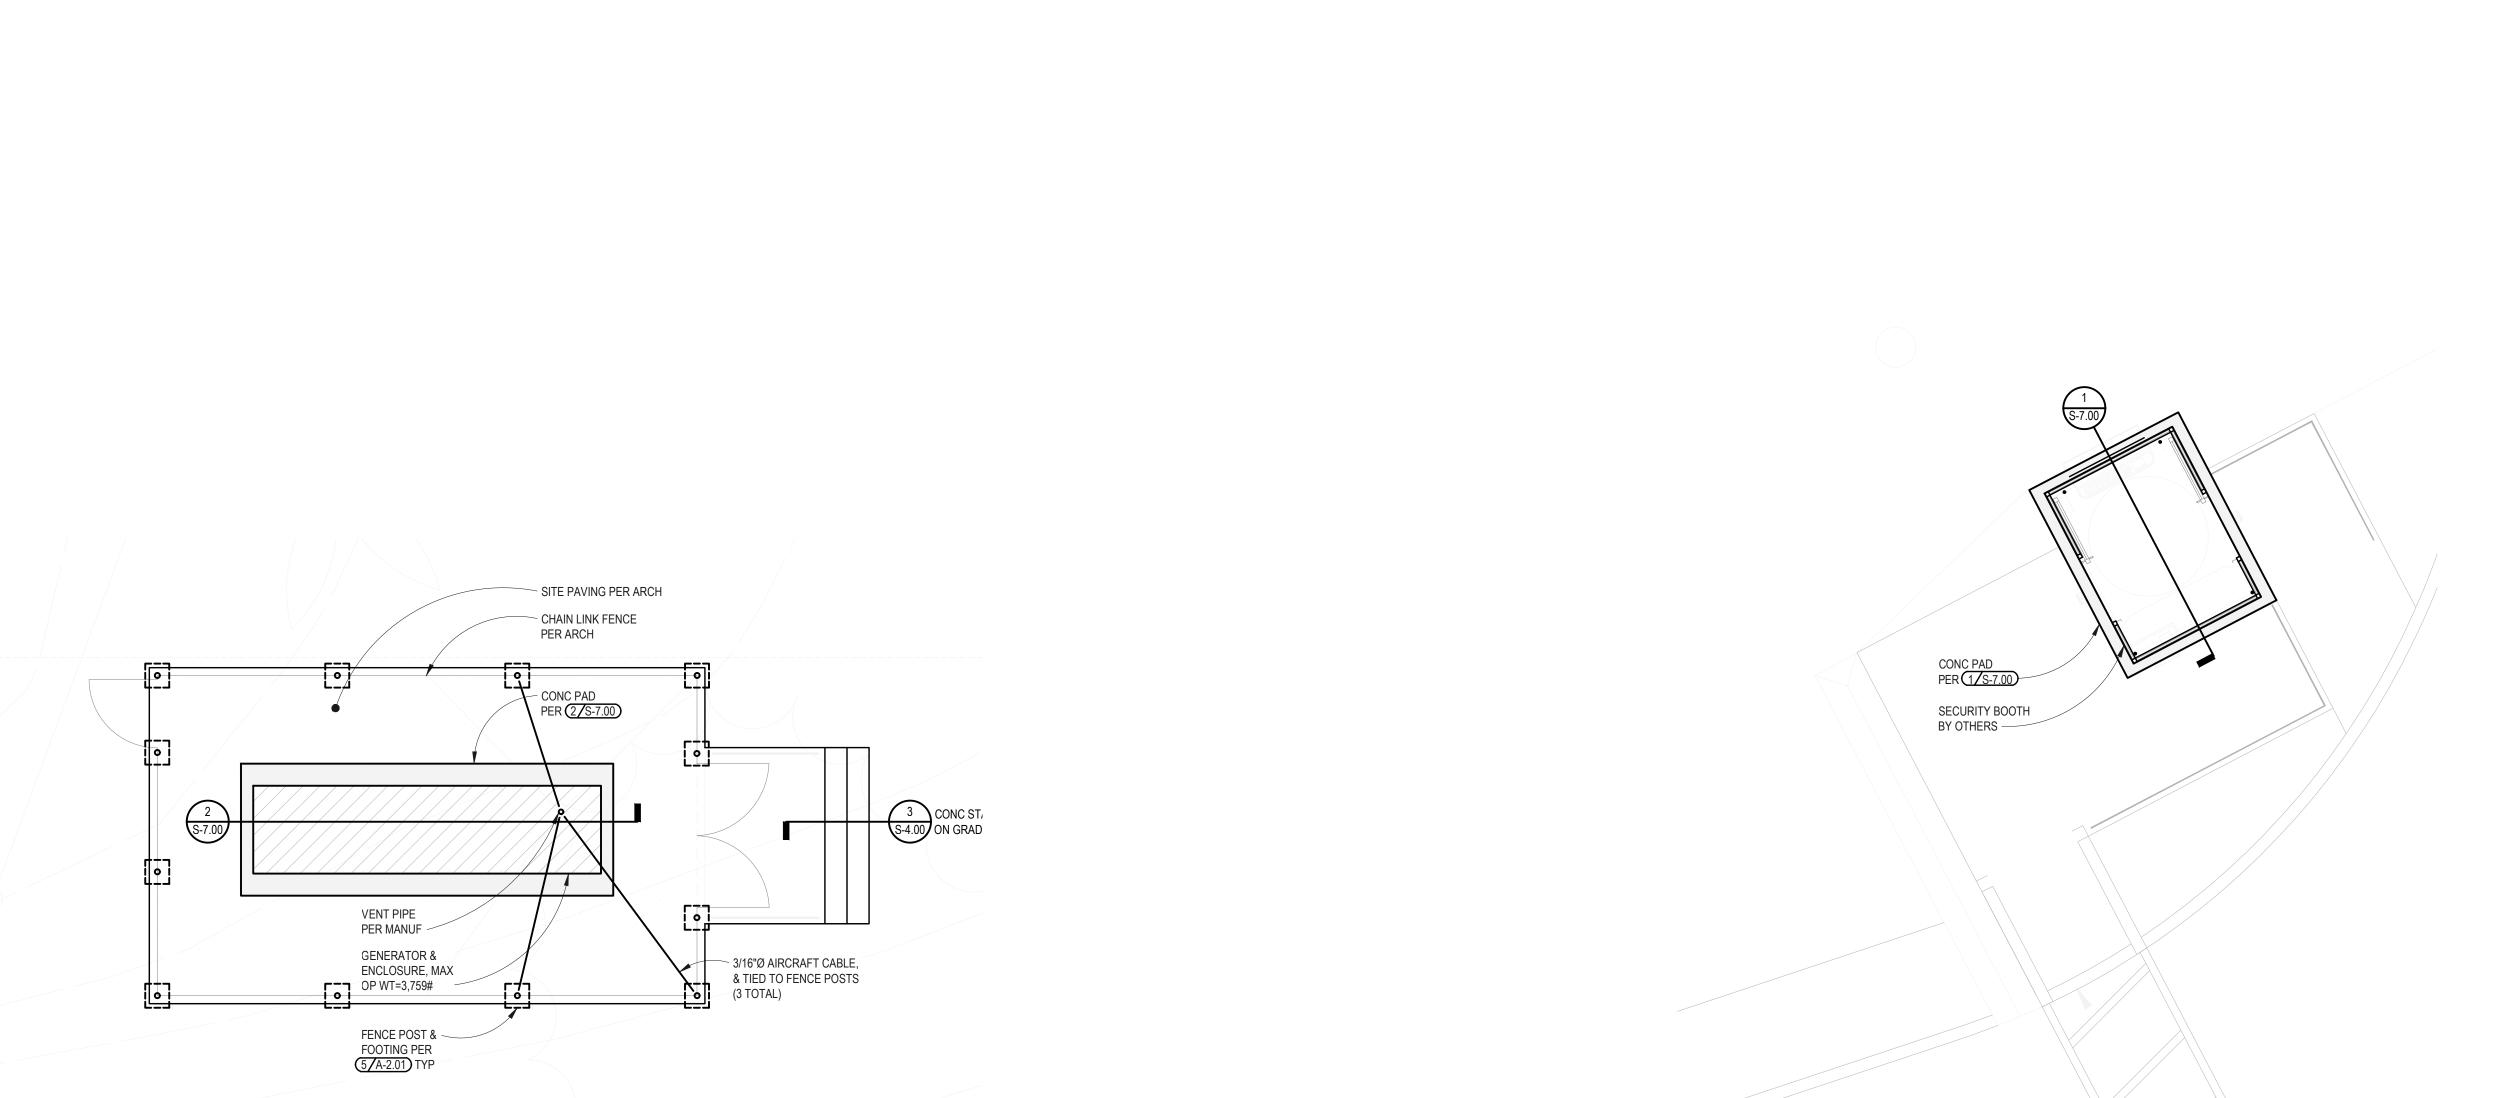

PLAN NOTES

SEE GENERAL NOTES SHEET(S) FOR APPLICABLE NOTES AND ABBREVIATIONS.

EXISTING CONSTRUCTION IS SHOWN FADED AND IS LABELED AS EXISTING OR (E). NEW CONSTRUCTION IS SHOWN DARK AND IS SPECIFICALLY REFERENCED BY DETAILS AND NOTES.

EXISTING CONDITIONS ARE SHOWN TO THE BEST OF OUR KNOWLEDGE. CONTRACTOR IS RESPONSIBLE FOR VERIFYING ACTUAL CONDITIONS. DISCREPANCIES BETWEEN ACTUAL FIELD CONDITIONS AND THOSE SHOWN ON THESE DRAWINGS SHALL BE BROUGHT TO THE ATTENTION OF THE ENGINEER PRIOR TO PROCEEDING.

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DEPARTMENT OF PUBLIC WORKS 900 SOUTH FREMONT AVE. 8TH FLOOR ALHAMBRA, CA 91803

PROJECT :

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LOCATION:

1900 N. SYCAMORE ROAD, SAN DIMAS, CA 91773

ARCHITECT :

JTC architects, inc.

65 N. 18T AVENUE, SUITE 201 ARCADIA, CA 91006

T: 626-254-8884 E: info@jtcarch.com

JTC PROJECT NO: 37606.0D





LONG BEACH . SAN DIEGO 3900 Cover Street, Long Beach CA 90808 • 562.985.3200 Project: 23-0177-00

PARTIAL SITE PLAN

SCALE:	AS NOTED
DATE:	02-06-25
DRAWN BY:	JA
CHECKED BY:	GM/SH


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PARTIAL SITE PLAN - NEW SECURITY BOOTH


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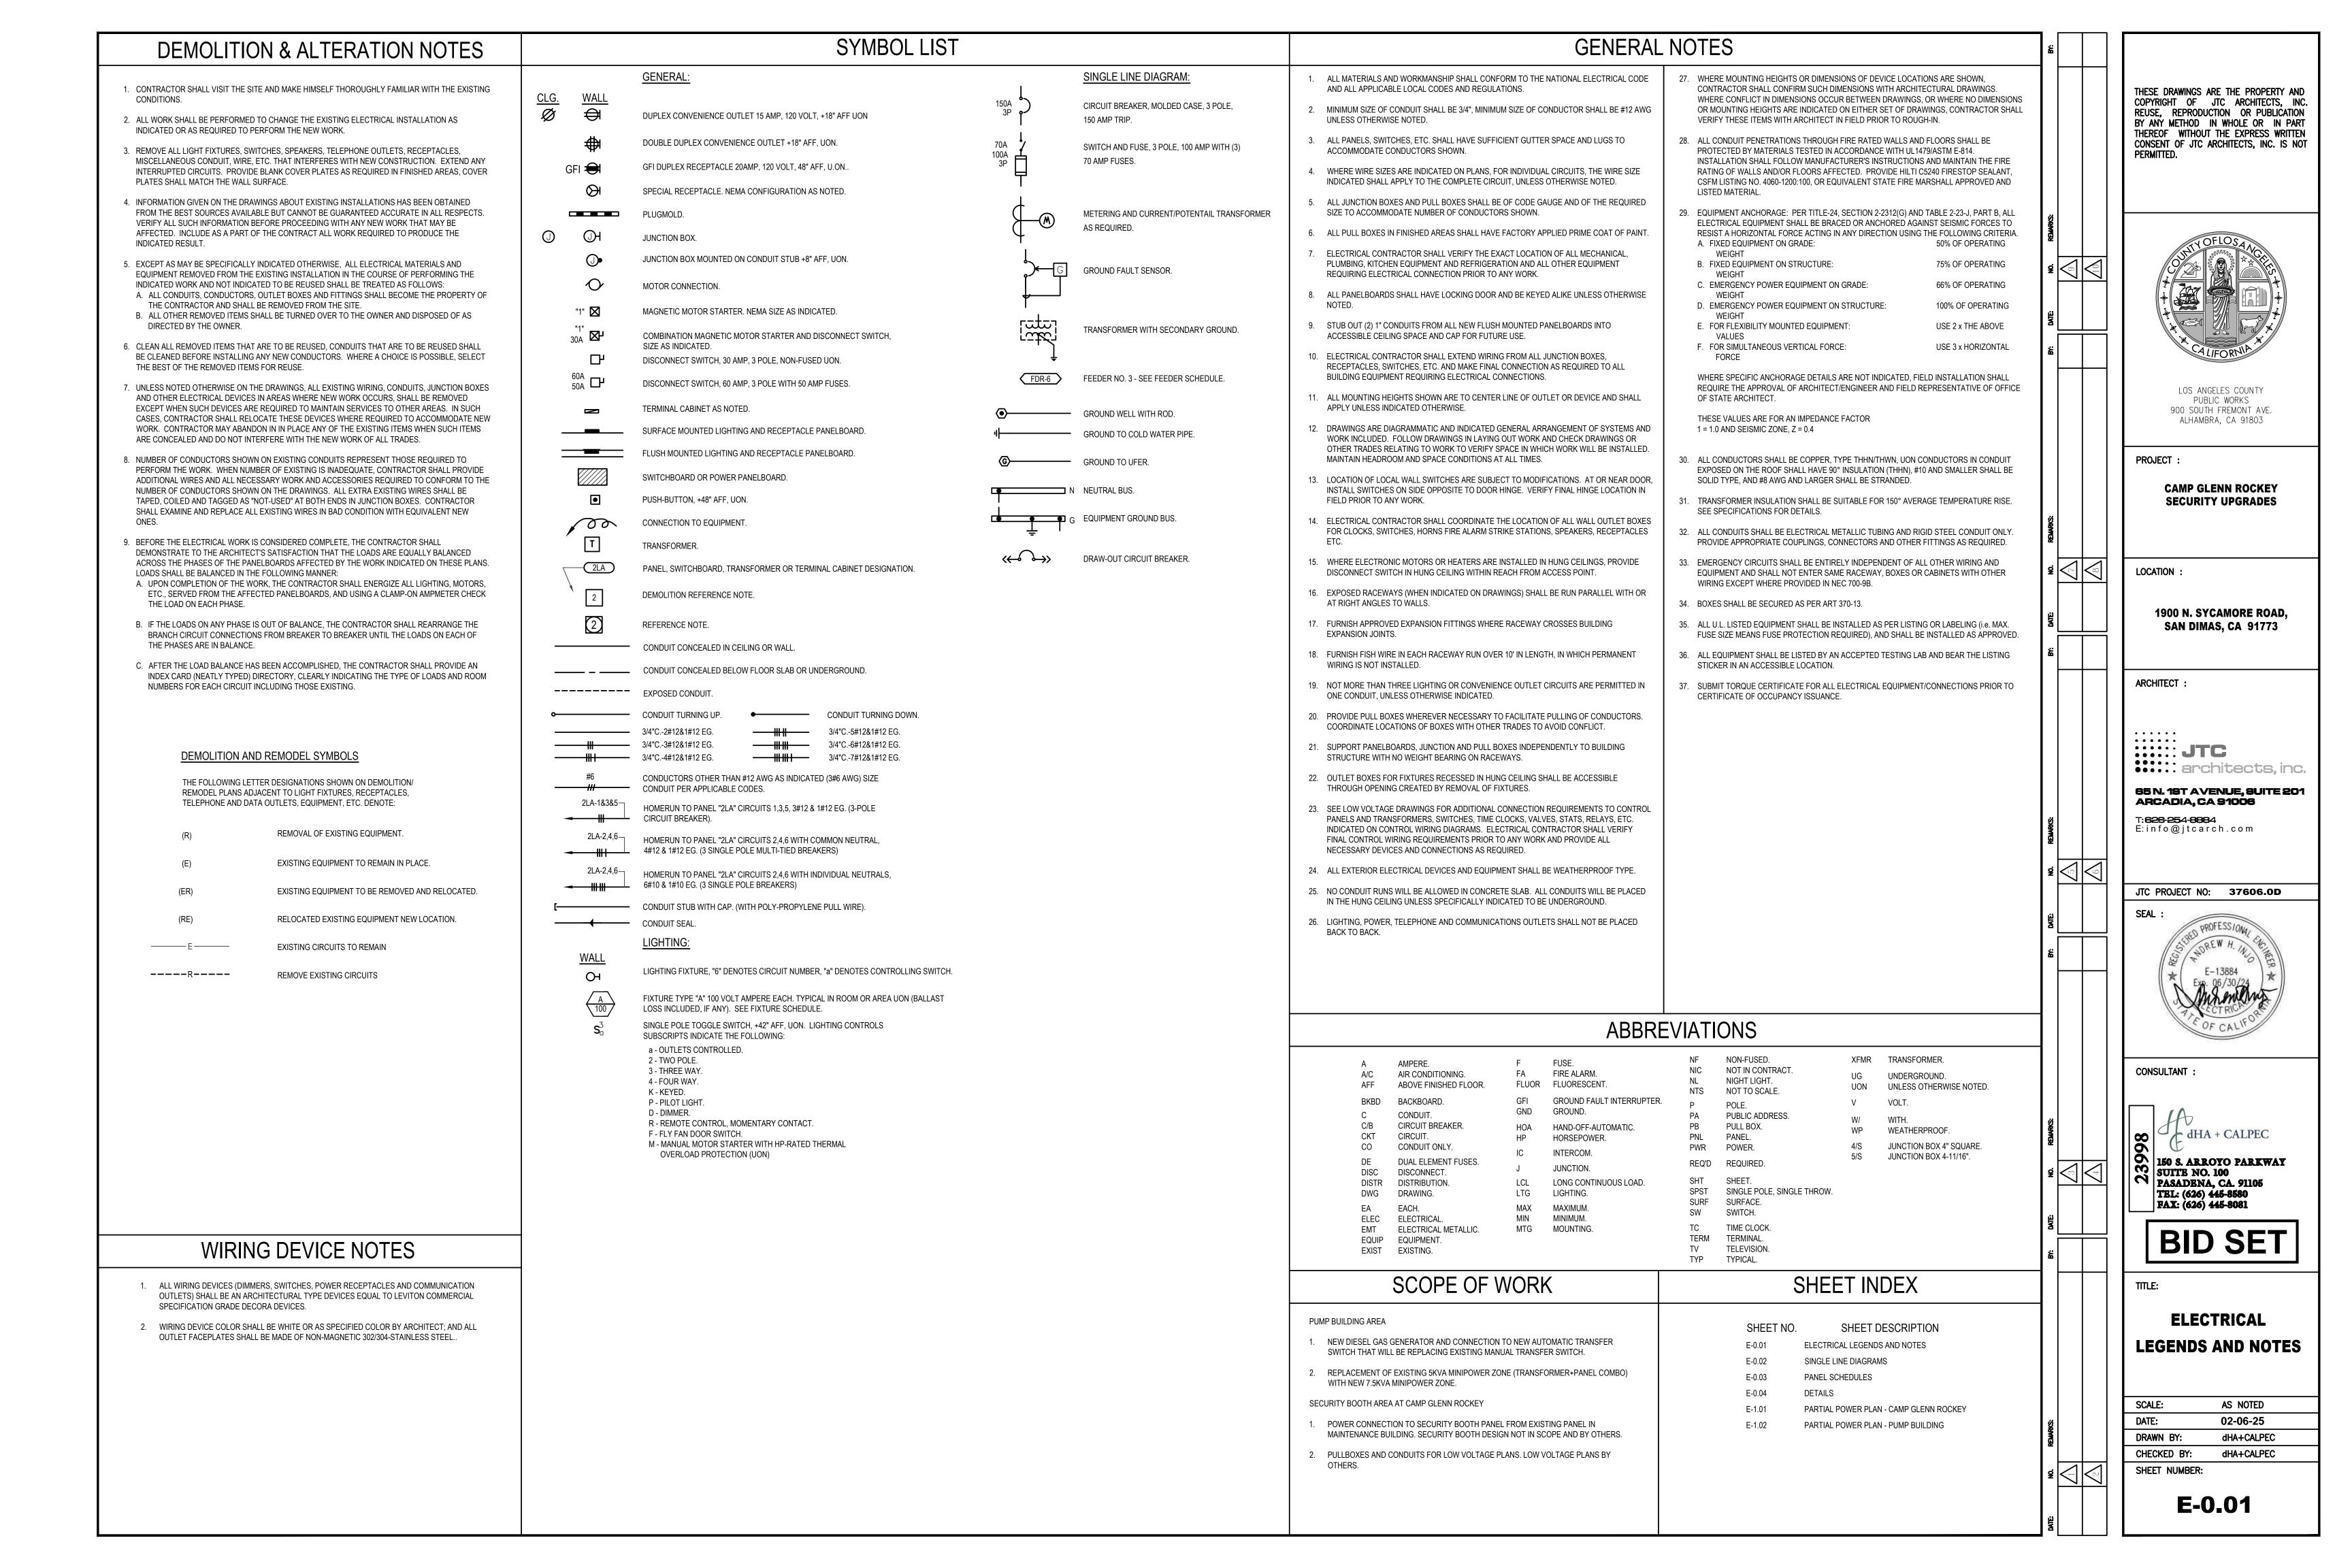
PARTIAL SITE PLAN - NEW GENERATOR


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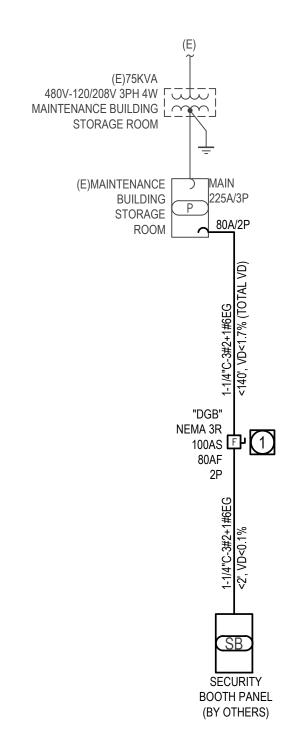
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SINGLE LINE (PUMP BUILDING)



PARTIAL SINGLE LINE (SECURITY BOOTH AREA)

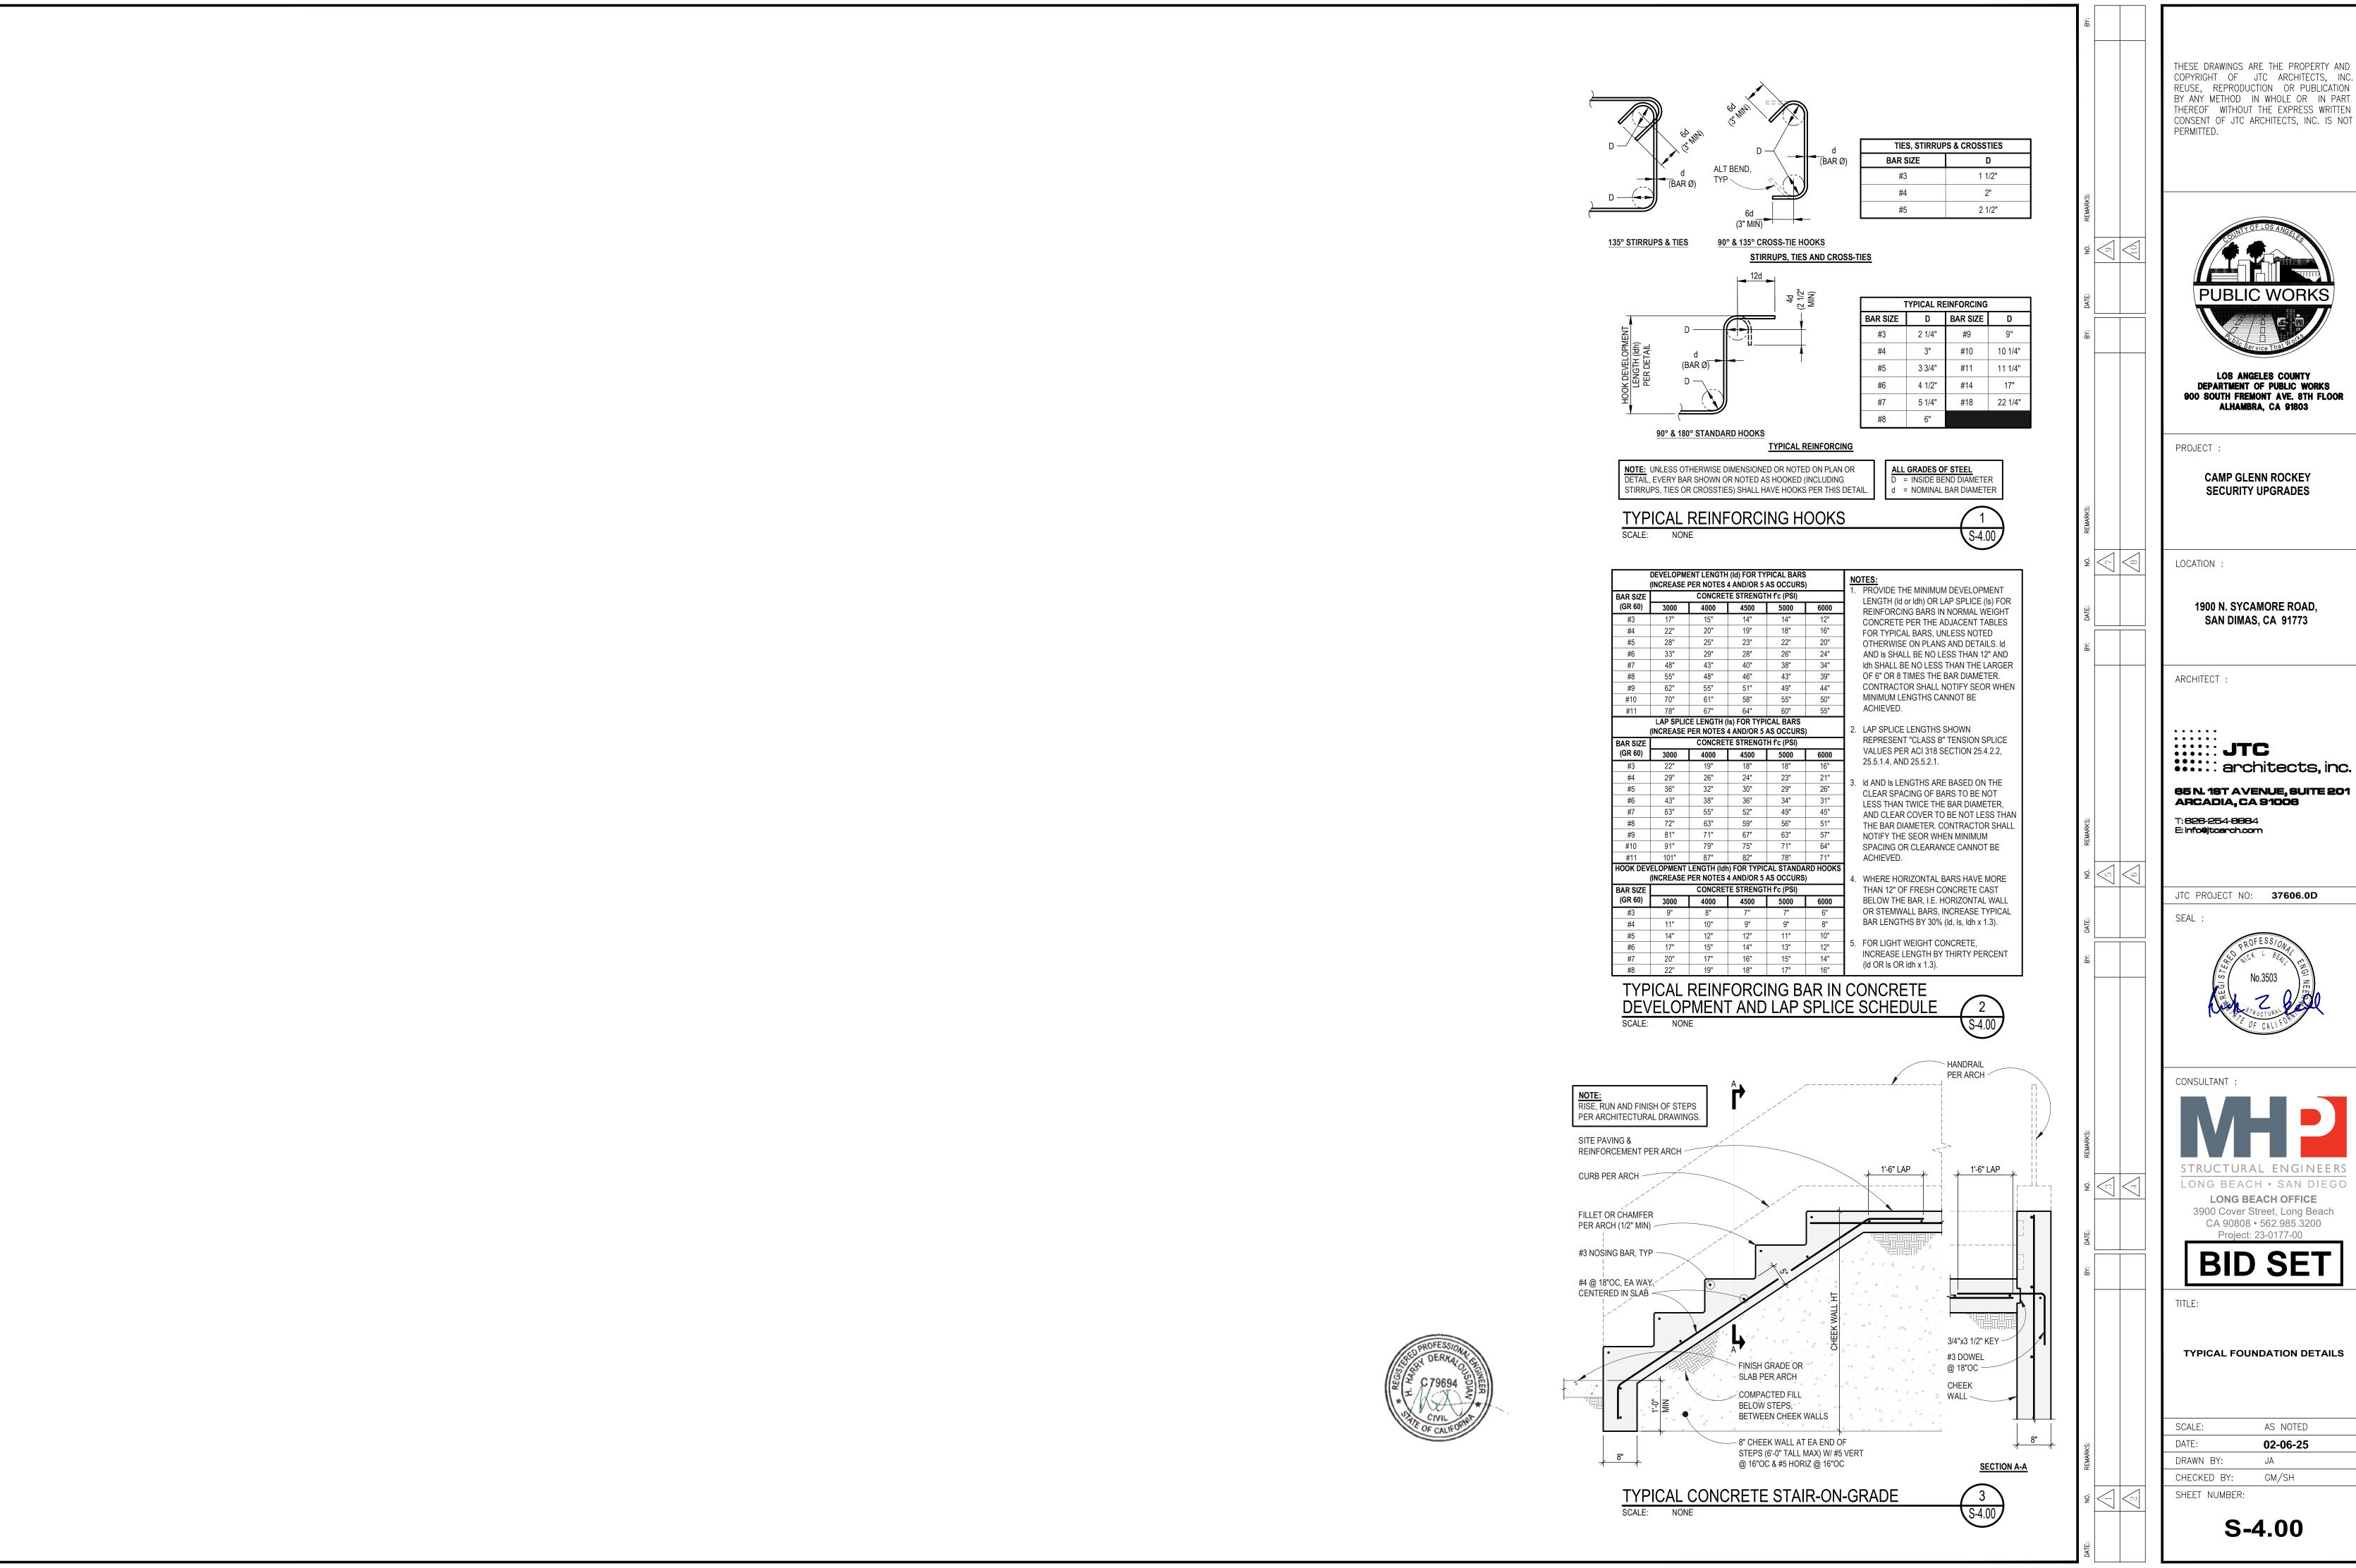GENERATOR NOTES

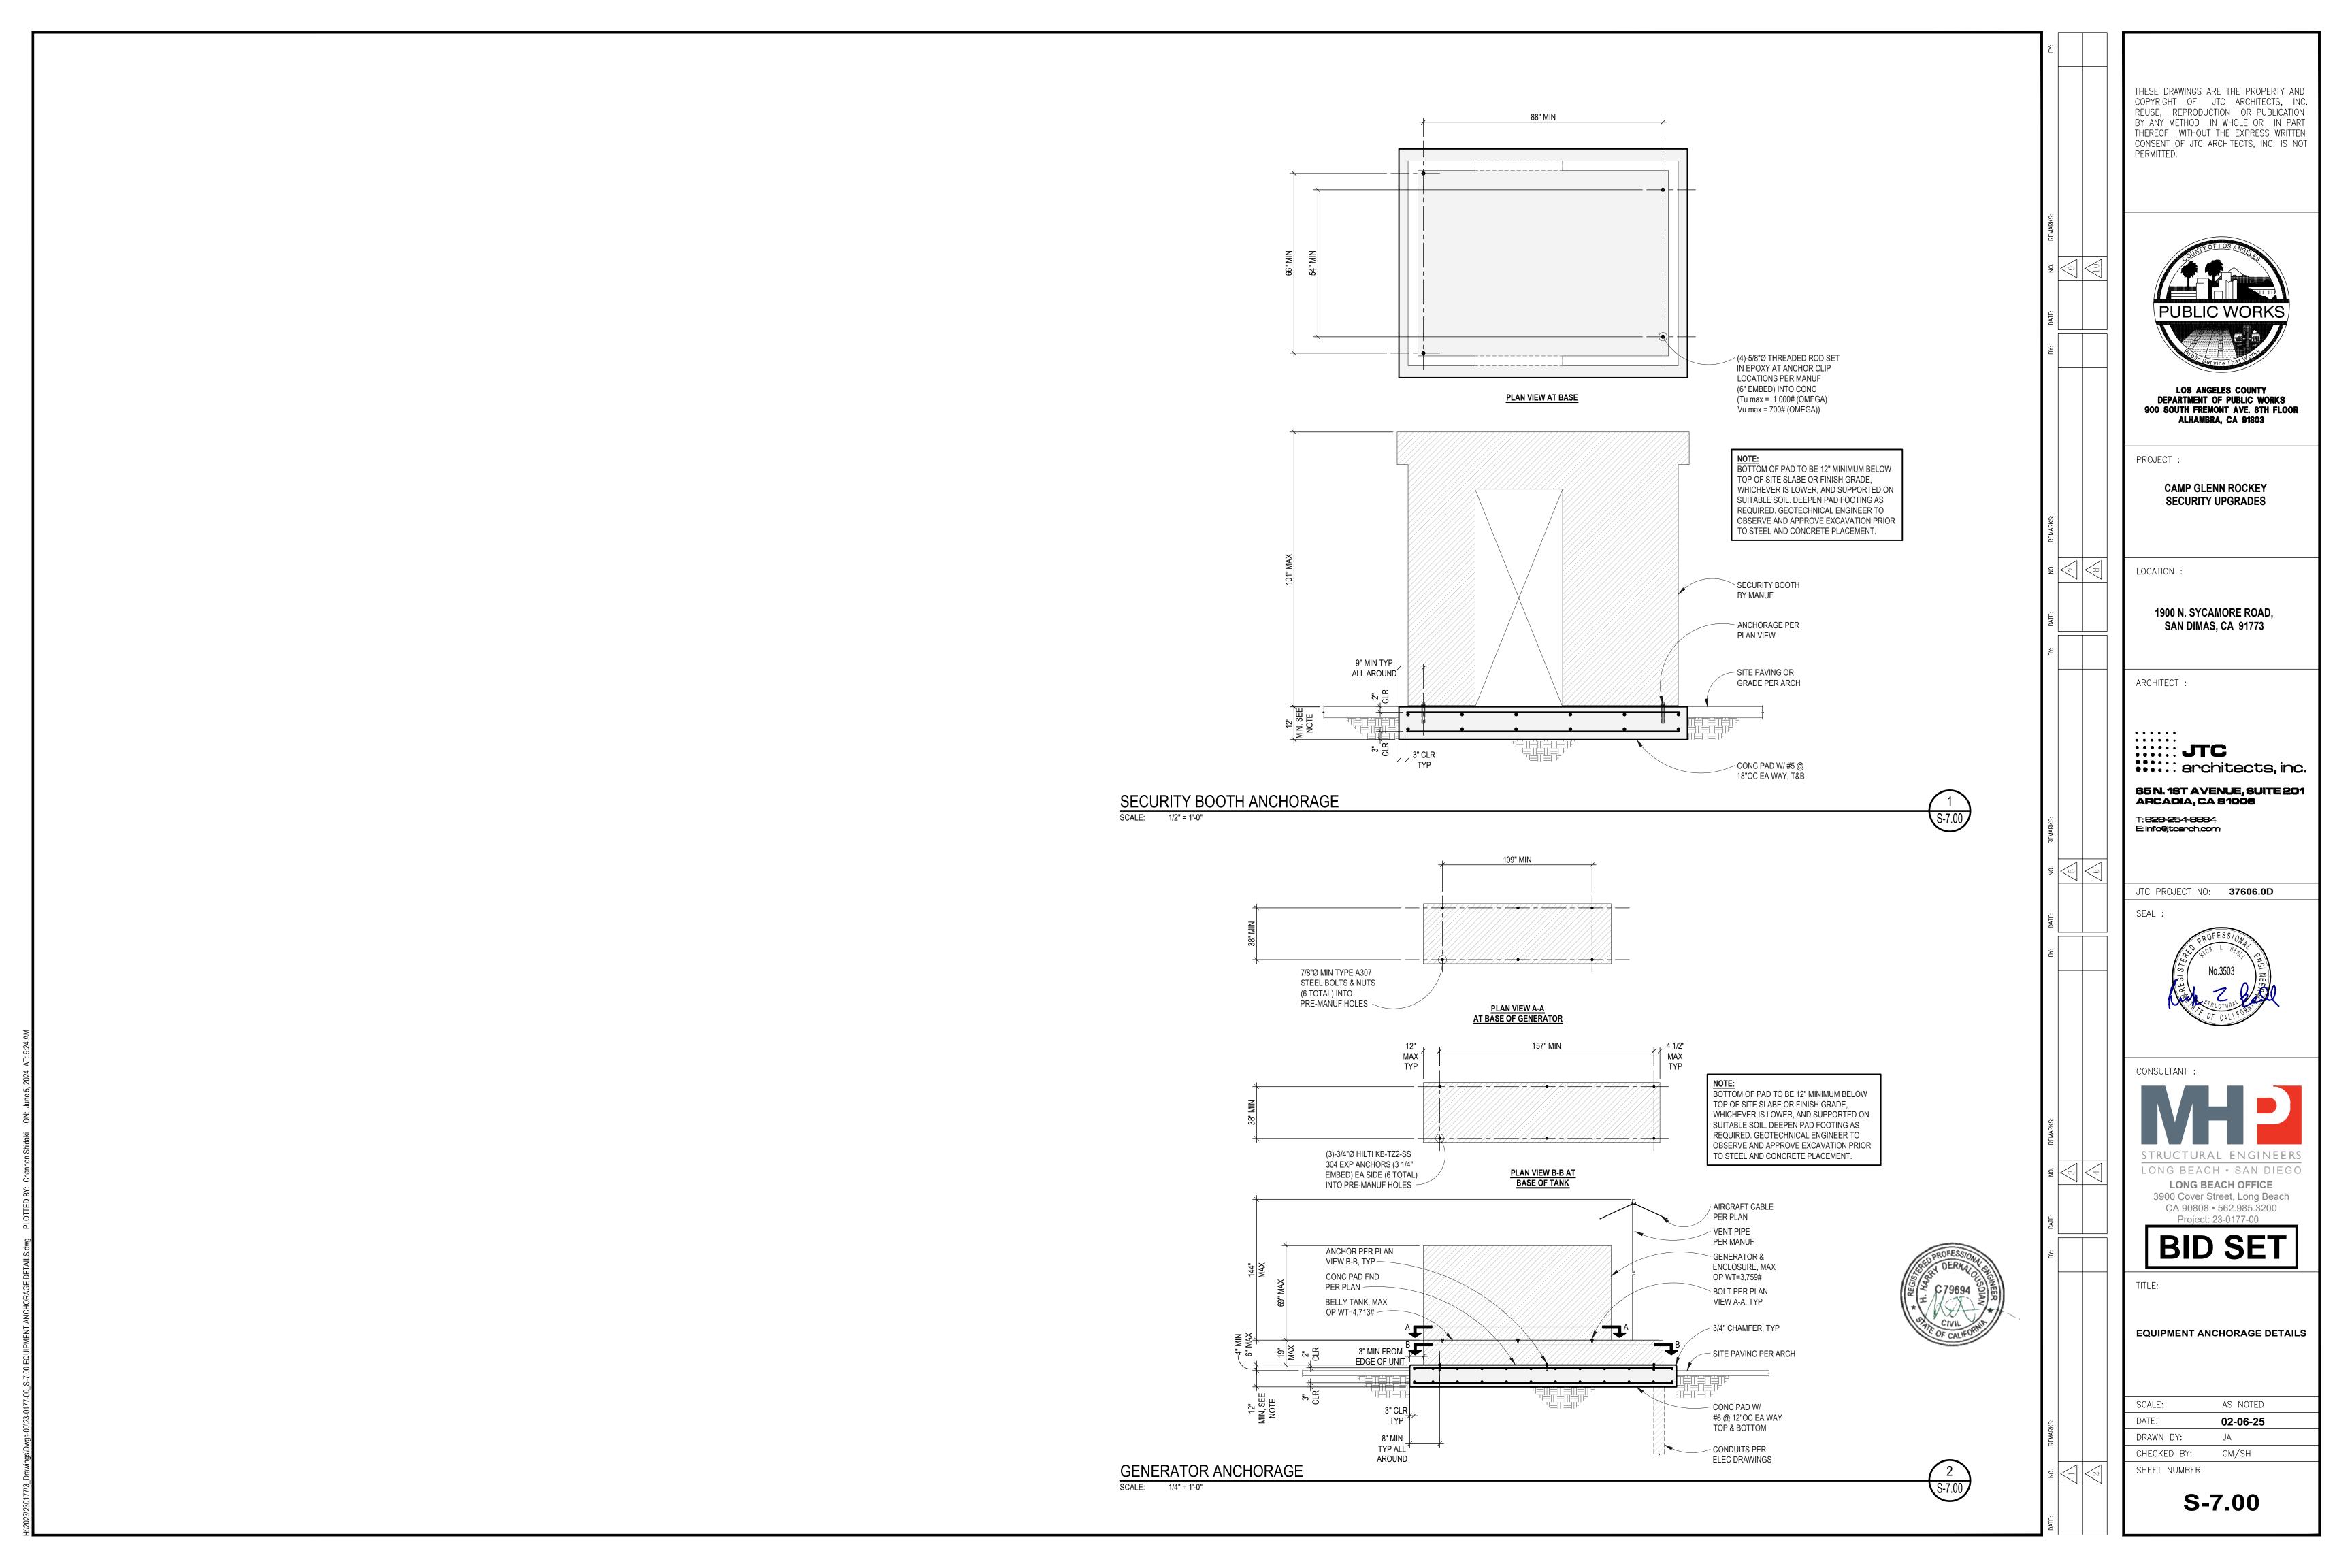- GENERATOR AND REMOTE ANNUNCIATOR ARE BASED ON KOHLER PRODUCTS, UNLESS OTHERWISE NOTED. ANY REVISIONS MADE DUE TO SUBSTITUTIONS MADE SHALL BE THE SOLE RESPONSIBILITY OF THE CONTRACTOR.
- 2. IT IS THE CONTRACTOR'S RESPONSIBILITY TO COORDINATE WITH LOCAL JURISDICTION, FIRE DEPARTMENT, AQMD, ETC.. AND PULL ASSOCIATED PERMITS.
- GENERATOR & REMOTE ANNUNCIATOR SHALL HAVE THE CAPABILITY TO COMMUNICATE WITH FUTURE USER LAN NETWORK. PROVIDE MODBUS/ETHERNET CONVERTERS AS REQUIRED AT PUMP HOUSE FOR FUTURE LAN CONNECTION. COORDINATE WITH ATS/GENERATOR VENDOR FOR FURTHER DETAILS REGARDING LOW VOLTAGE CONNECTIONS NOT
- GENERATOR SET, 150KW/188KVA @ 0.8PF, 480V-3PH-3W, 60HZ IN NEMA 3R QUIET LEVEL-2 ENCLOSURE, ALTERNATOR SHALL BE SUPPLIED WITH OUTPUT 200A/3P CIRCUIT BREAKER, SKID MOUNTED ABOVE GROUND WITH MINIMUM 24-HOUR FUEL STORAGE TANK, AND REMOTE SAFETY SHUT OFF SWITCH (TO BE LOCATED AT ENTRANCE OF GENERATOR ENCLOSURE).
- 5. FUEL TANK SHALL BE A SUB-BASE TYPE, UL 142 STEEL PRIMARY AND SECONDARY TANK WITH INTERSTITIAL LEAK MONITORING TUBE AND REFUELING SPILL BOX KIT WITH ACCESSORIES INSTALLED, MINIMUM 5 GAL CAPACITY AND PAD LOCKABLE.
- CONTRACTOR SHALL PROVIDE COMMISSIONING REPORT AS REQUIRED AFTER GENERATOR INSTALLATION, TESTING AND INSPECTIONS ARE COMPLETE.

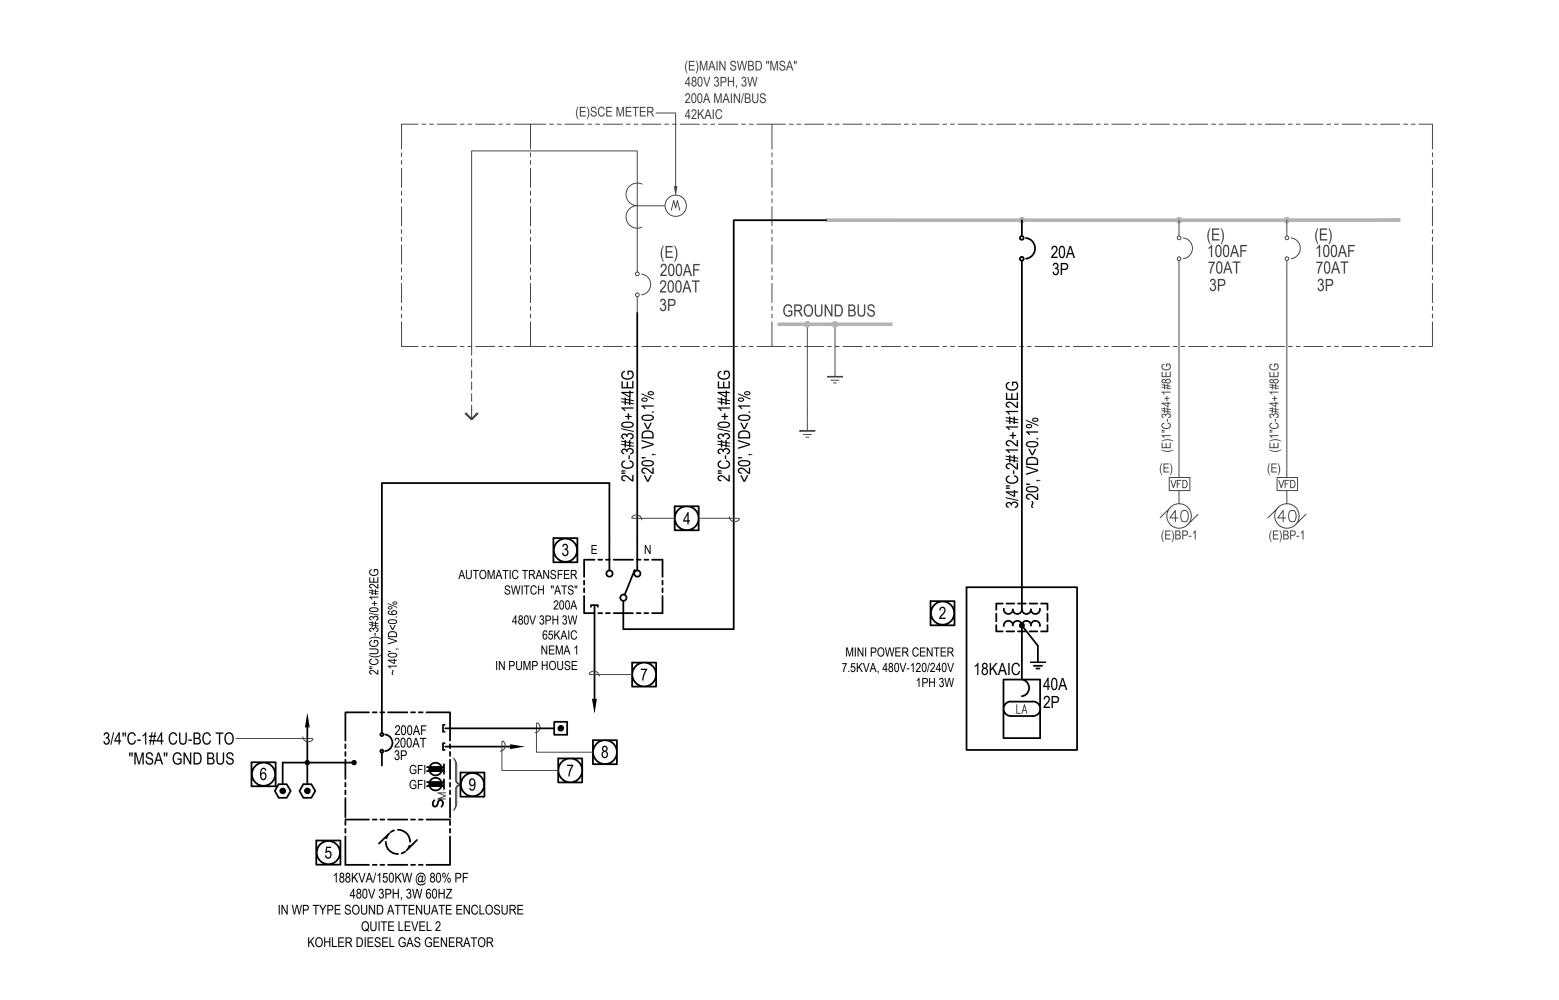SHEET NOTES

SCREENED ITEMS DENOTES EXISTING (E) EQUIPMENT TO REMAIN IN PLACE U.O.N.

2. BOUNDARY IN DASH-DOT-DOT-DASH LINES DENOTES THE SCOPE OF

3. ALL EXISTING DEVICE/BREAKERS/FEEDERS INFORMATION DATA REQUIRED FOR SHORT CIRCUIT STUDY SHALL BE PROVIDED BY

WORK ITEMS UNLESS NOTED OTHERWISE

ELECTRICAL CONTRACTOR.

GENERAL NOTES

- ALL CIRCUIT BREAKERS SHALL BE 3 POLES MCCB TYPE CIRCUIT BREAKER, UNLESS OTHERWISE NOTED.
- 2. MINIMUM CIRCUIT BREAKER AMPERE INTERRUPTING CAPACITY SHALL BE 10,000 AMPS FOR 208/120V-3PH-4W BRANCH CIRCUIT PANEL BOARD, AND 14,000 AMPS FOR 480/277V-3PH-4W LIGHTING PANELBOARD IF NONE IS
- PROVIDE PERMANENT BRANCH CIRCUIT NUMBER FOR EACH PANELBOARD, GLUE ON STICKER NUMBER IS NOT ACCEPTABLE.
- 4. PROVIDE EQUIPMENT NAME PLATE FOR EACH EQUIPMENT; NAME PLATE SHALL BE SECURED WITH METAL SHEET SCREWS, GLUE ON ATTACHMENT NOT ACCEPTABLE.
- 5. FEEDER LENGTHS ARE SHOWN FOR CALCULATION PURPOSES ONLY AND SHALL NOT BE USED FOR BIDDING/MATERIAL TAKE-OFF.
- 6. PROVIDE FULLY RATED OVERLOAD PROTECTION DEVICE/CIRCUIT BREAKER SYSTEM, SERIES RATED CIRCUIT BREAKERS WILL NOT BE
- 7. FUSES FOR MOTOR SERVICE DISCONNECT SWITCH SHALL BE TIME DELAY AND DUAL ELEMENT TYPE.
- 8. OVERSIZED FEEDER CONDUCTOR (TO REDUCE VOLTAGE DROP) THAT DOES NOT CONFORM TO STANDARD LUG SIZE SUPPLIED WITH SWITCHGEAR SHALL BE SPLICED BY CONTRACTOR UTILIZING THE POLARIS TYPE INSULATED LUGS WITH APPROPRIATE NUMBER OF PORTS (OR EQUAL). CONTRACTOR SHALL PROVIDE REQUIRED SPLICINGS, J-BOX AND OR GUTTER SPACE AS REQUIRED ACCORDINGLY.

REFERENCE NOTES

- PROVIDE 100AS/80AF/2P FUSED SERVICE ENTRY DISCONNECT IN NEMA 3R ENCLOSURE ON SECURITY BOOTH FOR CONNECTION TO SECURITY BOOTH PANEL AND GROUND RODS.
- REMOVE EXISTING 5KVA MINI-POWER ZONE (AND ASSOCIATED FEEDER) AND REPLACE WITH 7.5KVA 1PHASE 480V-120/240V MINI-POWER ZONE (18kA) SQUARE D #MPZB7S40F AND ASSOCIATED FEEDER AS NOTED. ADD NEW OR REPLACE EXISTING CIRCUIT BREAKER ON SWITCHBOARD WITH NEW 20A/2P CIRCUIT BREAKER. FIELD VERIFY.
- REPLACE EXISTING MTS WITH NEW KOHLER NEMA 1 ATS #KCS-AMTA-0200S WITH ETHERNET COMMUNICATIONS, EXTENDED LIMITED WARRANTY, HEATER ANTI-CONDENSATION, SEISMIC CERTIFICATION, AND RSA III REMOTE ANNUNCIATOR. REMOTE ANNUNCIATOR TO BE LOCATED IN PUMP HOUSE. COORDINATE WITH ATS/GENERATOR VENDOR FOR FURTHER DETAILS.
- UTILIZE EXISTING CONNECTIONS AND EXTEND AS REQUIRED TO NEW ATS INDOORS. FIELD VERIFY.
- FURNISH AND INSTALL DIESEL ENGINE GENERATOR SET, REFER TO GENERATOR NOTES.
- PROVIDE GROUND WELL WITH GROUND ELECTRODE WITH 1#4 CU-BC (UON) IN 3/4"C. GROUND RESISTANCE SHALL BE TESTED AND RESISTANCE TO GROUND VALUE SHALL BE LESS THAN 5 OHMS -ADDITIONAL GROUND ELECTRODE WITH MIN. 10FT APART SHALL BE ADDED TILL RESISTANCE VALUES LESS THAN 5 OHMS. REFER TO DETAIL
- PROVIDE 1"C FROM GENERATOR WITH ITEMS NOTED BELOW AND REFER TO POWER PLAN FOR REFERENCE:
- 2#12 (START/STOP SIGNAL): BETWEEN GENERATOR TO ATS
- BELDEN 9841 (COMMUNICATIONS) BETWEEN GENERATOR TO MODBUS/ETHERNET CONVERTER IN PUMP BUILDING. • 2#12 (DC BATTERY POWER): BETWEEN GENERATOR TO (2) MODBUS
- CONVERTERS AND (1) REMOTE SERIAL ANNUNCIATOR IN PUMP HOUSE. FIELD COORDINATE WITH GENERATOR VENDOR.
- PROVIDE 1/2"C-2#14 FOR CONNECTION TO REMOTE EMERGENCY STOP OUTSIDE GENERATOR YARD ENTRANCE. FIELD VERIFY EXACT LOCATION.
- PROVIDE (2) NEMA 5-20R GFCI DUPLEX RECEPTACLES FOR CONNECTION TO WATER HEATER JACKET PLUG AND BATTERY CHARGER PLUG-IN AND A SWITCH FOR CONNECTION TO ALTERNATOR HEATER WITHIN GENERATOR SET. FIELD COORDINATE WITH GENERATOR VENDOR FOR LOCATION OF RECEPTACLES.

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:626-254-8884 E:info@jtcarch.com

JTC PROJECT NO: 37606.0D

CONSULTANT:



TEL: (626) 445-8580

FAX: (626) 445-8081

TITLE:

SINGLE LINE **DIAGRAMS**

AS NOTED 02-06-25 DATE: DRAWN BY: dHA+CALPEC CHECKED BY: dHA+CALPEC

SHEET NUMBER:

E-0.02

PUMP HOUSE 7.5KVA MINI-POWER ZONE LA PHASE: 1 WIRE: 3 MOUNTING: SURFACE

240 / 120 LOCATION: PUMP HOUSE DISTANCE: -- FT

100 AMP FED FROM: MAIN SWBD "MSA" POLES: 16

40 AMP MAIN TYPE: AUTO C.B. SPARE CAP: 0.0 % VOLTAGE **BUS AMPERE** MAIN C/B CIRCUIT T E T T I CIRCUIT **KVA** G C R G S BREAKER A DESCRIPTION (EXISTING) 6 20 / 1 0.20 1 (1) LIGHTING

 1 (1) LIGHTING
 (EXISTING)
 6
 20 / 1
 0.20

 2 (1) RECEPTACLES
 (EXISTING)
 3
 20 / 1
 0.54

 3 (1) CONTROL PANEL
 (EXISTING)
 1 20 / 1

 4 (1) EXTERIOR LIGHTING
 (EXISTING)
 1
 20 / 1

 5 EXTERIOR RED LIGHT & CONTACTOR
 1 20 / 1
 0.11

 6 GENERATOR BATTERY CHARGER
 1 20 / 1
 1.20

 7 GENERATOR ALTERNATOR HEATER
 1 20 / 1

 0.10 4 1 20/1 8 GENERATOR WATER HEATER
9 GENERATOR YARD SERVICE REC
10 SPARE 1.80 1 20 / 1 1.00 20 / 1 0.00 20 / 1 11 SPARE 0.00 12 SPARE 20 / 1 0.00 20 / 1 0.00 20 / 1 13 SPARE 14 SPARE 15 SPARE 16 SPARE 0.00
 CONN LOAD
 =
 5.25 KVA
 TOTAL BY PHASE (KVA) =
 3.05

 MIN FDR =
 22 AMP
 MIN C/B =
 22 AMP
 LGST MTR =
 0 AMP
 2.20 SPARE = 0.00 KVA LCL(LTG+HTG) = 0.30 KVA 25% LCL = 0.08 KVA CONN LOAD + 25% LCL = 5.33 KVA (1) RECONNECT EXISTING CONNECTIONS FROM REMOVED 5KVA MINI-POWER ZONE. SECURITY BOOTH

PAN	NEL :	(E) SB		PHASE:		1		WIR	RE:	3	MO	UNTING :	SURFACE	
VOI	TAGE :	208	/ 120	LOCATIO	N :	S	ECU	IRITY	/ BC	HTO	DIS	TANCE :	FT	
BUS	S AMPERE :	125	AMP	FED FRO			VEL "	'P" (N	/IAIN	T. BLD)	PO	LES :	12	
MA	N C/B :	N/A	AMP	MAIN TY	PE:			M.L.	.O.		SPA	ARE CAP:	0.0 %	
= ,	= ===== ====	== =====	=====	======	==	==	==	==	==	=== =	==	=========	: ====== ==	= ==
					L	R	M	Н	M			CIRC		
CK					Т	E	Т	Т	I	CIRCI		KVA		С
NO	DE	SCRIPTION			G	C	R	G	S	BREAK	(ER	Α	С	N
=	= ===== ===	== =====	= ====	======	==	==	==	==	===	=====	===		==========	= ==
1	(E) HVAC UNIT						1			30 /	2	2.42	4	_ 1
	(E) (1) INTERIOR	R & (2) EXTE	RIOR LTS	5	3					20 /	1	0.04	0.10	2
	(E) W/ CKT 1									/			2.42	3
	(E) DUPLEX RE					2				20 /	1		0.36	4
	(1) NEMA 6-30F	ROUTLET							1	30 /	2	2.50	4	5
	(1) SPARE									20 /	1	1.00		6
	(1) W/ CKT 5									/			2.50	7
_	(1) SPARE									20 /	1	2.22	1.00	8
9	SPACE									/	1	0.00	4	9
10	SPACE									/	1	0.00	0.00	10
11	SPACE									/	1		0.00	1
12	SPACE									/	1		0.00	12
==	== ===== ====	40.00	= ====	======	==	==	==	==	==	=== =	==		======= ==	= ==
	NN LOAD =	12.23	at we a deal a						•	(VA) =		5.96	6.27	20
	- 00 - 00 - 00 - 00 - 00 - 00 - 00 - 0	65 AMP	MIN C/E		100	AM			SIN	TR =		AMP	SPARE = 0.0	ector summ
LCL	(LTG+HTG) =	0.04	KVA	25% LCL	= 1	0.01	KV/	4		CONN	LOA	.D + 25% LCL =	= 12.24	KV

GENERAL NOTES 1. CONTRACTOR TO PROVIDE NEATLY TYPED PANEL DIRECTORIES FOR THESE DRAWINGS ARE THE PROPERTY AND PANELS WITH UPDATED/BOLDED DESCRIPTIONS (AS APPLICABLE).

2. MULTIWIRE BRANCH CIRCUITS (TWO OR MORE UNGROUNDED

CEC 210.4 (B).

CONDUCTORS) WITH SHARED NEUTRAL SHALL BE PROVIDED WITH A

MEANS TO SIMULTANEOUSLY DISCONNECTING ALL THE UNGROUNDED

CONDUCTORS AT THE POINT OF BRANCH CIRCUIT ORIGINATES - 2022

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JTC architects, inc.

65 N. 18T AVENUE, SUITE 201 ARCADIA, CA 91006

r:**626-254-888**4 E:info@jtcarch.com

JTC PROJECT NO: 37606.0D

CONSULTANT:



150 S. ARROYO PARKWAY SUITE NO. 100 PASADENA, CA. 91105 TEL: (626) 445-8580 FAX: (626) 445-8081

PANEL KEY

LA

PANEL SCHEDULES

SCALE:	AS NOTED
DATE:	02-06-25
DRAWN BY:	dHA+CALPEC
CHECKED BY:	dHA+CALPEC
CHEET MUMDED.	_


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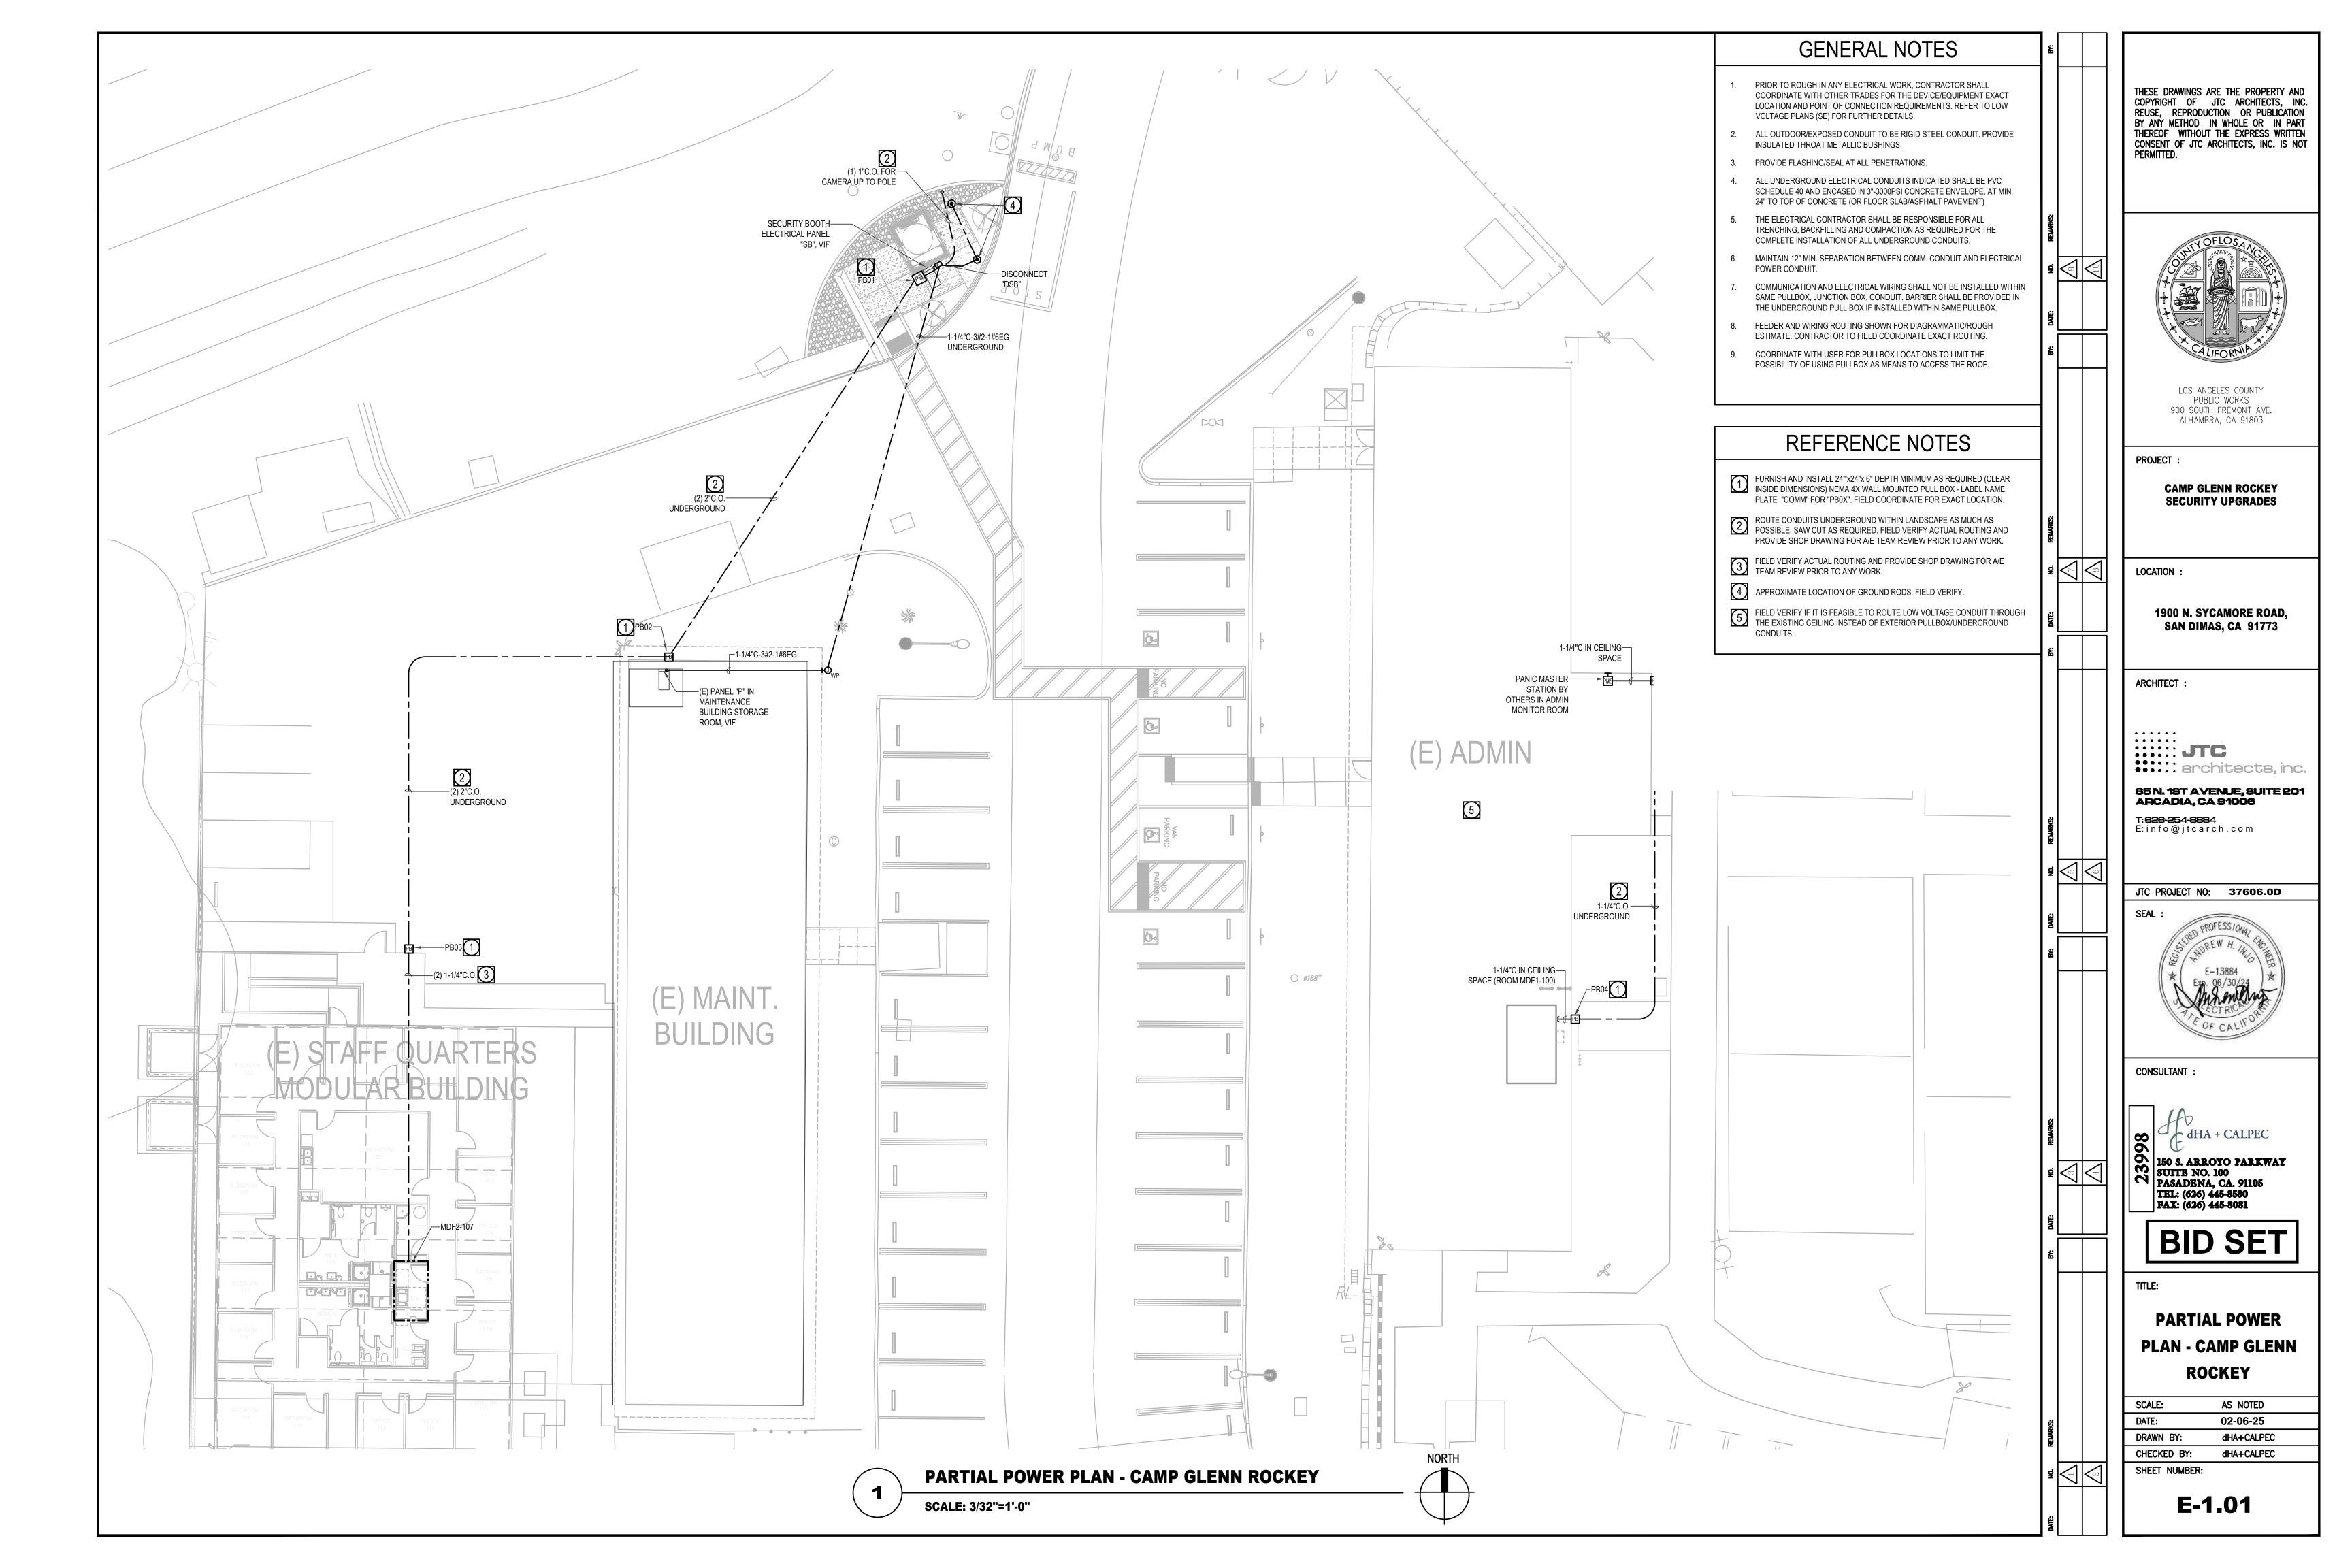
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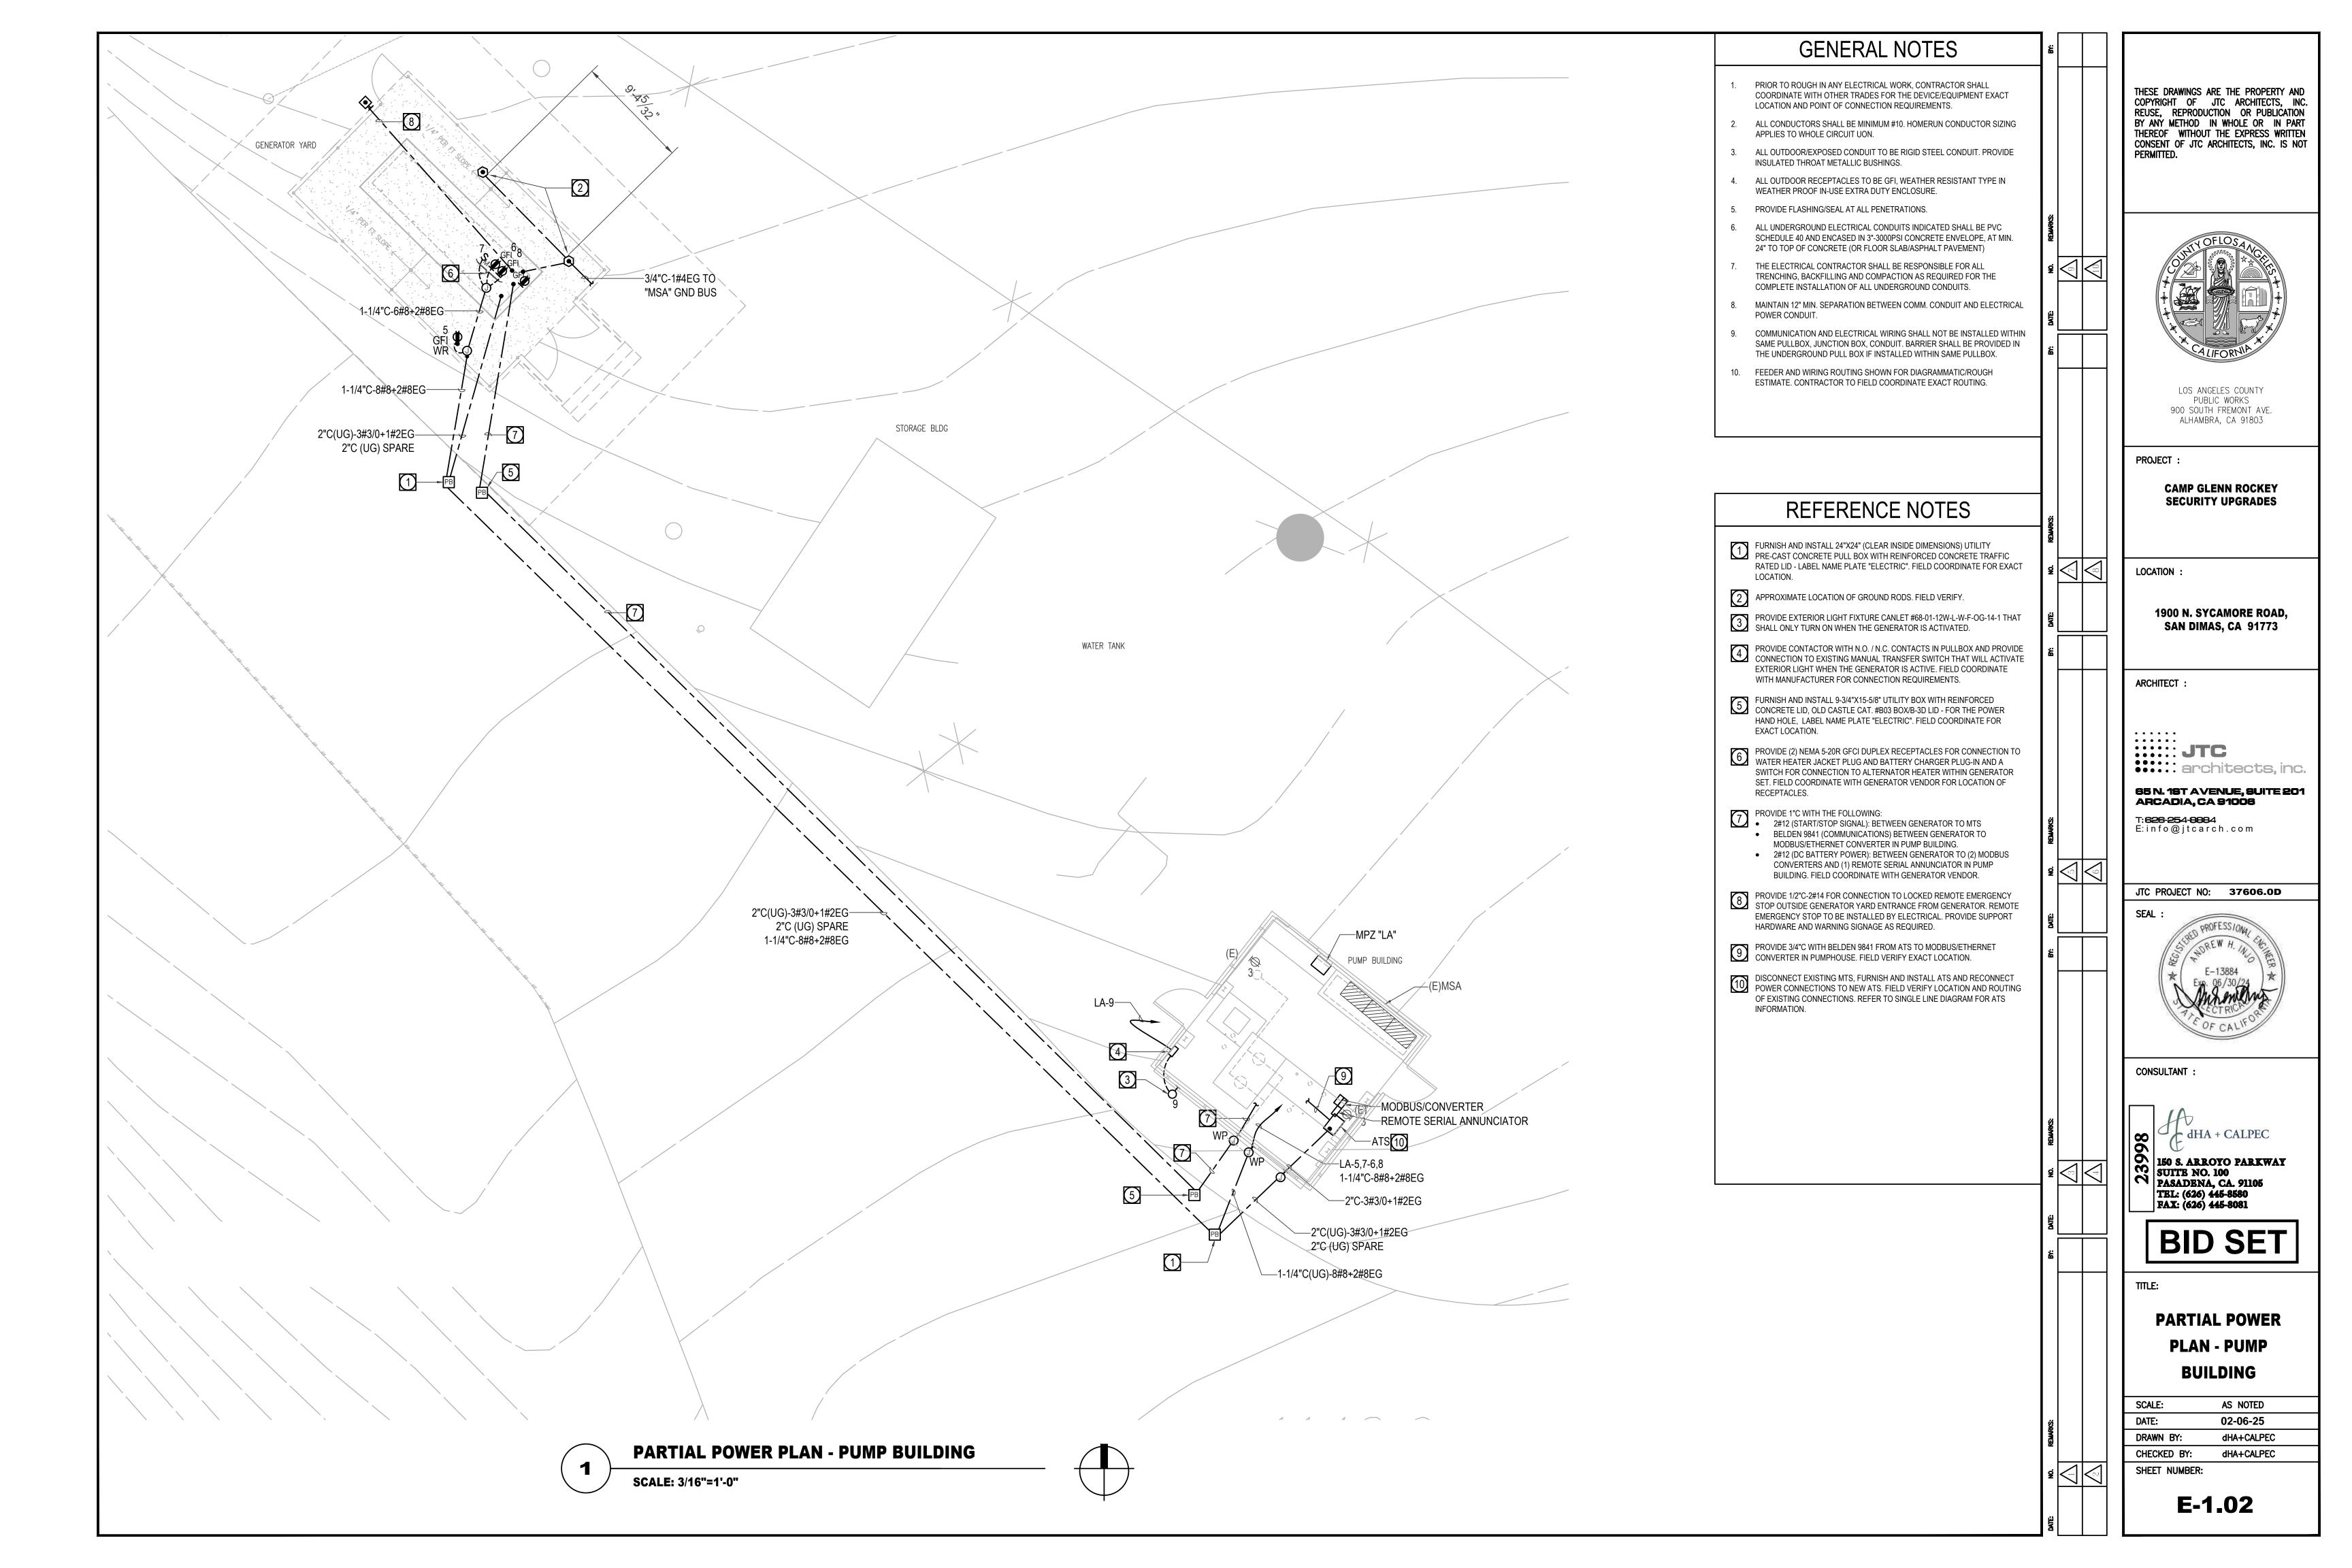
	== ===== NEL : (E)		1) PHASE :		3		WIR		4	MOUNTIN		SURFACE
VOI	LTAGE :	208 / 120	,		MA	AINT			BUILDING			and the special section of the secti
BUS	S AMPERE :	225 AMP	FED FRO	MC		AD	J 75	KVA	XFMR	POLES	:	42
MA	IN C/B :	225 AMP	MAIN TY	PE:			ΑU٦	ГОС	.B.	SPARE (CAP:	(
	= =====	=======================================	= '======	==		==	==	==	=== ===	_======	======	======
				L	R	M	Н				CIRCUIT	
CK				Т	Е	Т	Т	1	CIRCUIT		KVA	
NO		CRIPTION		G	С	R	G	S	BREAKER	Α	В	С
=				==	==	==	==	===	==== ====	======	======	======
	(E) WAREHOUSE			1					20 / 1	1.00		
	(E) C.I. LTS (OFFICE			1					20 / 1	1.00	4.00	1
	(E) MGR OFFICE L			1					20 / 1		1.00	1
	(E) CANOPY LTS (1					20 / 1		1.00	1.00
	(E) UNKNOWN LO			-				4	20 / 1			1.00
	(E) CANOPY LTS ((E) UNKNOWN LO	,						1	20 / 1	0.54		0.18
	(E) UNKNOVVN LO (E) SUB PANEL P-			-				Ä	20 / 1	0.54 4.50		
	(E) SUB PANEL P			-				1	40 / 2	4.50	3.20	-
	(E) FURESTRY PA	NINLL						1	40 / 2	-	4.50	-
	(E) W/ CKT 9			-					/		4.50	3.20
	(E) W/ CKT 8								/	-		4.50
	(E) MGR OFFICE I	HEATER					1		50 / 3	4.50		7.00
	(E) EXISTING LOAI						<u> </u>		20 / 1	1.00		
	(E) W/ CKT 13	_							/	1.00	4.50	1
	(E) REC (EXTERIO	R CONT)							20 / 1	1	0.54	†
	(E) W/ CKT 13								/	1	5.04	4.50
	(E) EXISTING LOAI	D							20 / 1	1		1.00
	(E) HOIST (NOT IN		HOP			1			15 / 3	0.00		1.00
	(E) C.I. A/C REC	,	** 155						20 / 1	1.00		
	(E) W/ CKT 19								/		0.00	1
22	(E) C.I. OFFICE RE	EC							20 / 1	1	1.00	1
23	(E) W/ CKT 19								/	1		0.00
24	(E) SPARE								20 / 1			0.00
	(E) SPARE								20 / 1	0.00		
26	(E) AIR COMPRES	SOR (MAINT. SI	HOP)			1			20 / 3	1.20		
	(E) A/C (MAINT. SI	HOP)				1			20 / 2		1.20	
	(E) W/ CKT 26								/		1.20	
	(E) W/ CKT 27								/			1.20
	(E) W/ CKT 26								/			1.20
	(E) MGF OFF (REC								/ 1	0.00		
	(E) M.O. (REC/COI	/							20 / 1	0.54	6 = :	1
	(E) M.O. (REC/REI	-)							20 / 1		0.54	1
	(E) SPARE								20 / 1		0.00	0.54
	(E) EXISTING LOAD		"	-				4	20 / 1			0.54
	(2) SECURITY BO							1	80 / 2	1 50		0.00
	(E) SUB PANEL P	·]						1	50 / 2	4.50		
	(2) W/ CKT 36 (E) W/ CKT 37								/	0.00	1 50	4
	(E) W/ CKT 3/ (E) SPARE			-					/ 1		4.50 0.00	1
	(E) SPARE (E) SPARE								/ 1	-	0.00	0.00
	(E) SPARE (E) SPARE								20 / 1	-		0.00
	(E) SPARE == =====	====		I	<u></u>	<u></u>	I	<u>-</u> -				
	 NN LOAD =			W.					<va) =<="" td=""><td></td><td>1</td><td>17.32</td></va)>		1	17.32
	IFDR = 176									AMP		

EXISTING PANEL WITH ASSUMED LOADS AS PER PANEL DIRECTORY. CONTRACTOR TO VERIFY AND (1) TRACE ALL EXISTING/UNKNOWN LOADS AND UPDATE PANEL SCHEDULE/DIRECTORY ACCORDINGLY.

(2) PROVIDE NEW CIRCUIT BREAKER AS NOTED.






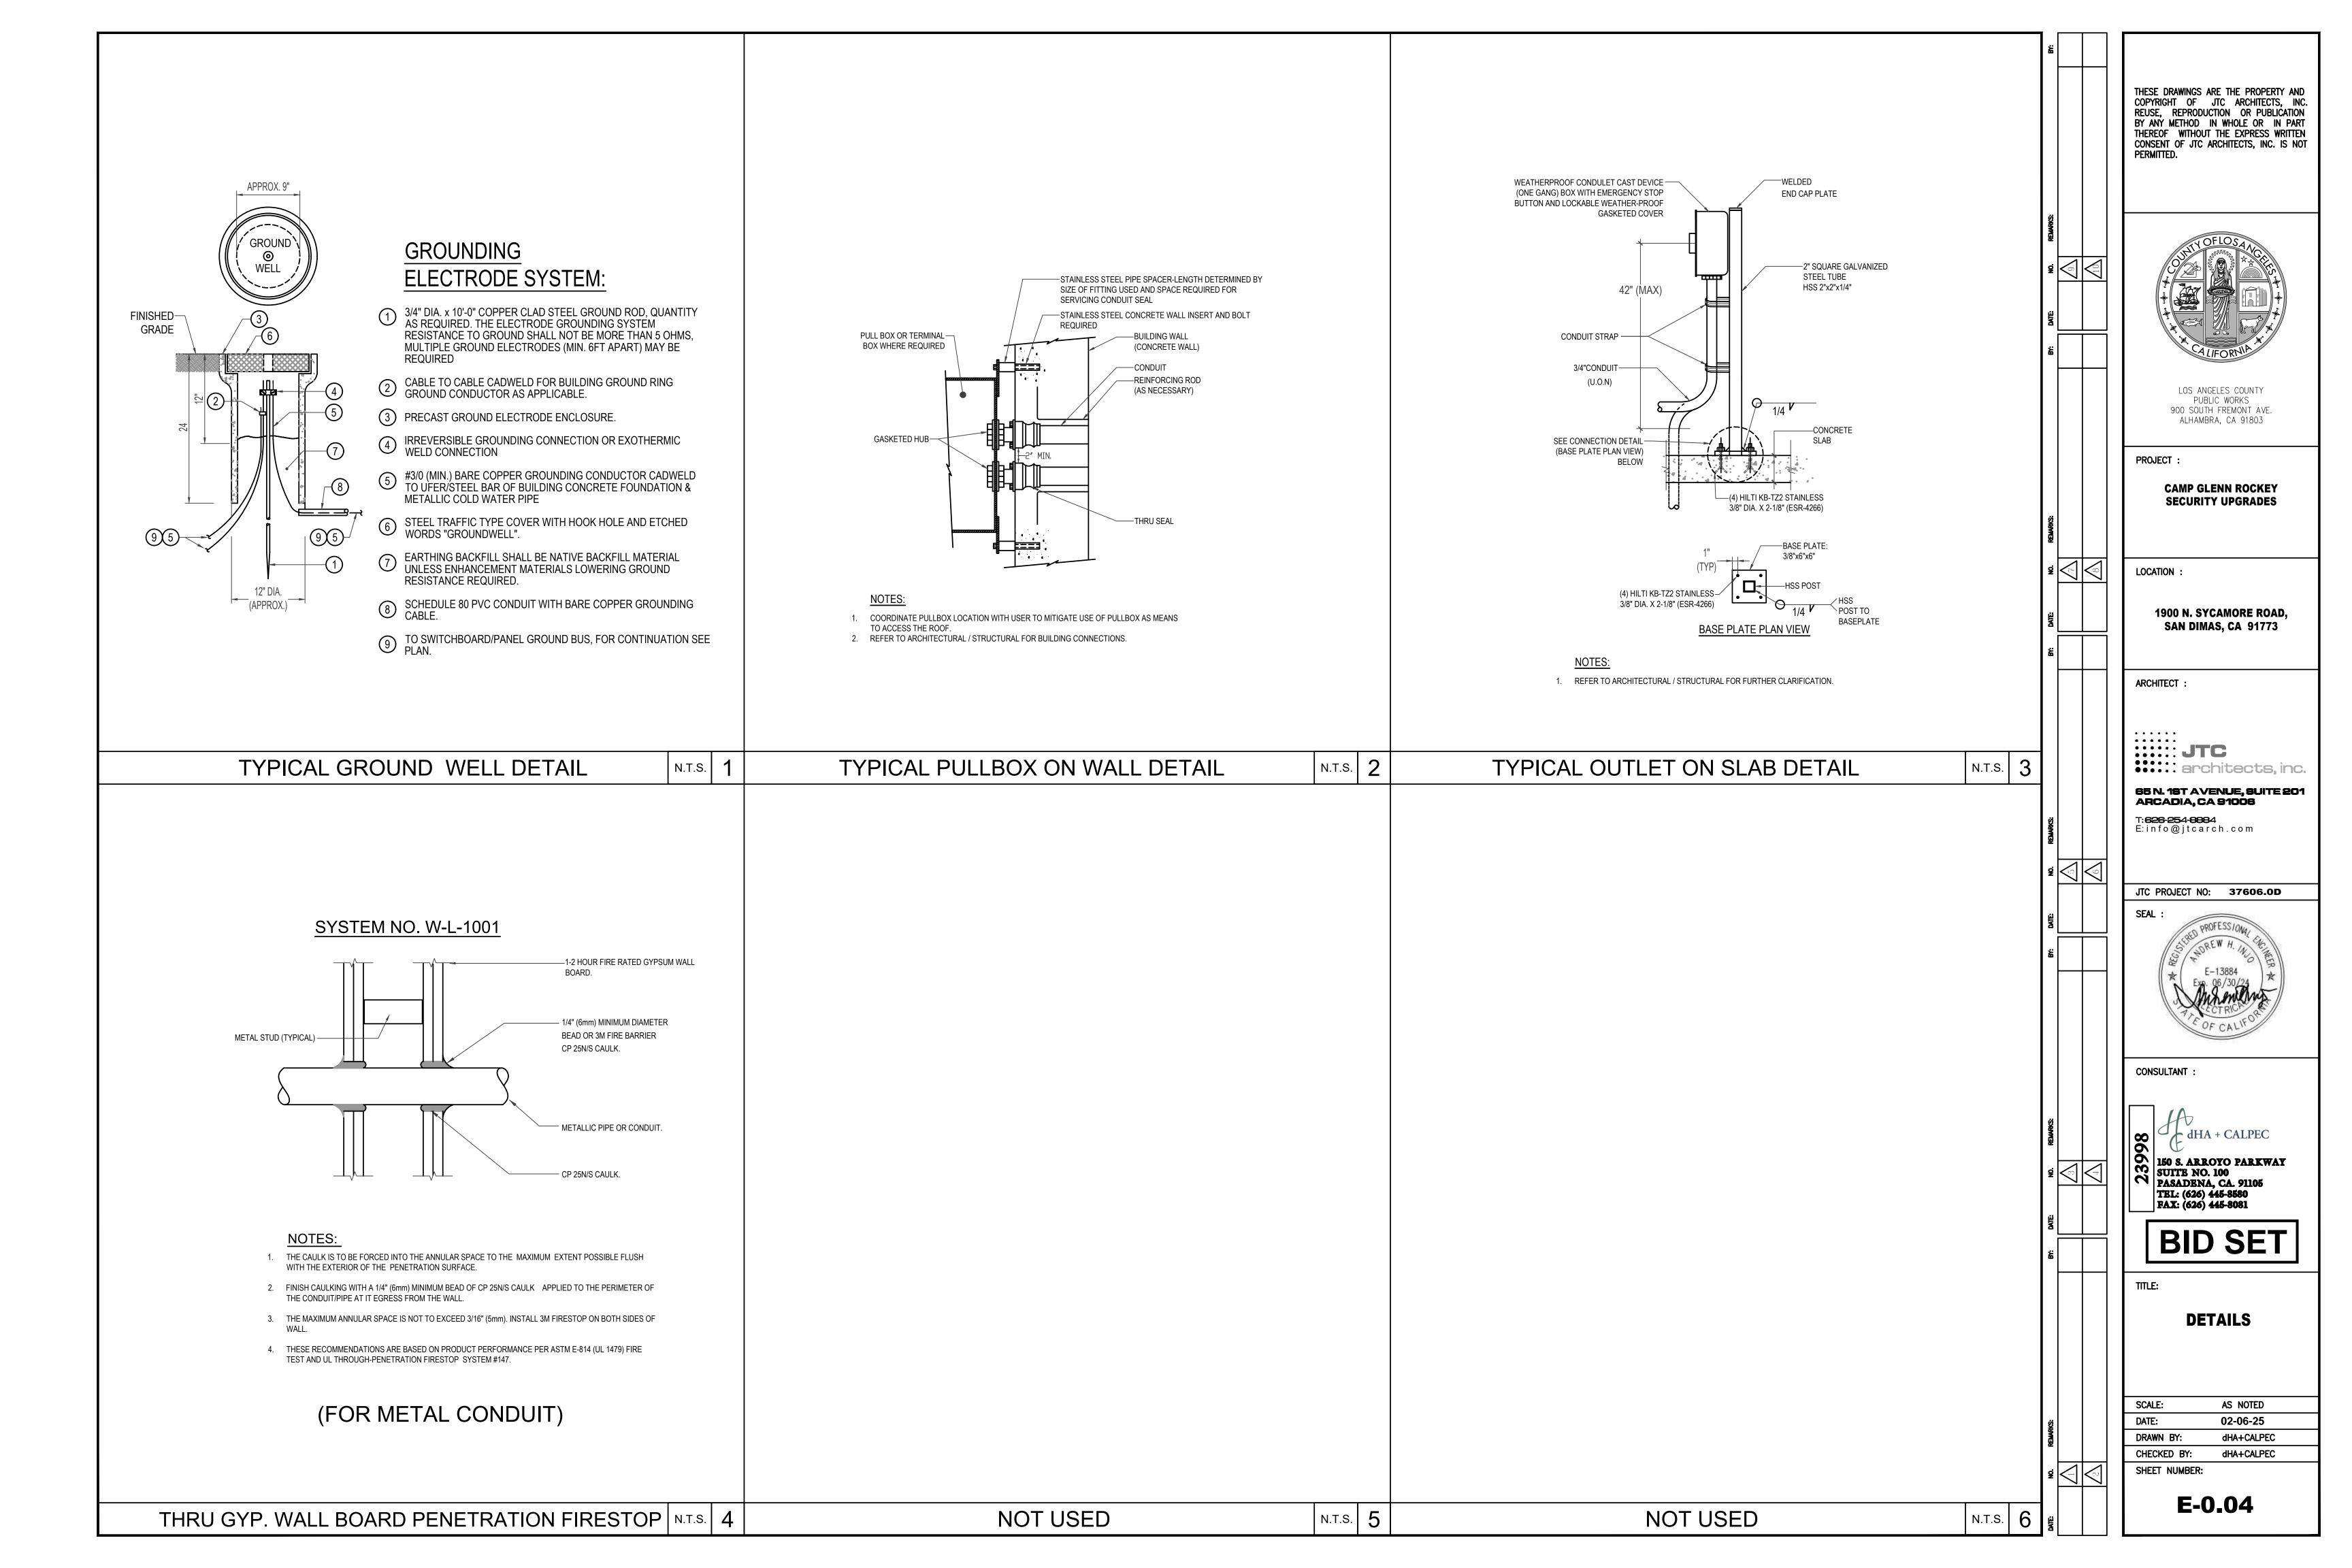

S E C U R I T Y S Y S T E M

CAMP ROCKEY SECURITY UPGRADES

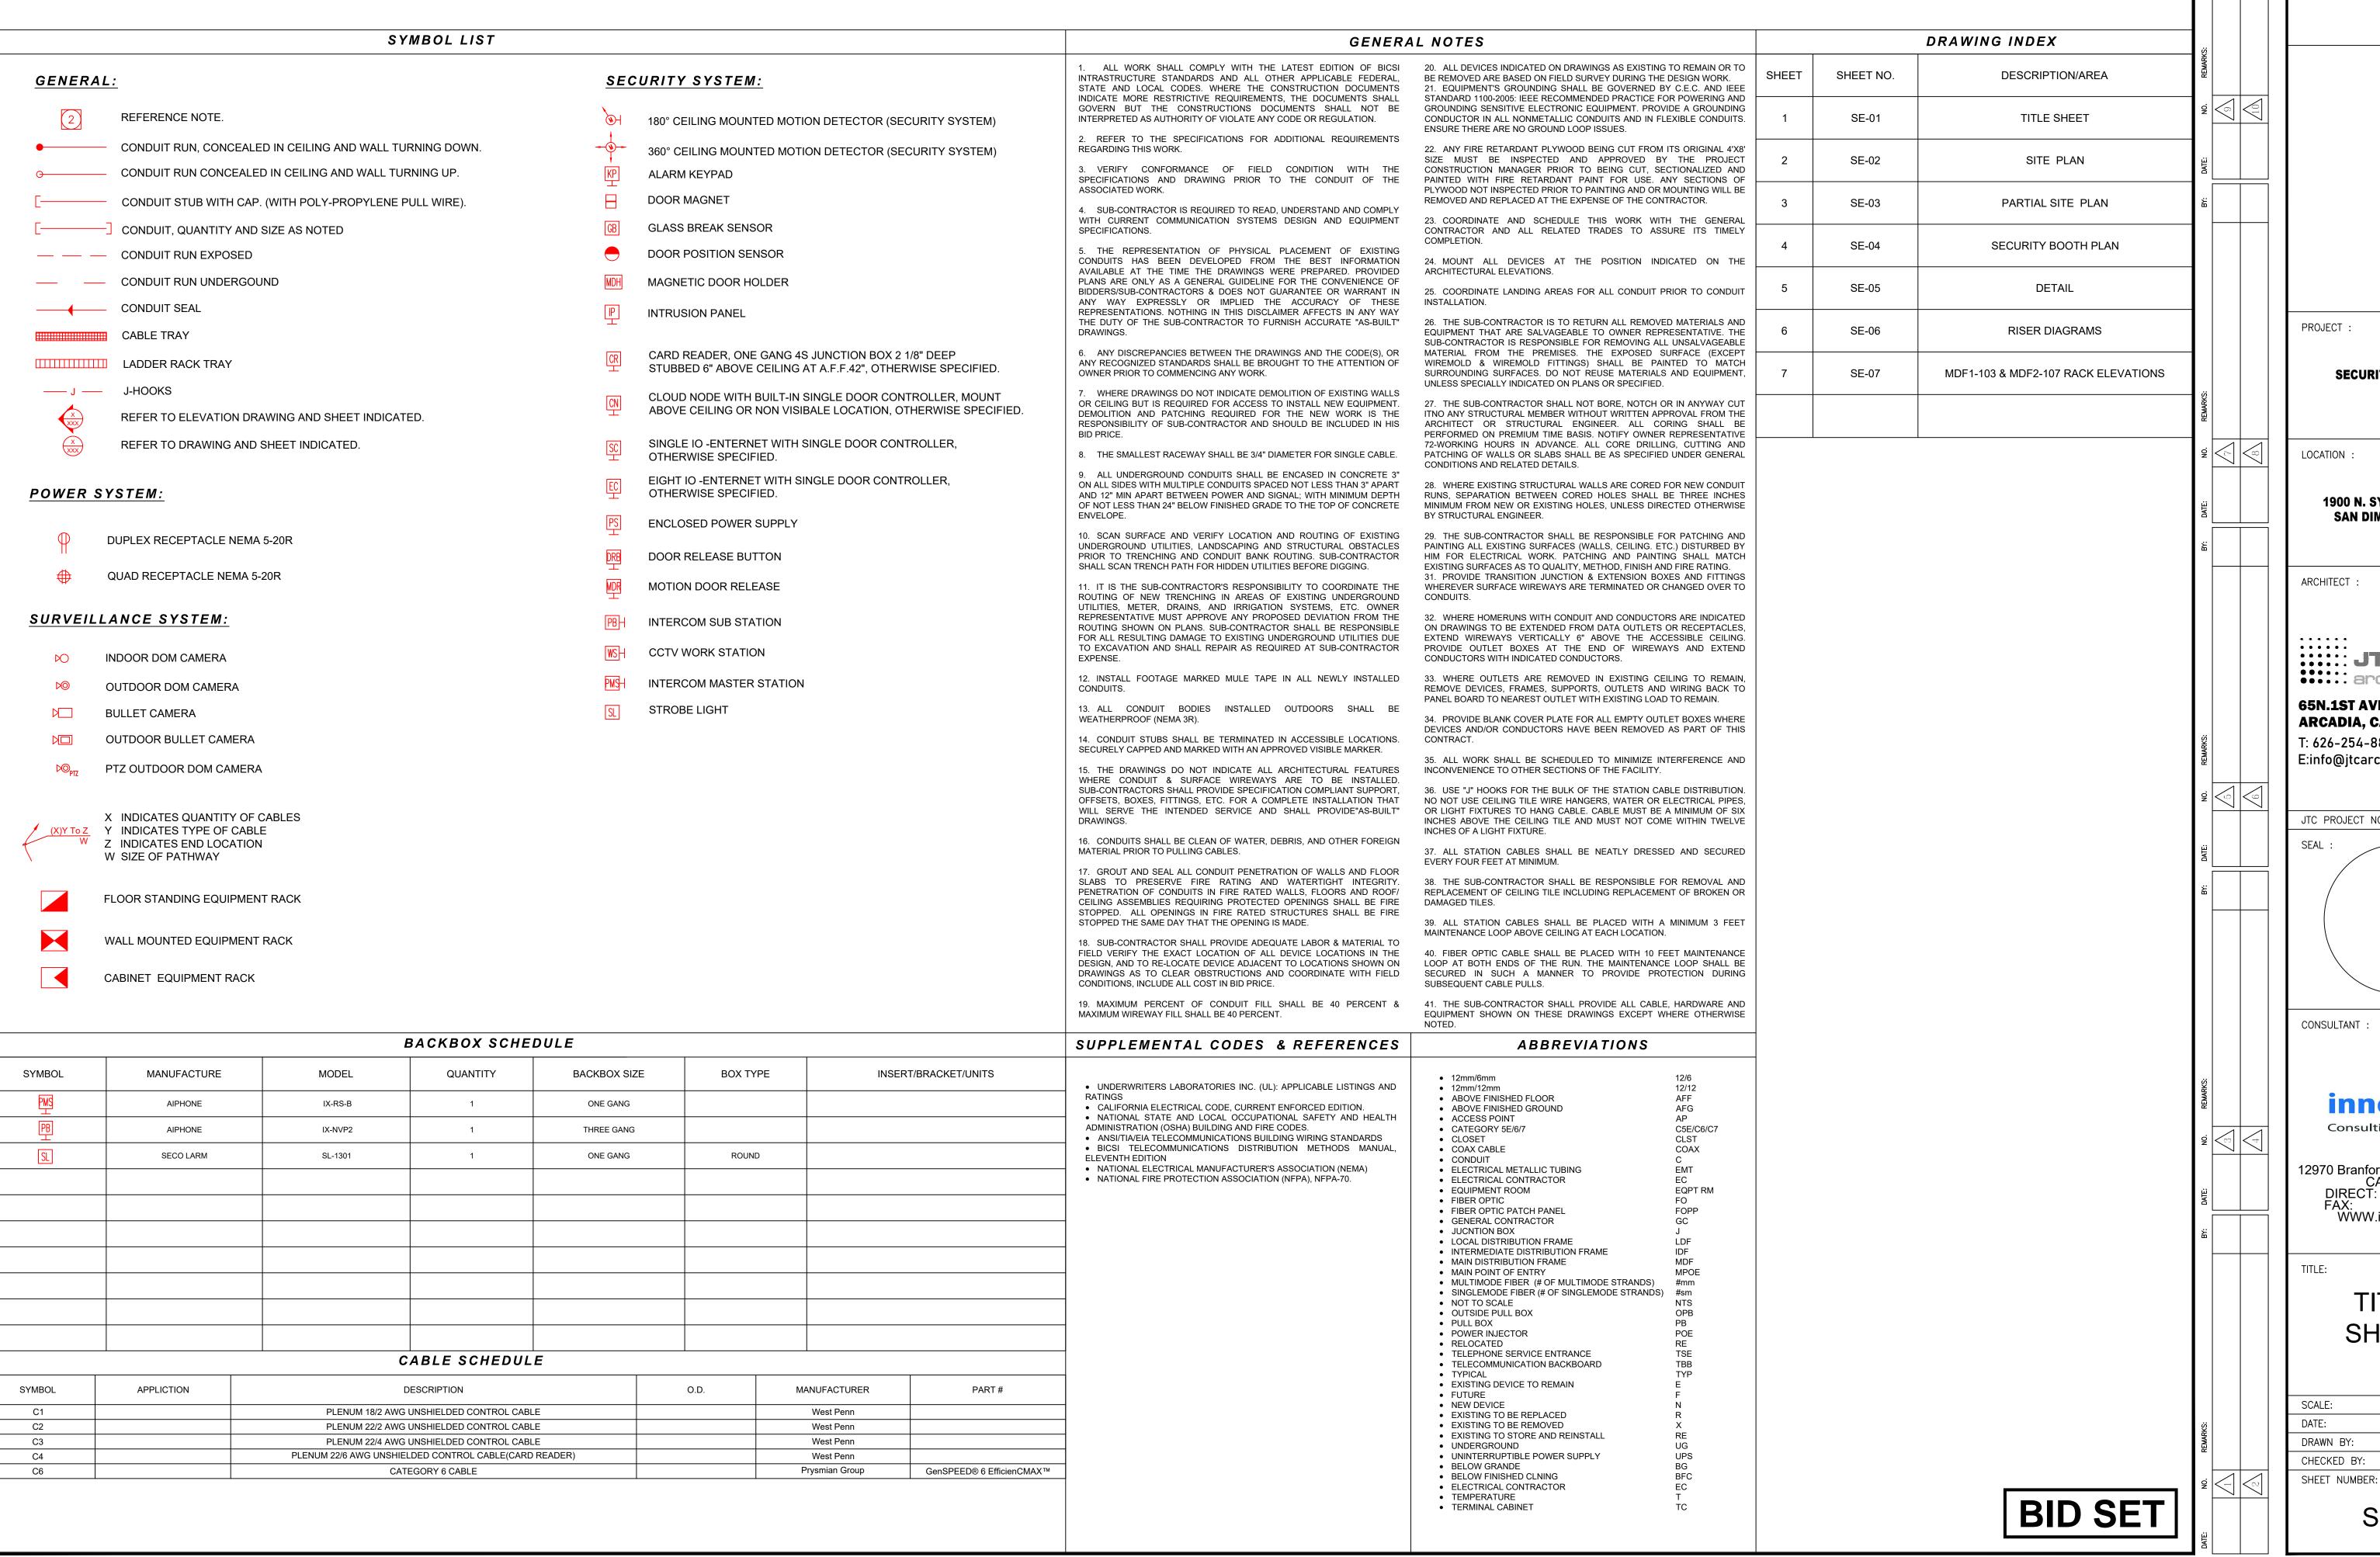

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SECURITY UPGRADES

1900 N. SYCAMORE ROAD, SAN DIMAS, CA 91773

ARCHITECT

:::::JTC architects, inc.

65N.1ST AVENUE, SUITE 201 ARCADIA, CA 91006

T: 626-254-8884 E:info@jtcarch.com


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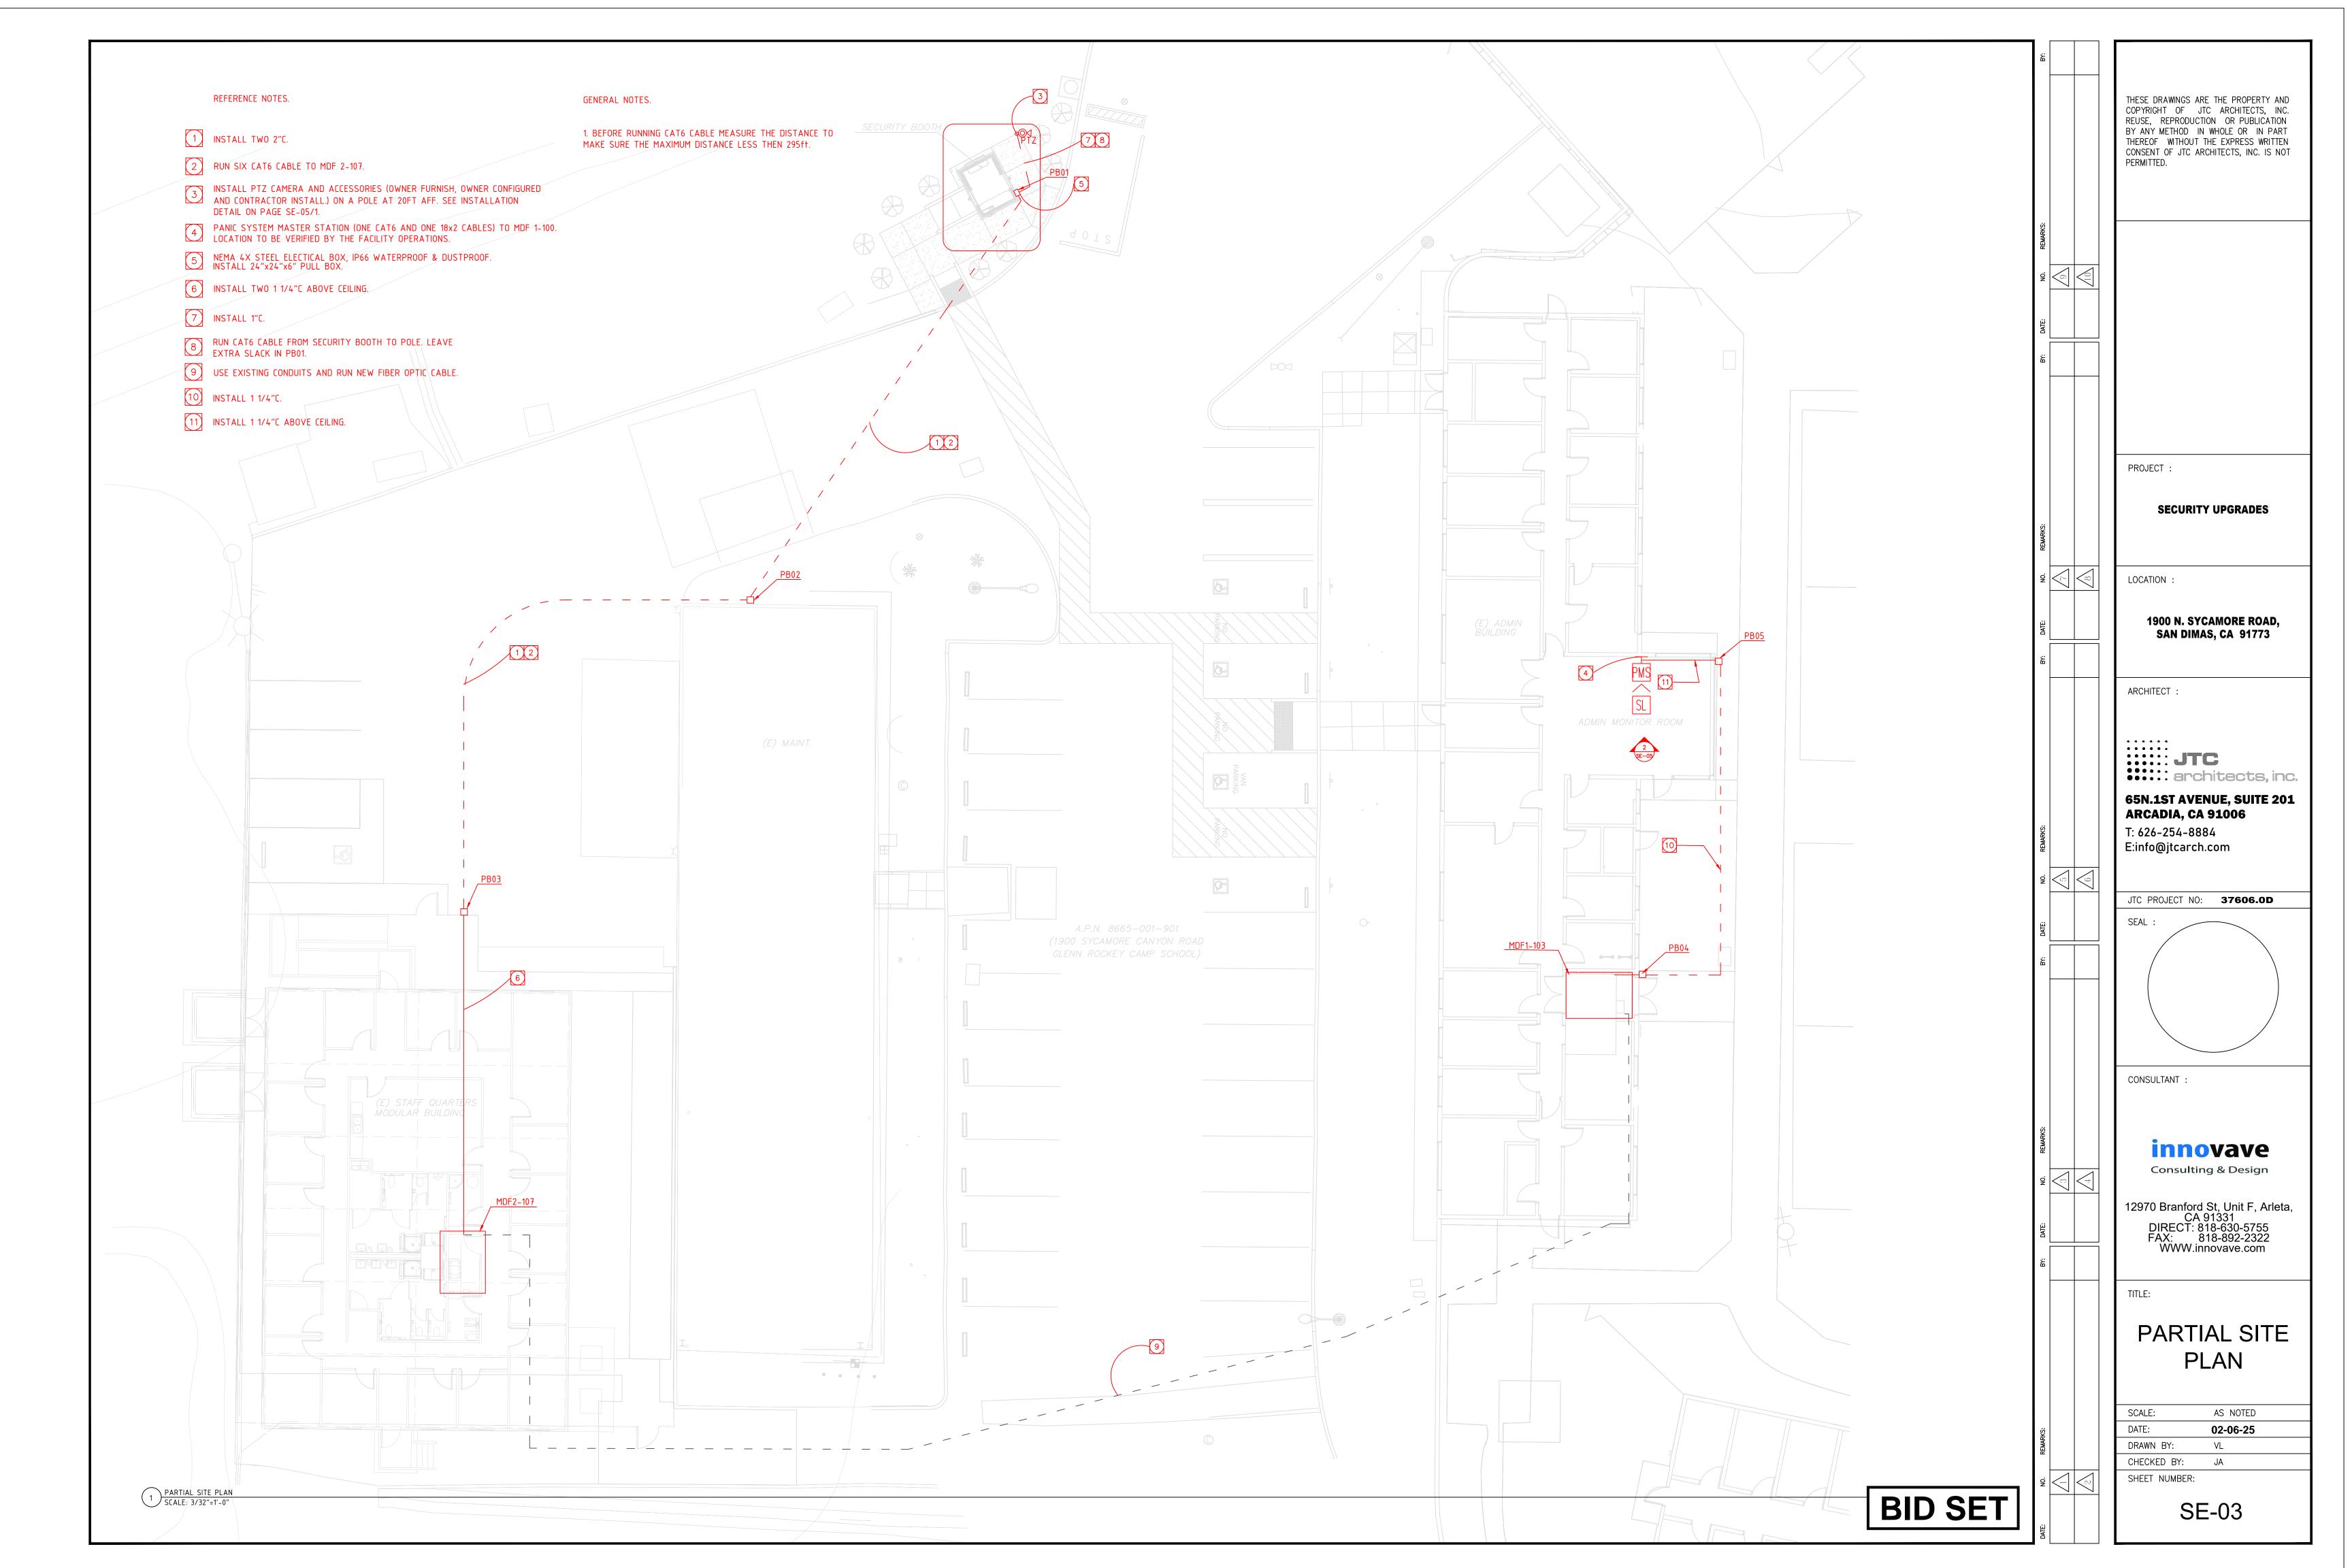
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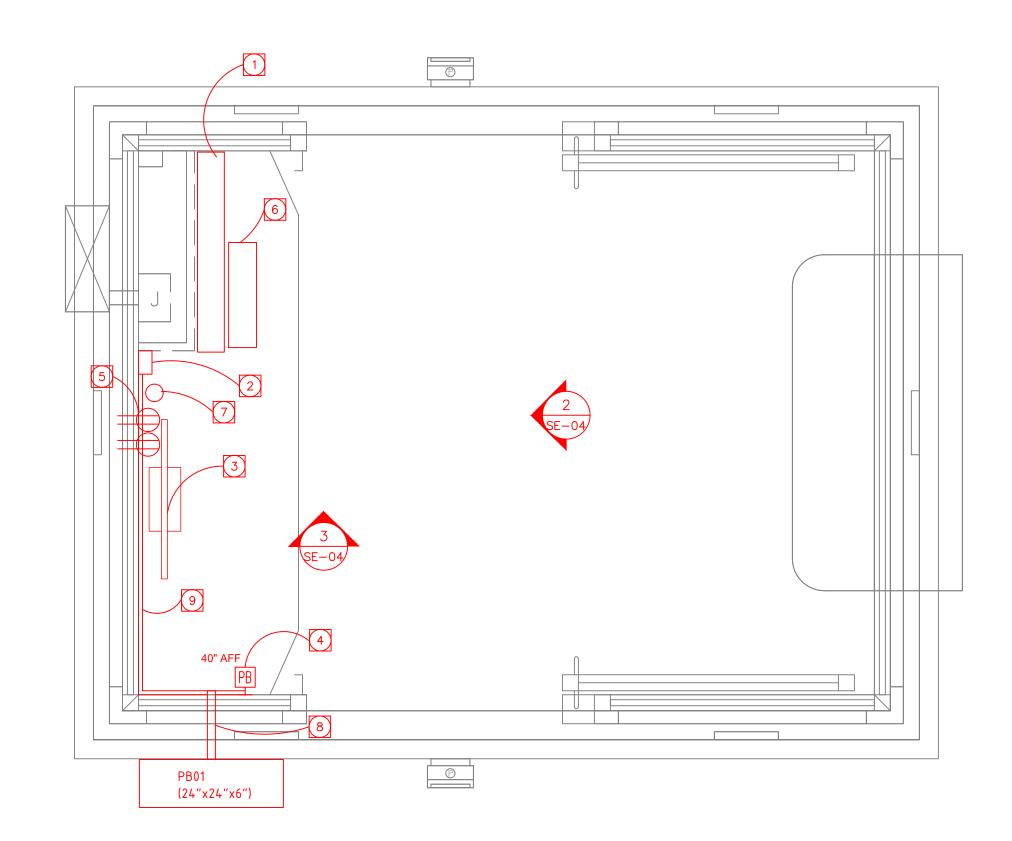
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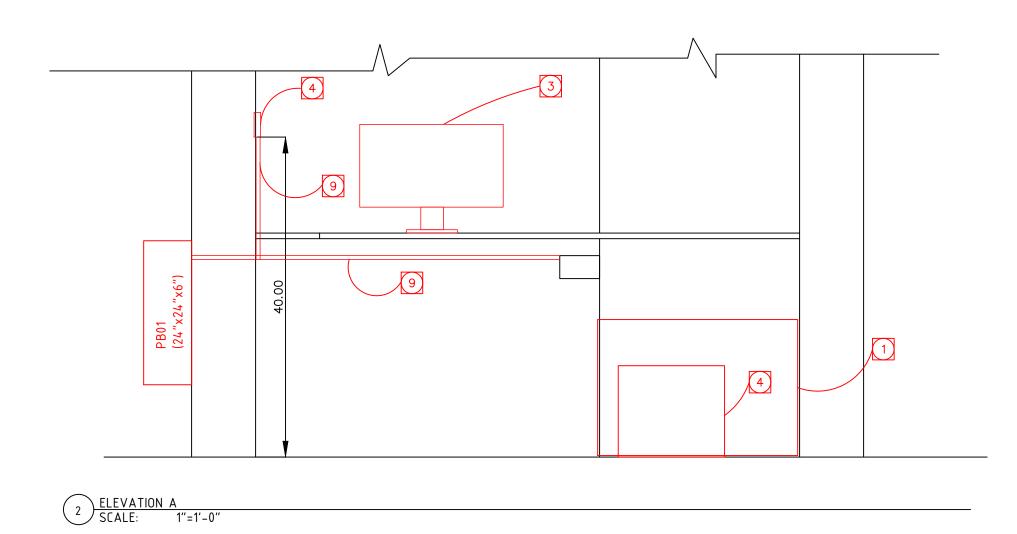
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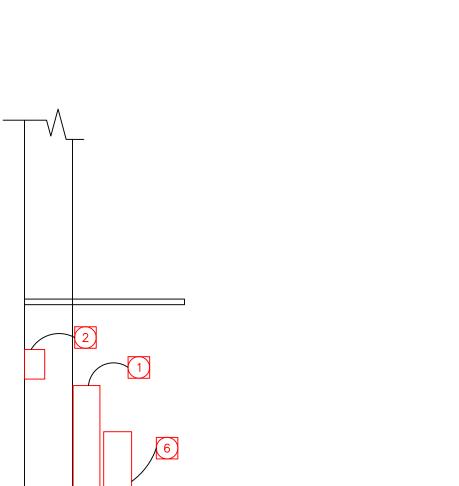
SE-01









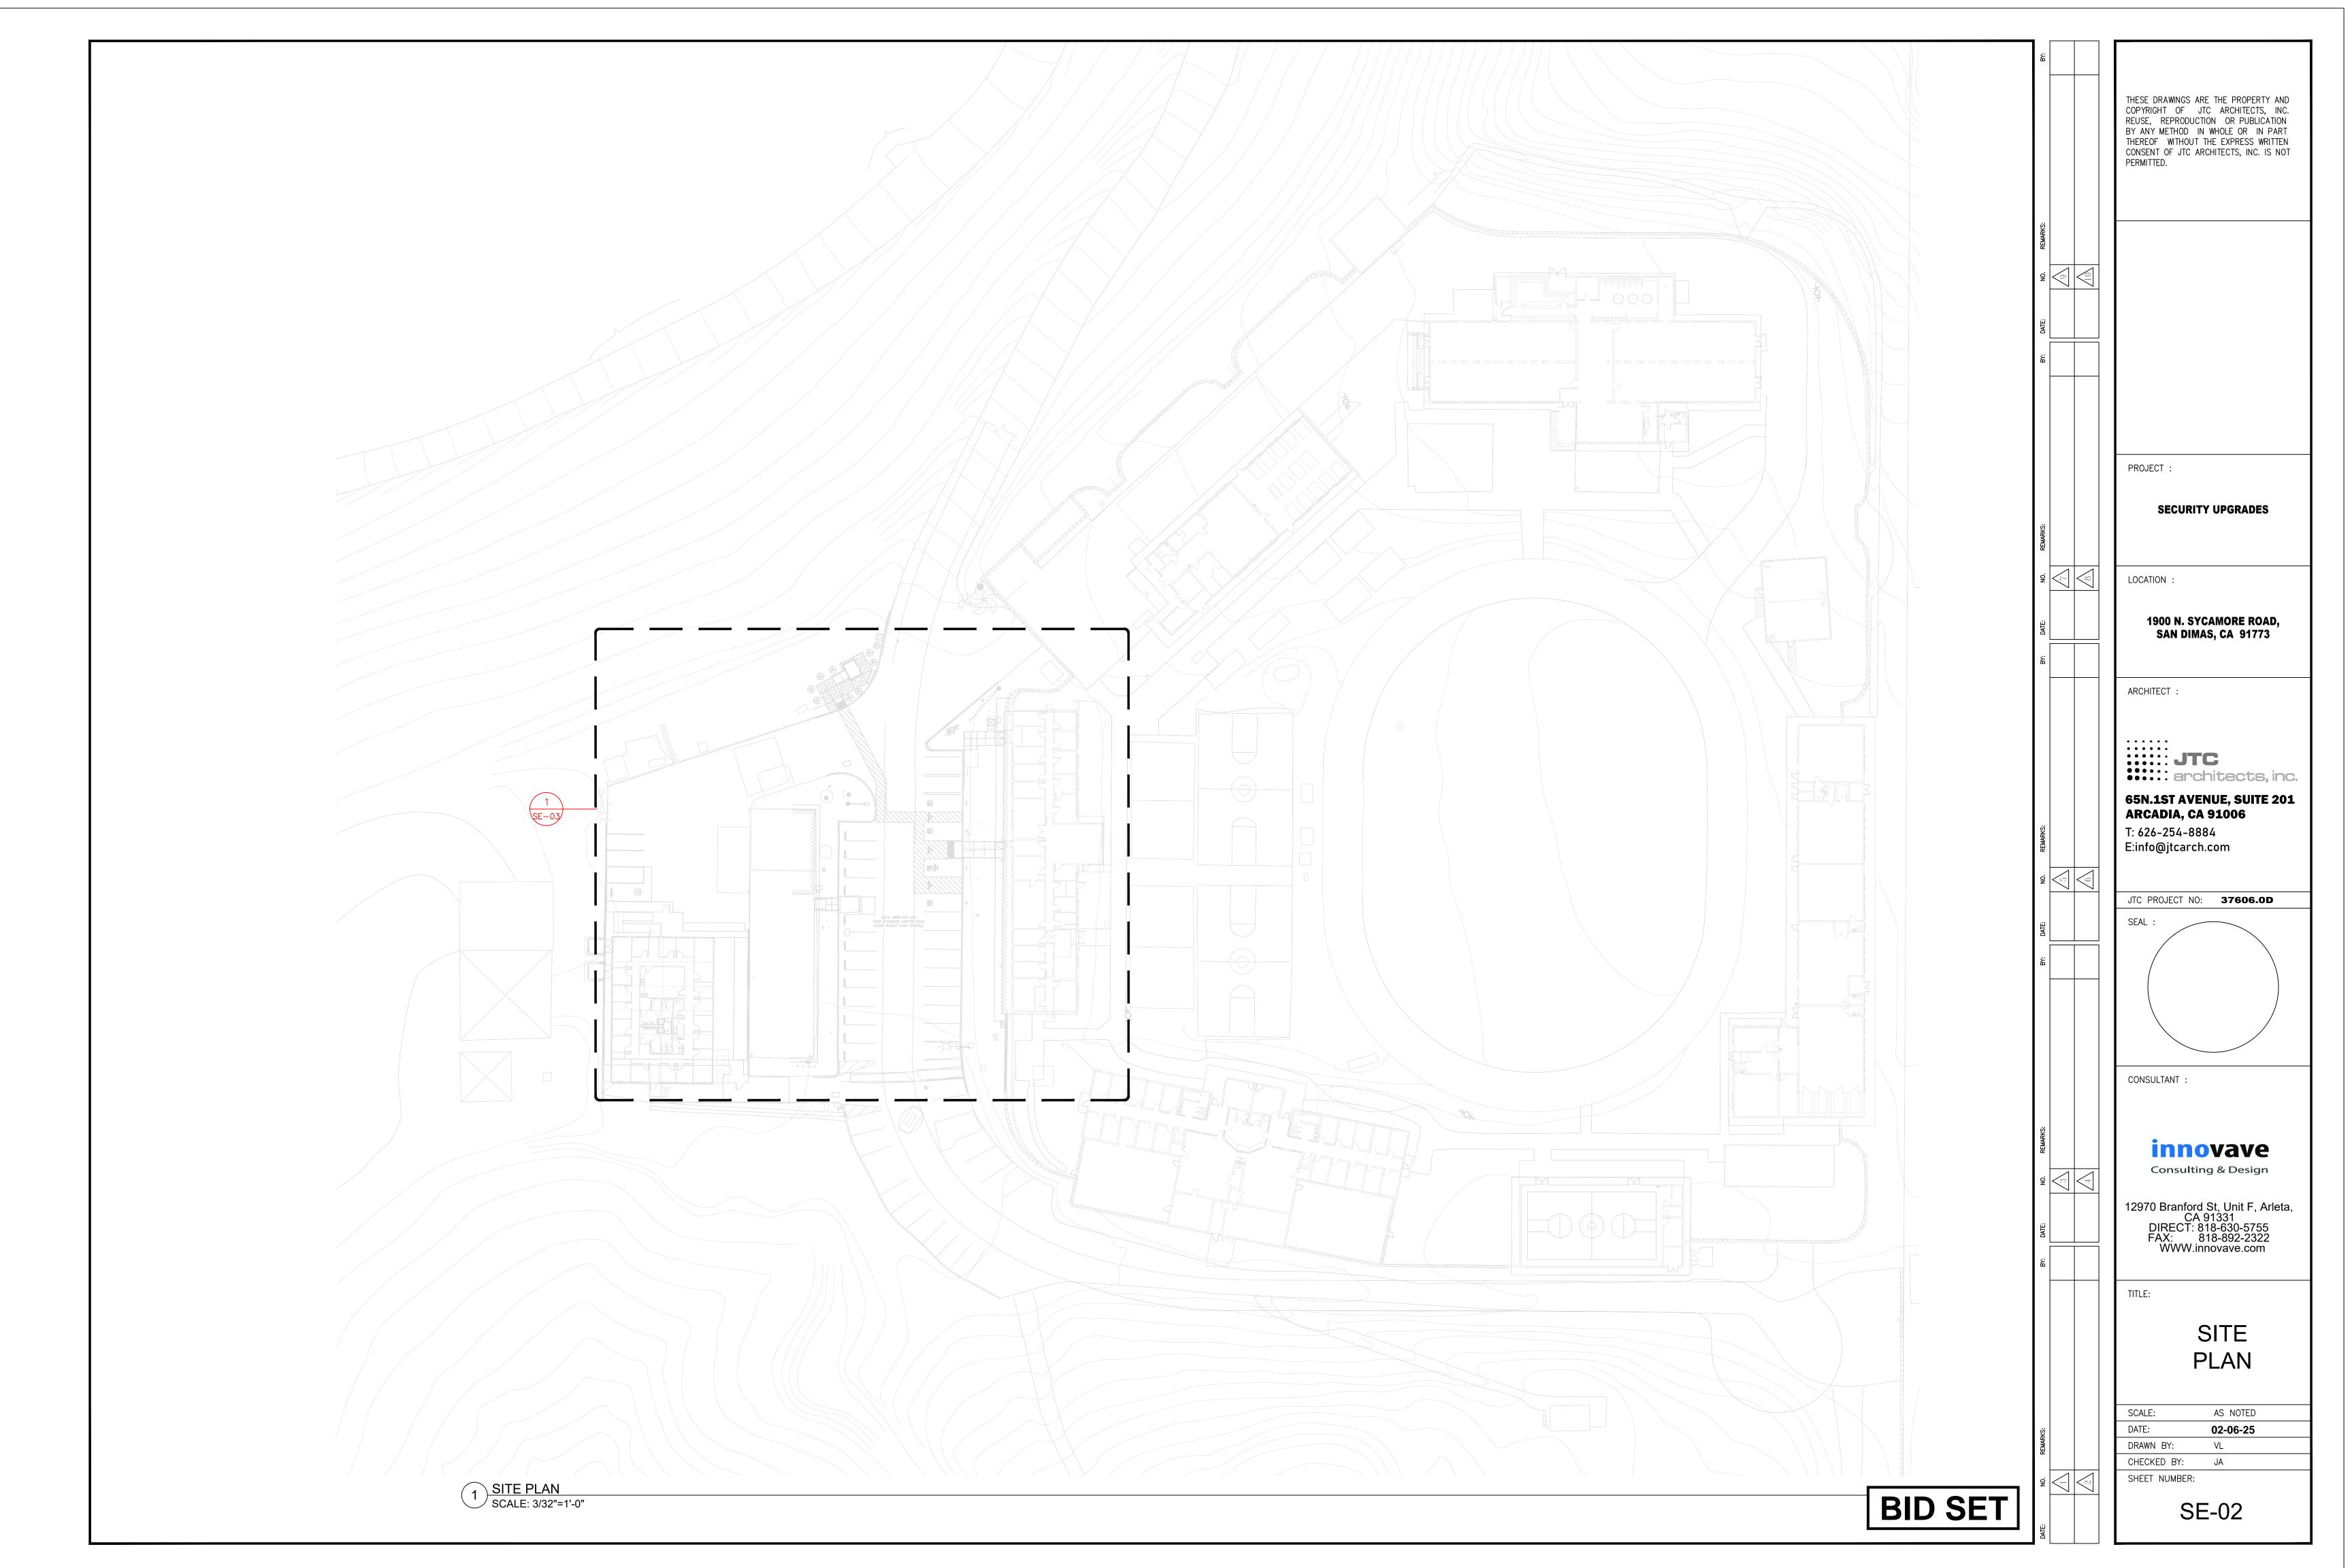

REFERENCE NOTES.

SINGLE PHASE 2kVA UPS.

4 PORT METAL SURFACE RACEWAY DEEP 2 GANG WITH RJ-45 JACKS.

3 SURVEILLANCE MONITOR.

INTERCOM SUB STATION (AIPHONE IX-NVP2). FLUSH MOUNT HORIZONTALLY INTO A 3-GANG MASONRY TYPE BOX (RACO MODEL 692 OR EQUIVALENT).

5 EXISTING 20AMP DUPLEX RECEPTACLES.

6 TYPICAL CCTV CLIENT PC.

7 PASS THROUGH GROMMENT PLATE.

8 PENETRATION WITH 1 1/4" CONDUIT STUB-OUT.

9 1 1/4" PLASTIC SURFACE MOUNT RACEWAY.

3 ELEVATION B SCALE: 1"=1'-0"

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PROJECT :

SECURITY UPGRADES

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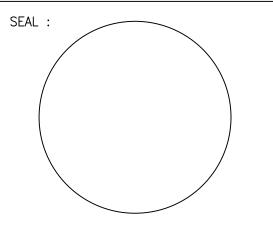
ARCHITECT :

JTC architects, inc.

65N.1ST AVENUE, SUITE 201 ARCADIA, CA 91006

T: 626-254-8884 E:info@jtcarch.com

JTC PROJECT NO: **37606.0D**



CONSULTANT

innovave Consulting & Design


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SECURITIES **BOOTH PLAN**


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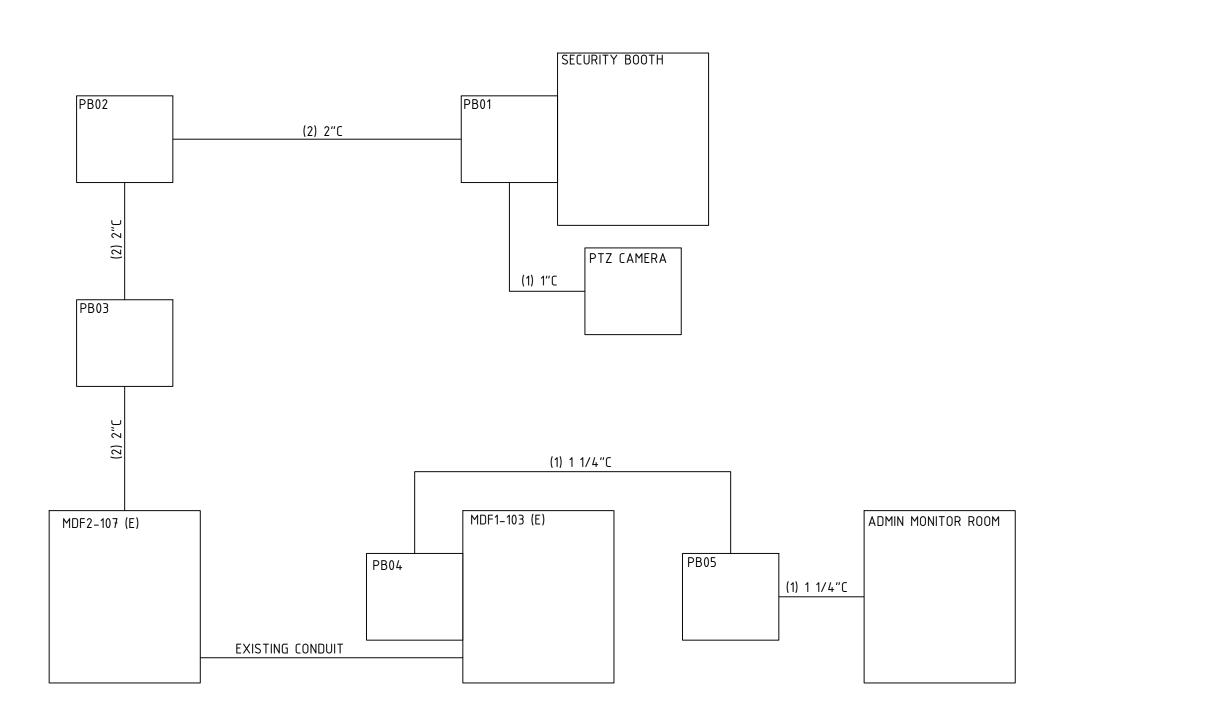
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1 CABLE RISER DIAGRAM SCALE: NTS



2 CONDUITS RISER DIAGRAM SCALE: NTS

1900 N. SYCAMORE ROAD, SAN DIMAS, CA 91773 ARCHITECT : JTC architects, inc. 65N.1ST AVENUE, SUITE 201 ARCADIA, CA 91006 T: 626-254-8884 E:info@jtcarch.com JTC PROJECT NO: **37606.0D** CONSULTANT innovave Consulting & Design 12970 Branford St, Unit F, Arleta, CA 91331 DIRECT: 818-630-5755 FAX: 818-892-2322 WWW.innovave.com TITLE: RISER DIAGRAMS AS NOTED DATE: 02-06-25 DRAWN BY: CHECKED BY: SHEET NUMBER: BID SET SE-06
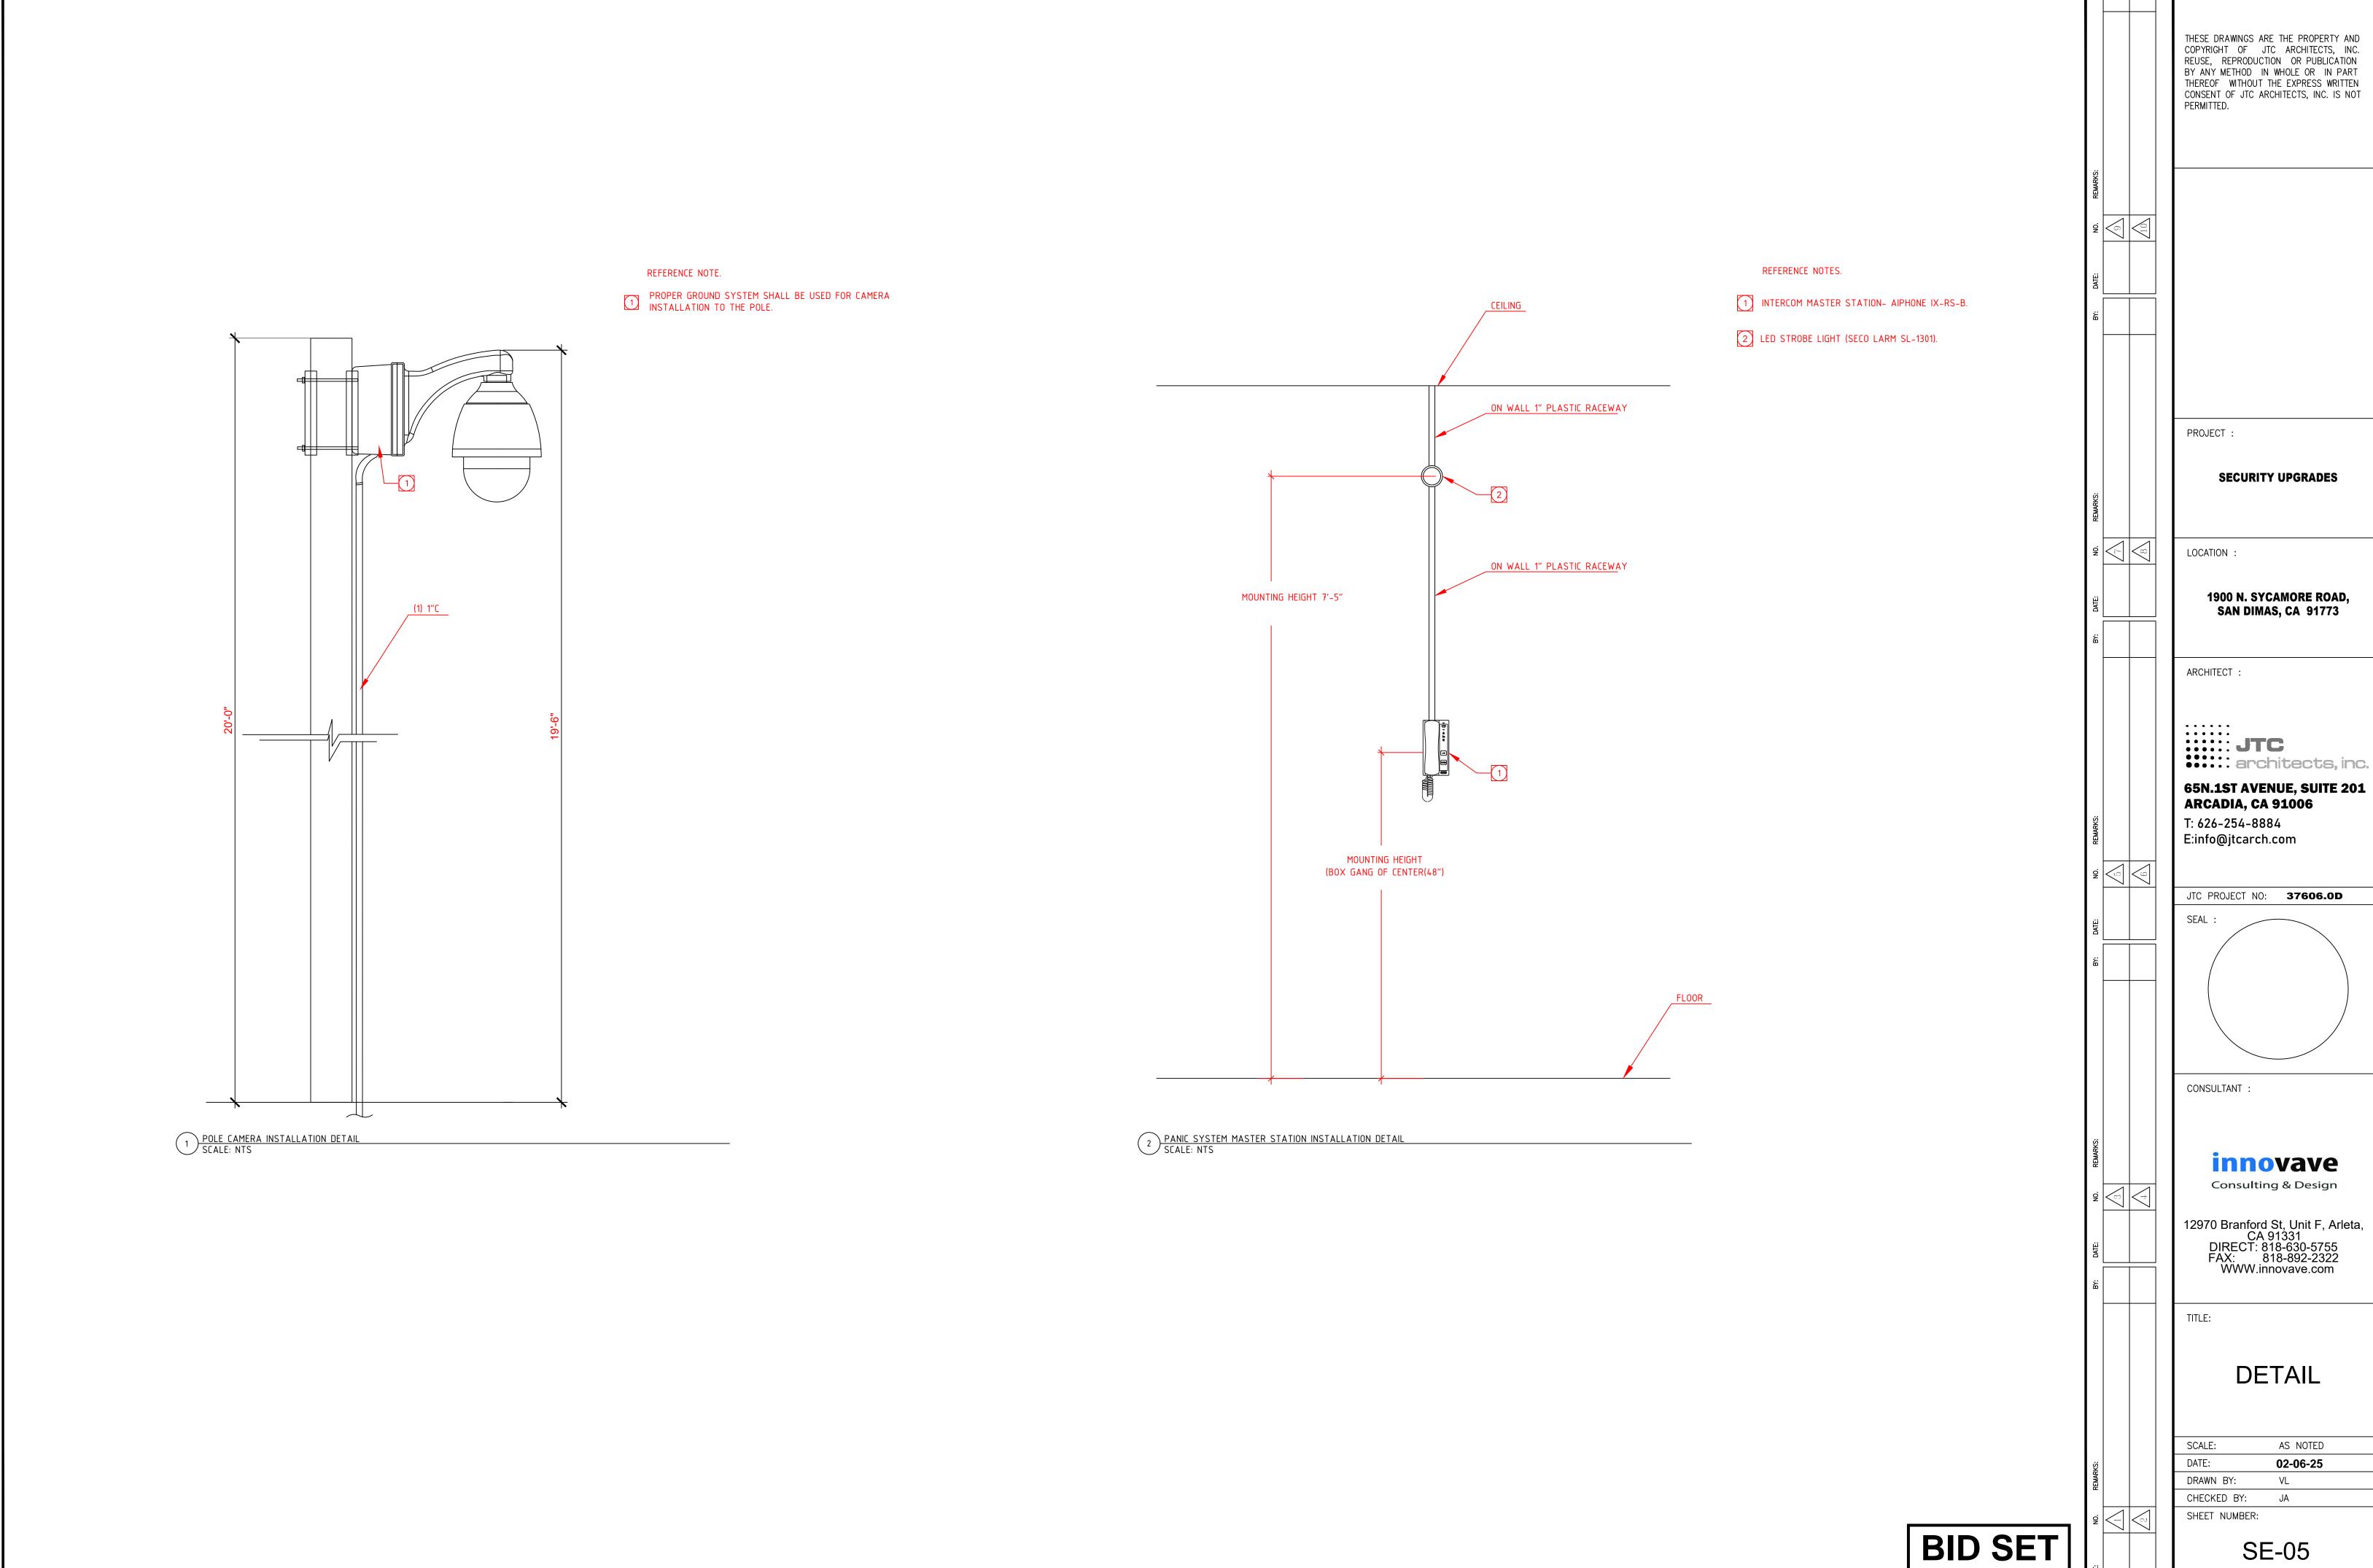
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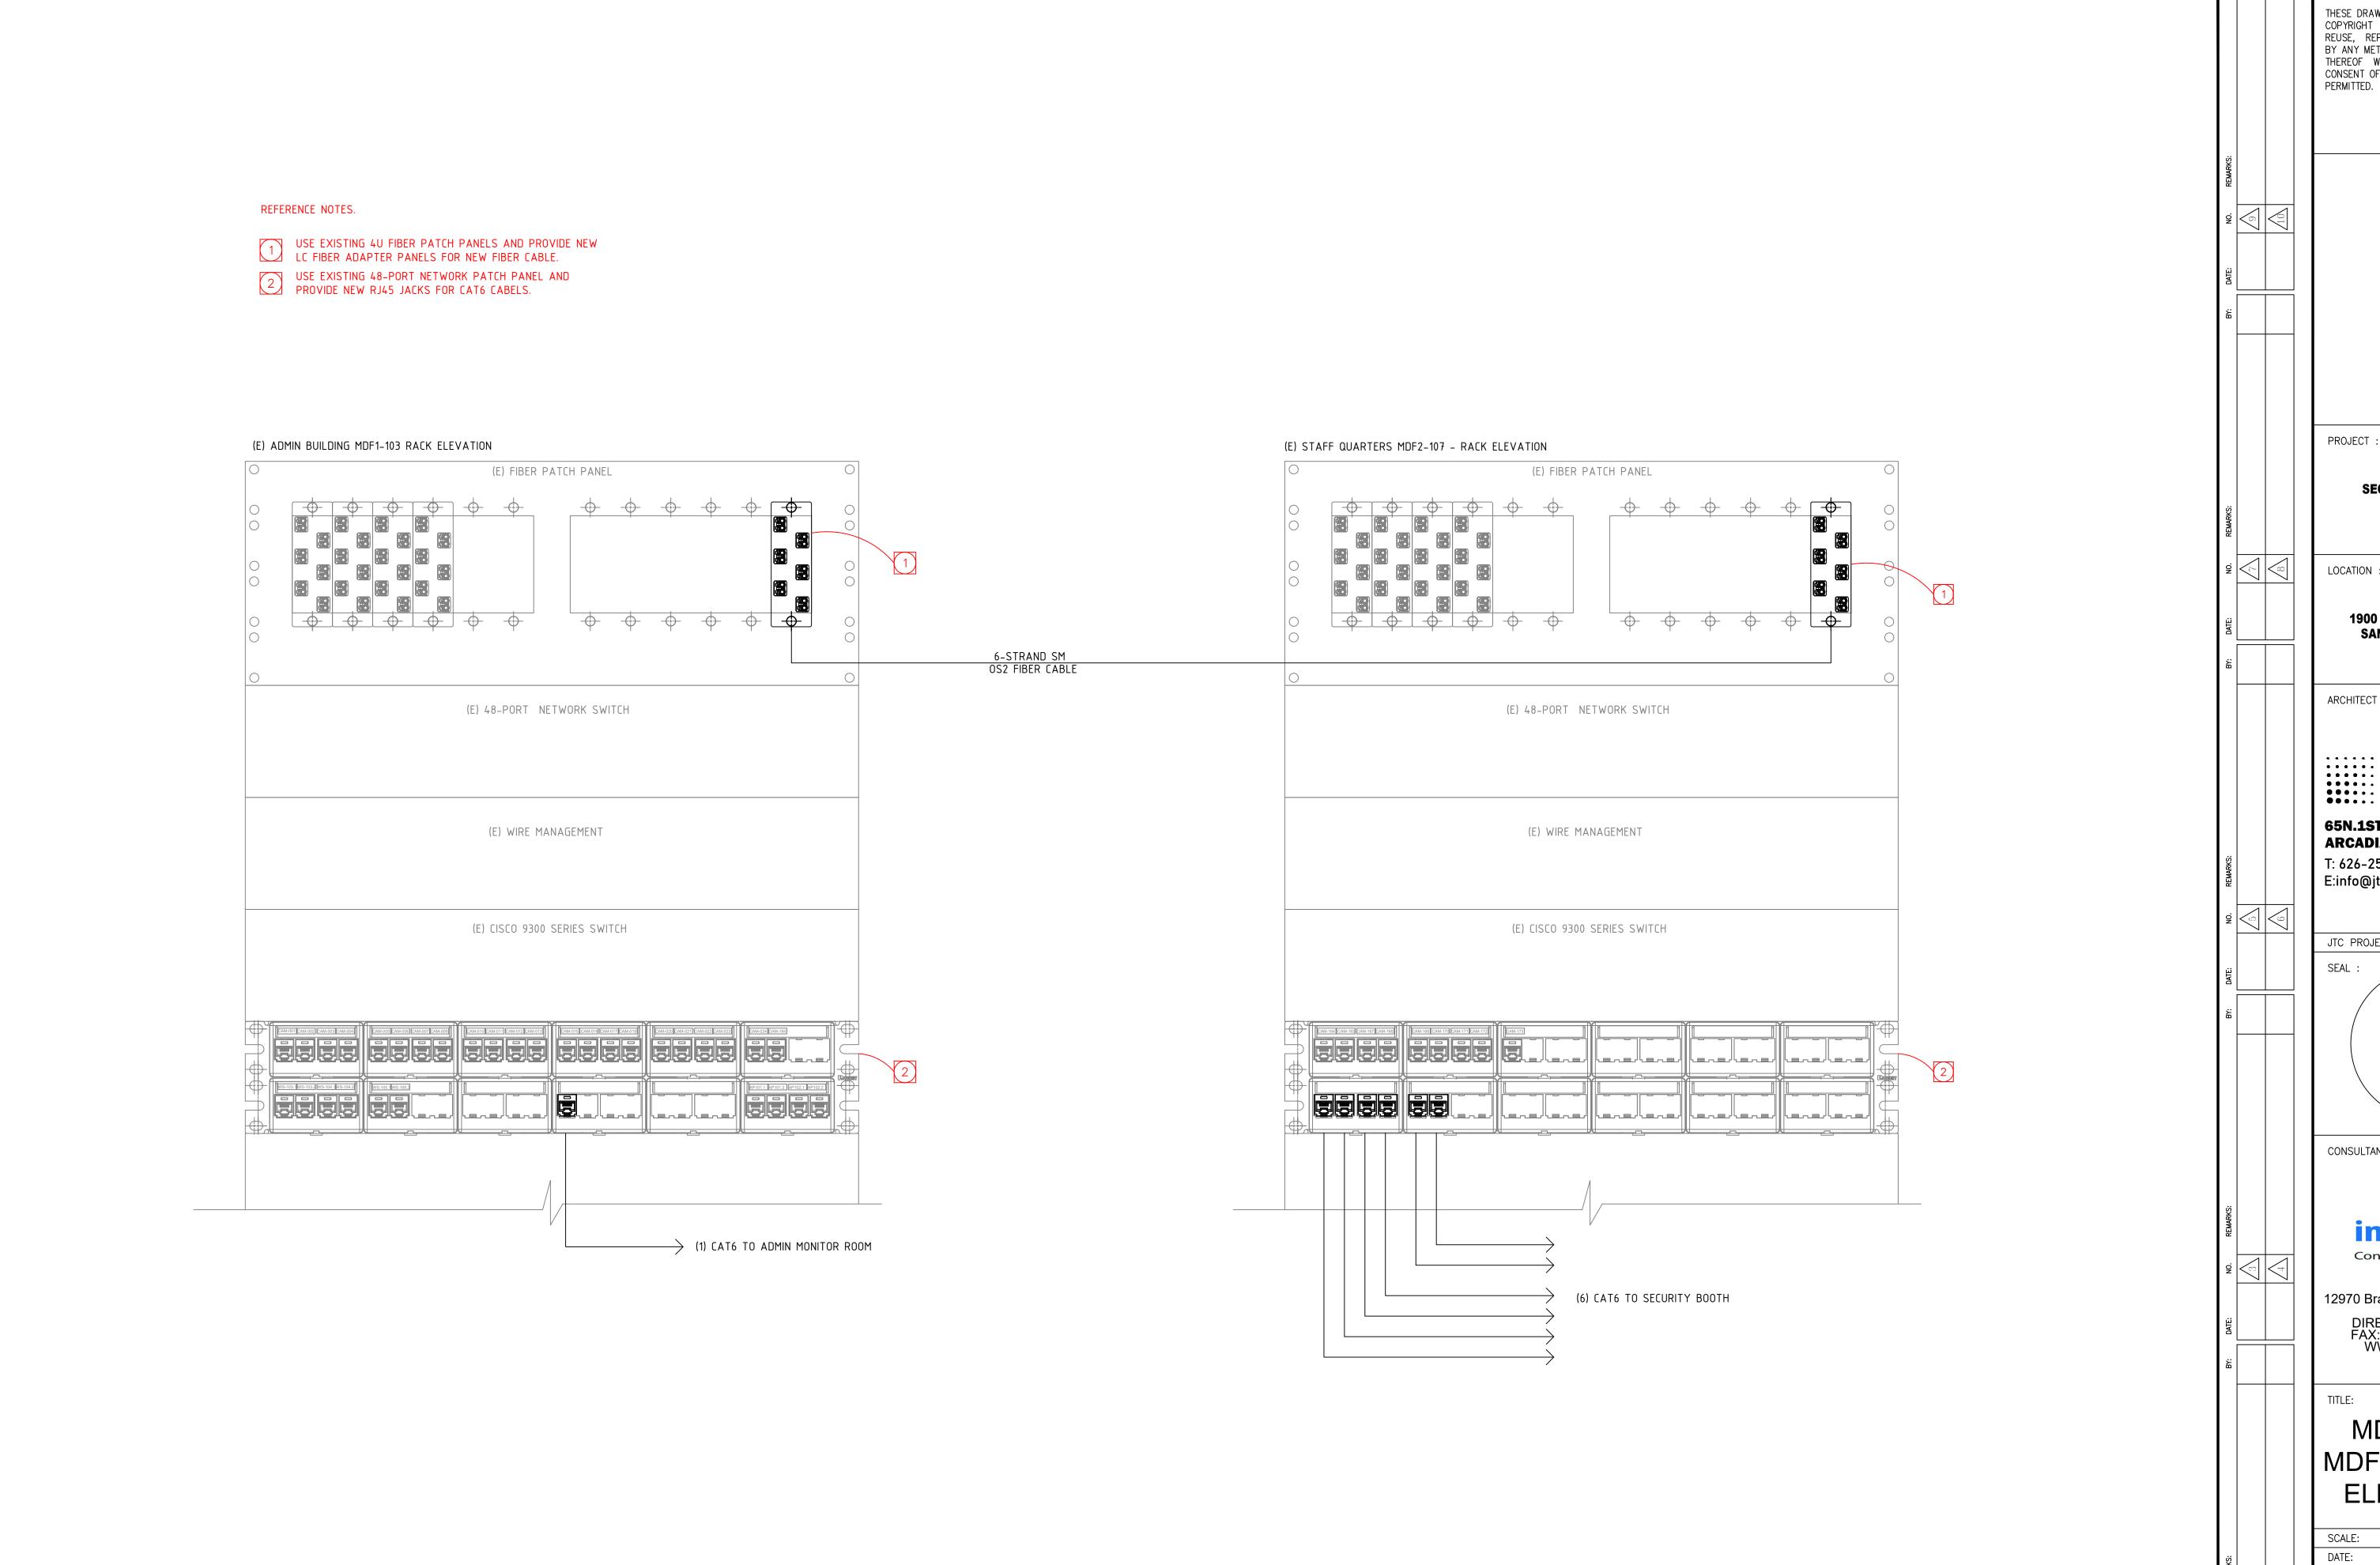
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PROJECT :

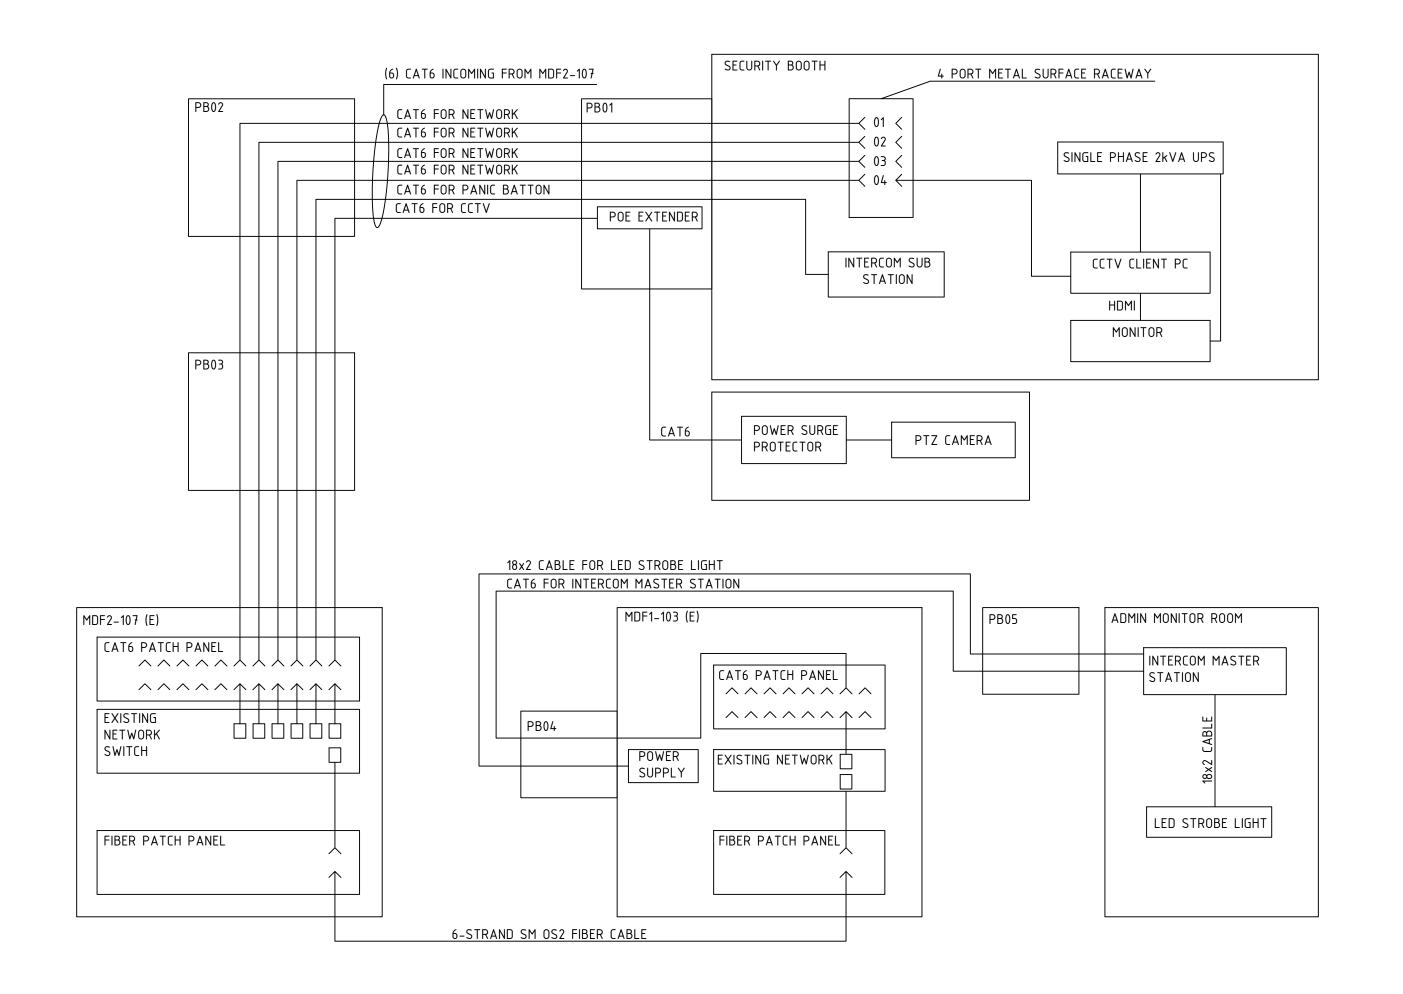LOCATION:

SECURITY UPGRADES



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LOCATION:

1900 N. SYCAMORE ROAD, SAN DIMAS, CA 91773

ARCHITECT :

JTC architects, inc.

65N.1ST AVENUE, SUITE 201 ARCADIA, CA 91006

T: 626-254-8884 E:info@jtcarch.com

JTC PROJECT NO: **37606.0D**

CONSULTANT

innovave Consulting & Design

12970 Branford St, Unit F, Arleta, CA 91331 DIRECT: 818-630-5755 FAX: 818-892-2322 WWW.innovave.com

MDF1-103 & MDF2-107 RACK **ELEVATIONS**

AS NOTED 02-06-25 DRAWN BY: CHECKED BY:

SHEET NUMBER:

BID SET

SE-07

DELUXE GUARD BOOTH STYLE MODEL: DS680B

MANUFACTURED FOR:

NORM WILSON & SONS

PERRIS PROJECT SMALL BOOTH

PERRIS, CALIFORNIA

BY: B.I.G. ENTERPRISES 9702 E. RUSH ST

SOUTH EL MONTE CA 91733

DRAWING TITLE	SHEET NUMBER
COVER PAGE	ļ
E \$ E2 ELEVATIONS	2
E3 \$ E4 ELEVATIONS	3
FLOOR PLAN	4
STUB AREA \$ ANCHOR PLAN	5
ELECTRICAL NOTES & PLAN	6
FLOOR FRAMING PLAN	7
ROOF SECTION	8
DETAILS	9
GENERAL NOTES	10

FIELD INSTALLED EQUIPMENT

THE FOLLOWING ITEMS WERE NOT INSTALLED AT THE FACTORY BY B.I.G. ENTERPRISES. THESE ITEMS ARE TO BE DESIGNED AND INSTALLED ON SITE BY OTHERS SUBJECT TO REVIEW AND APPROVAL BY THE LOCAL BUILDING DEPARTMENT:

- I) FOUNDATION AND ANCHORAGE SYSTEM
- 2) UTILITY CONNECTIONS
- INSTALLATION OF A/C UNIT INTO SLEEVE
- ADA RAMP

SHEET	_	OF	7
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02-M. E: AS BY: JH DATE: SCALE

RRIS

GENERAL INFO

6'-0" x 8'-0" x 8'-5" TALL SINGLE STORY 48.0 SQ. FT. ONE (I) UNIT

BASIC DESIGN CRITERIA

OCCUPANCY GROUP: B CONSTRUCTION CLASSIFICATION: V-B WIND LOAD: Vult = 115 MPH

Exposure C RISK CATEGORY: II FLOOR LOAD: 60 PSF ROOF LIVE LOAD: 25 PSF ROOF DEAD LOAD: 5 PSF GROUND SNOW LOAD: O PSF SEISMIC DESIGN DATA

SPECTRAL RESPONSE COEFFICIENTS: $S_5 = 1.46, S_1 = 0.54$ $S_{DS} = 1.17, S_{D1} = 0.61$

RISK CATEGORY: II

SEISMIC DESIGN CATEGORY: D

BASIC SEISMIC FORCE RESISTING SYSTEM: C.4

DESIGN BASE SHEAR 0.33 x SEISMIC WEIGHT OF STRUCTURE RESPONSE MODIFICATION FACTOR R=3.5

ANALYSIS PROCEDURE USED: ALLOWABLE STRESS DESIGN

FOUNDATION

- A. THE FOUNDATION WORK IS TO BE DESIGNED AND INSTALLED BY OTHERS IN ACCORDANCE WITH LOCAL CODES AND SOIL CONDITIONS.
- B. THE FLOOR SYSTEM IS DESIGNED FOR CONTINUOUS SUPPORT BY A CONCRETE SLAB.

NOTE: THIS UNIT WILL NOT BE PLACED IN A

WILDFIRE URBAN INTERFACE ZONE

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APPLICABLE CODES

2022 CALIFORNIA BUILDING CODE 2022 CALIFORNIA MECHANICAL CODE

2022 CALIFORNIA ENERGY CODE

2022 CALIFORNIA GREEN CODE

2022 CALIFORNIA ELECTRICAL CODE

2022 CALIFORNIA PLUMBING CODE

BID SET

02-06-25

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DEPARTMENT OF PUBLIC WORKS
900 SOUTH FREMONT AVE. 8TH FLOOR

PROJECT :

CAMP ROCKEY SECURITY UPGRADES PW15739, PCA: P9700226, PCS ID:00002237

LOCATION

1900 N. SYCAMORE ROAD, SAN DIMAS, CA 91773

::::: JTC

65 N. 1ST AVENUE, SUITE 201 ARCADIA, CA 91006 r: 626-254-8884

E: info@jtcarch.com

JTC PROJECT NO: **37606.0D**

CONSULTANT

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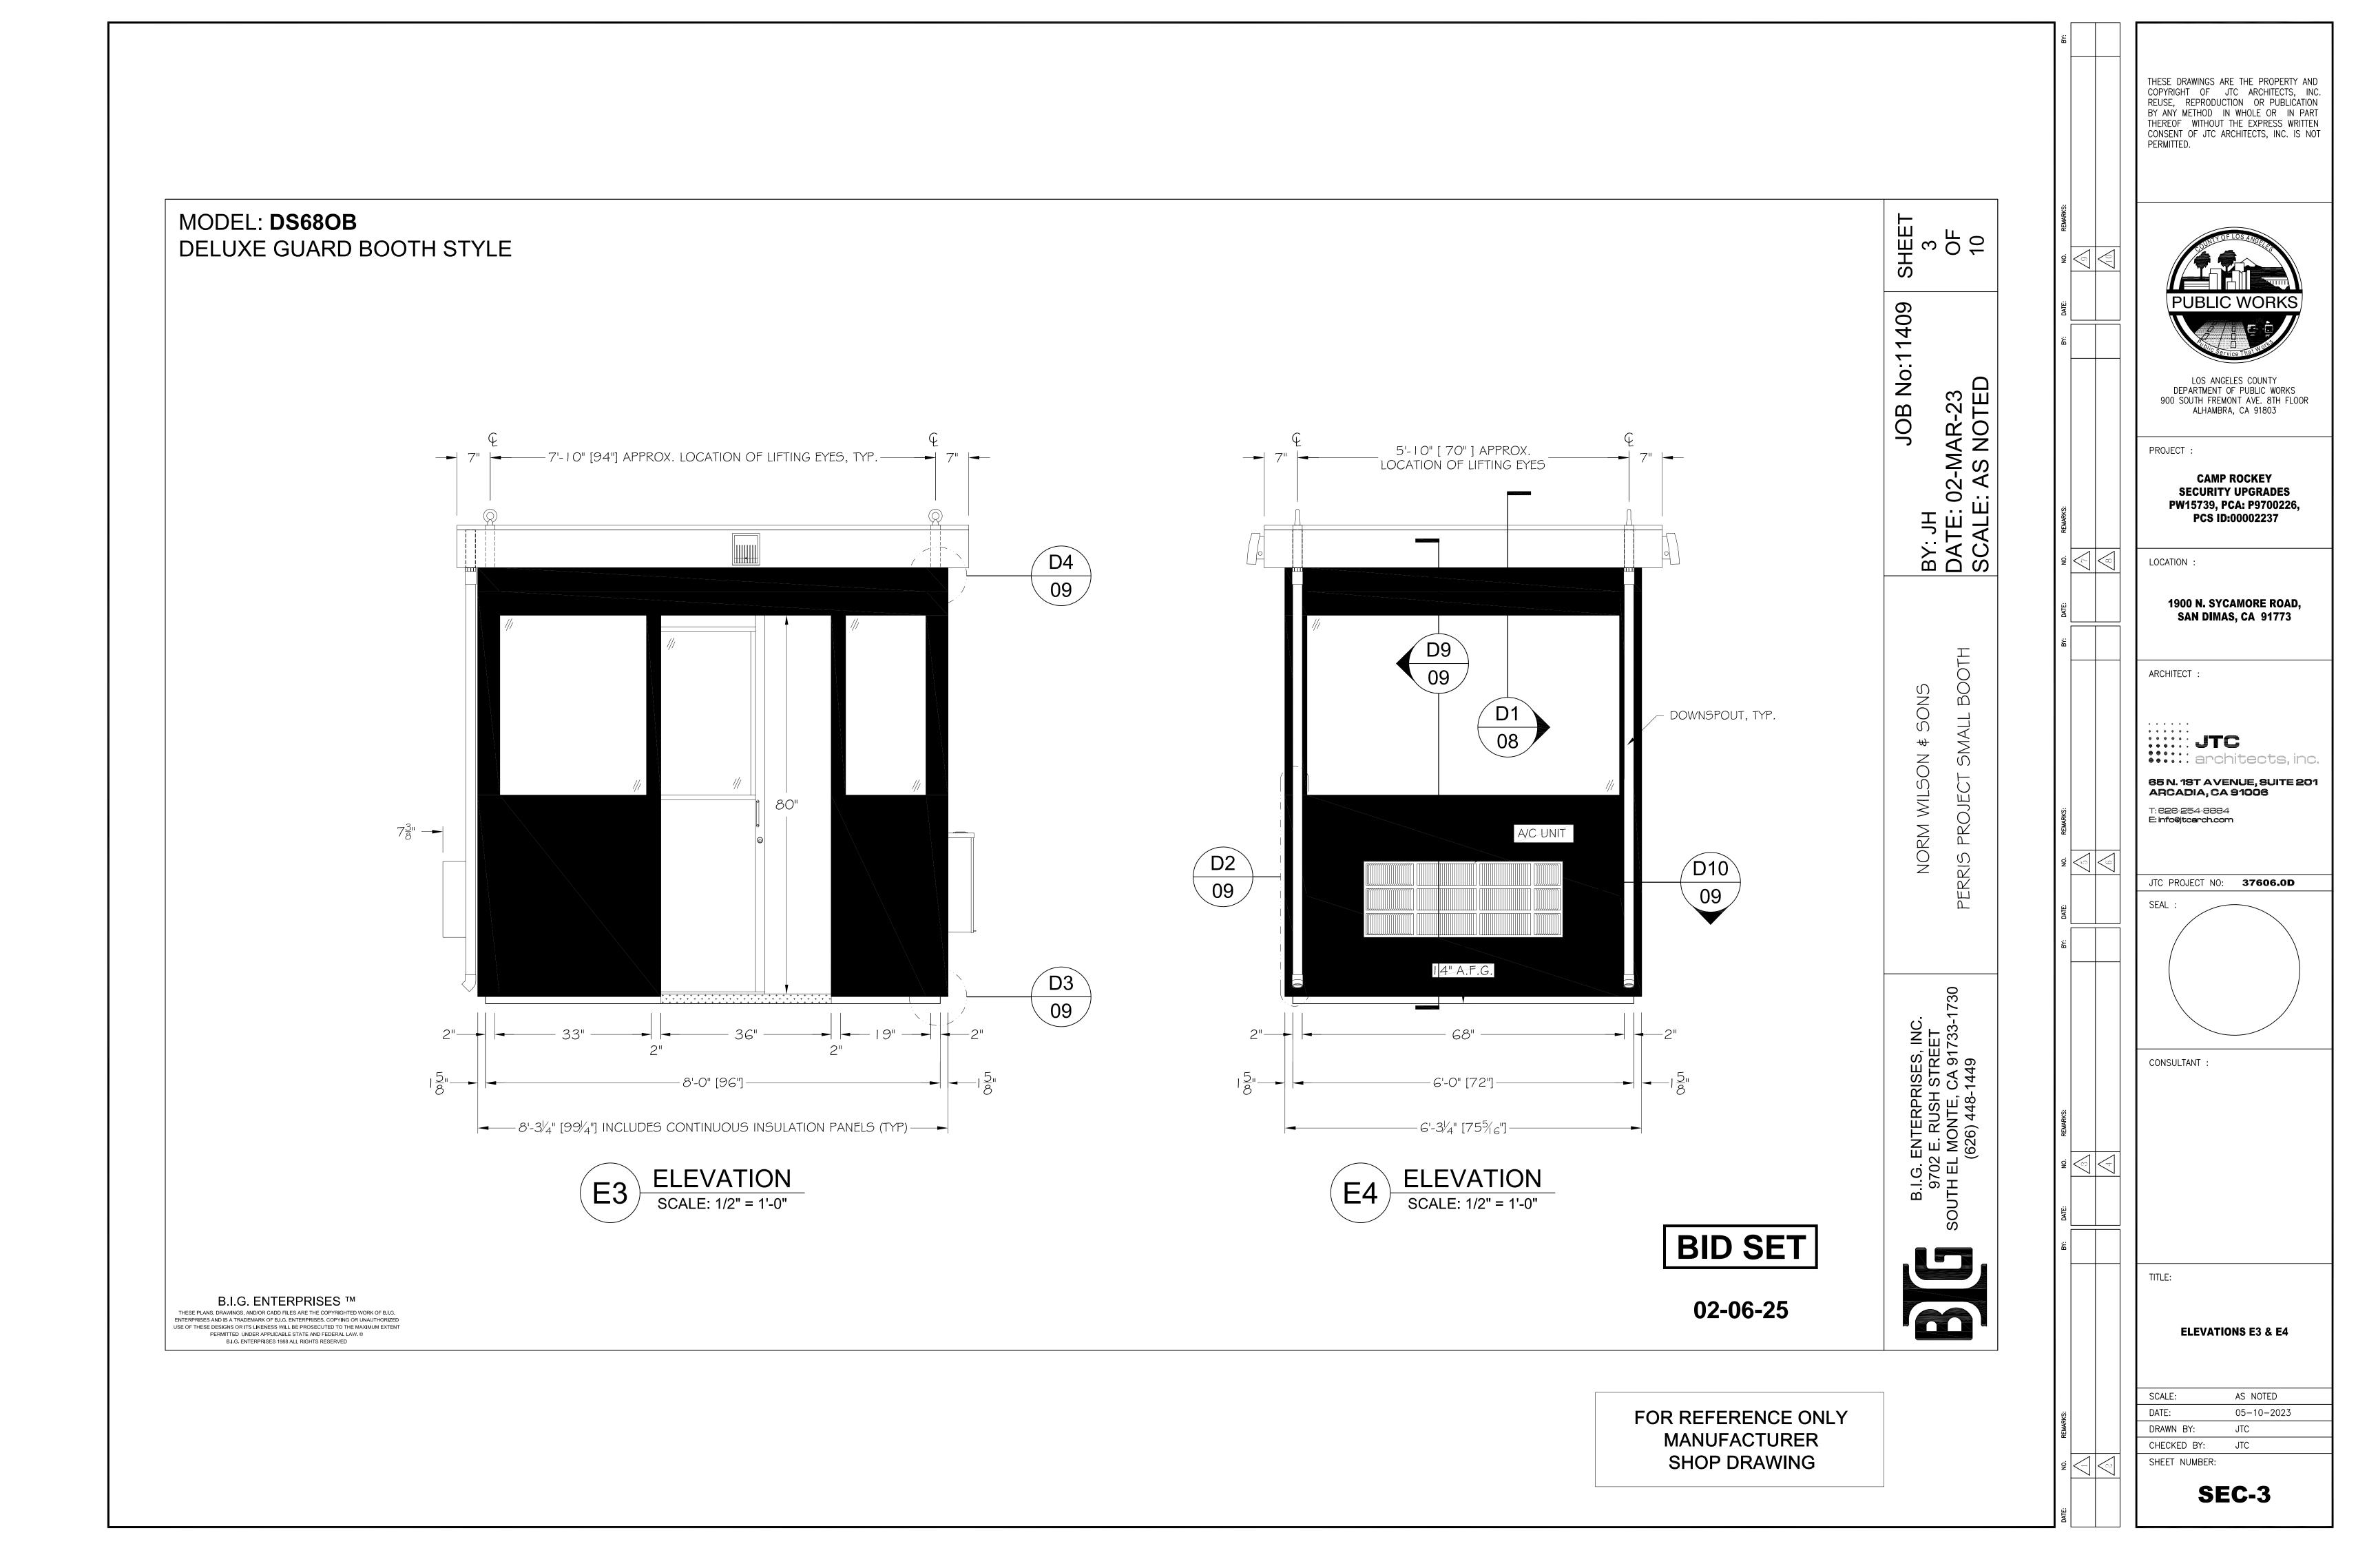
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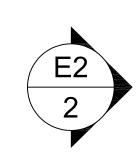
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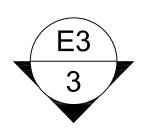



MODEL: **DS68OB**DELUXE GUARD BOOTH STYLE


FLOOR PLAN LEGEND:

- 1 36" x 80" SLIDING DOORS GENERAL NOTE DI
- 2 20" GALV STEEL SHELF GENERAL NOTE A I
- 3 Ø3" CORD ACCESS HOLE
- 4 LOAD CENTER ELECTRICAL NOTE E I
- 5 ELECTRICAL CABINET ELECTRICAL NOTE E I
- 6 ANCHOR CLIP (4 PLACES) GENERAL NOTE S5
- 7 OVERHANG GENERAL NOTE R I
- 8 DOWNSPOUT (2 PLACES) GENERAL NOTE R I
- 9 CONTINUOUS INSULATION PANEL GENERAL NOTE S3
- 10 A/C UNIT MECHANICAL NOTE M I
- I I ATTIC VENTS (6 PLACES)





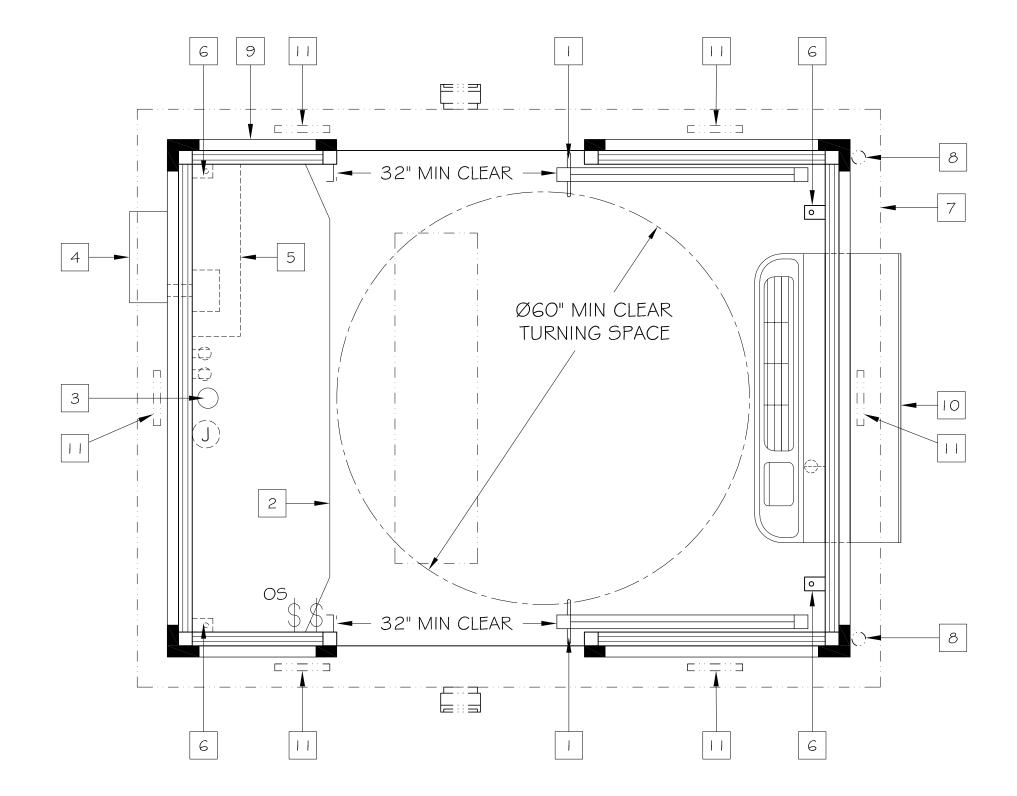

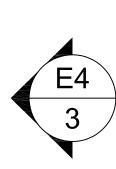

S, INC. EET 1733-1730 PERRIS PRC

SONS

₩-

SHEET 4 OF 10

02-

BY: JH DATE: SCALI

1409

No:1

B.I.G. ENTERPRISES, INC. 9702 E. RUSH STREET SOUTH EL MONTE, CA 91733-1730 (626) 448-1449



E1 FLOOR PLAN

SCALE: 1/2" = 1'-0"

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DEPARTMENT OF PUBLIC WORKS
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ALHAMBRA, CA 91803

PROJECT :

CAMP ROCKEY SECURITY UPGRADES PW15739, PCA: P9700226, PCS ID:00002237

LOCATION :

1900 N. SYCAMORE ROAD, SAN DIMAS, CA 91773

ARCHITECT :

JTC
architects, inc.

65 N. 18T AVENUE, SUITE 201 ARCADIA, CA 91006 T: 626-254-8884

T: 626-254-8884 E: info@jtcarch.com

JTC PROJECT NO: 37606.0D

CONSULTANT

ON CO

TITLE:

FLOOR PLAN

SCALE: AS NOTED


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1900 N. SYCAMORE ROAD, SAN DIMAS, CA 91773

ARCHITECT

JTC
architects, inc.

65 N. 18T AVENUE, SUITE 201 ARCADIA, CA 91006

T: 626-254-8884 **E: info@jtcarch.com**

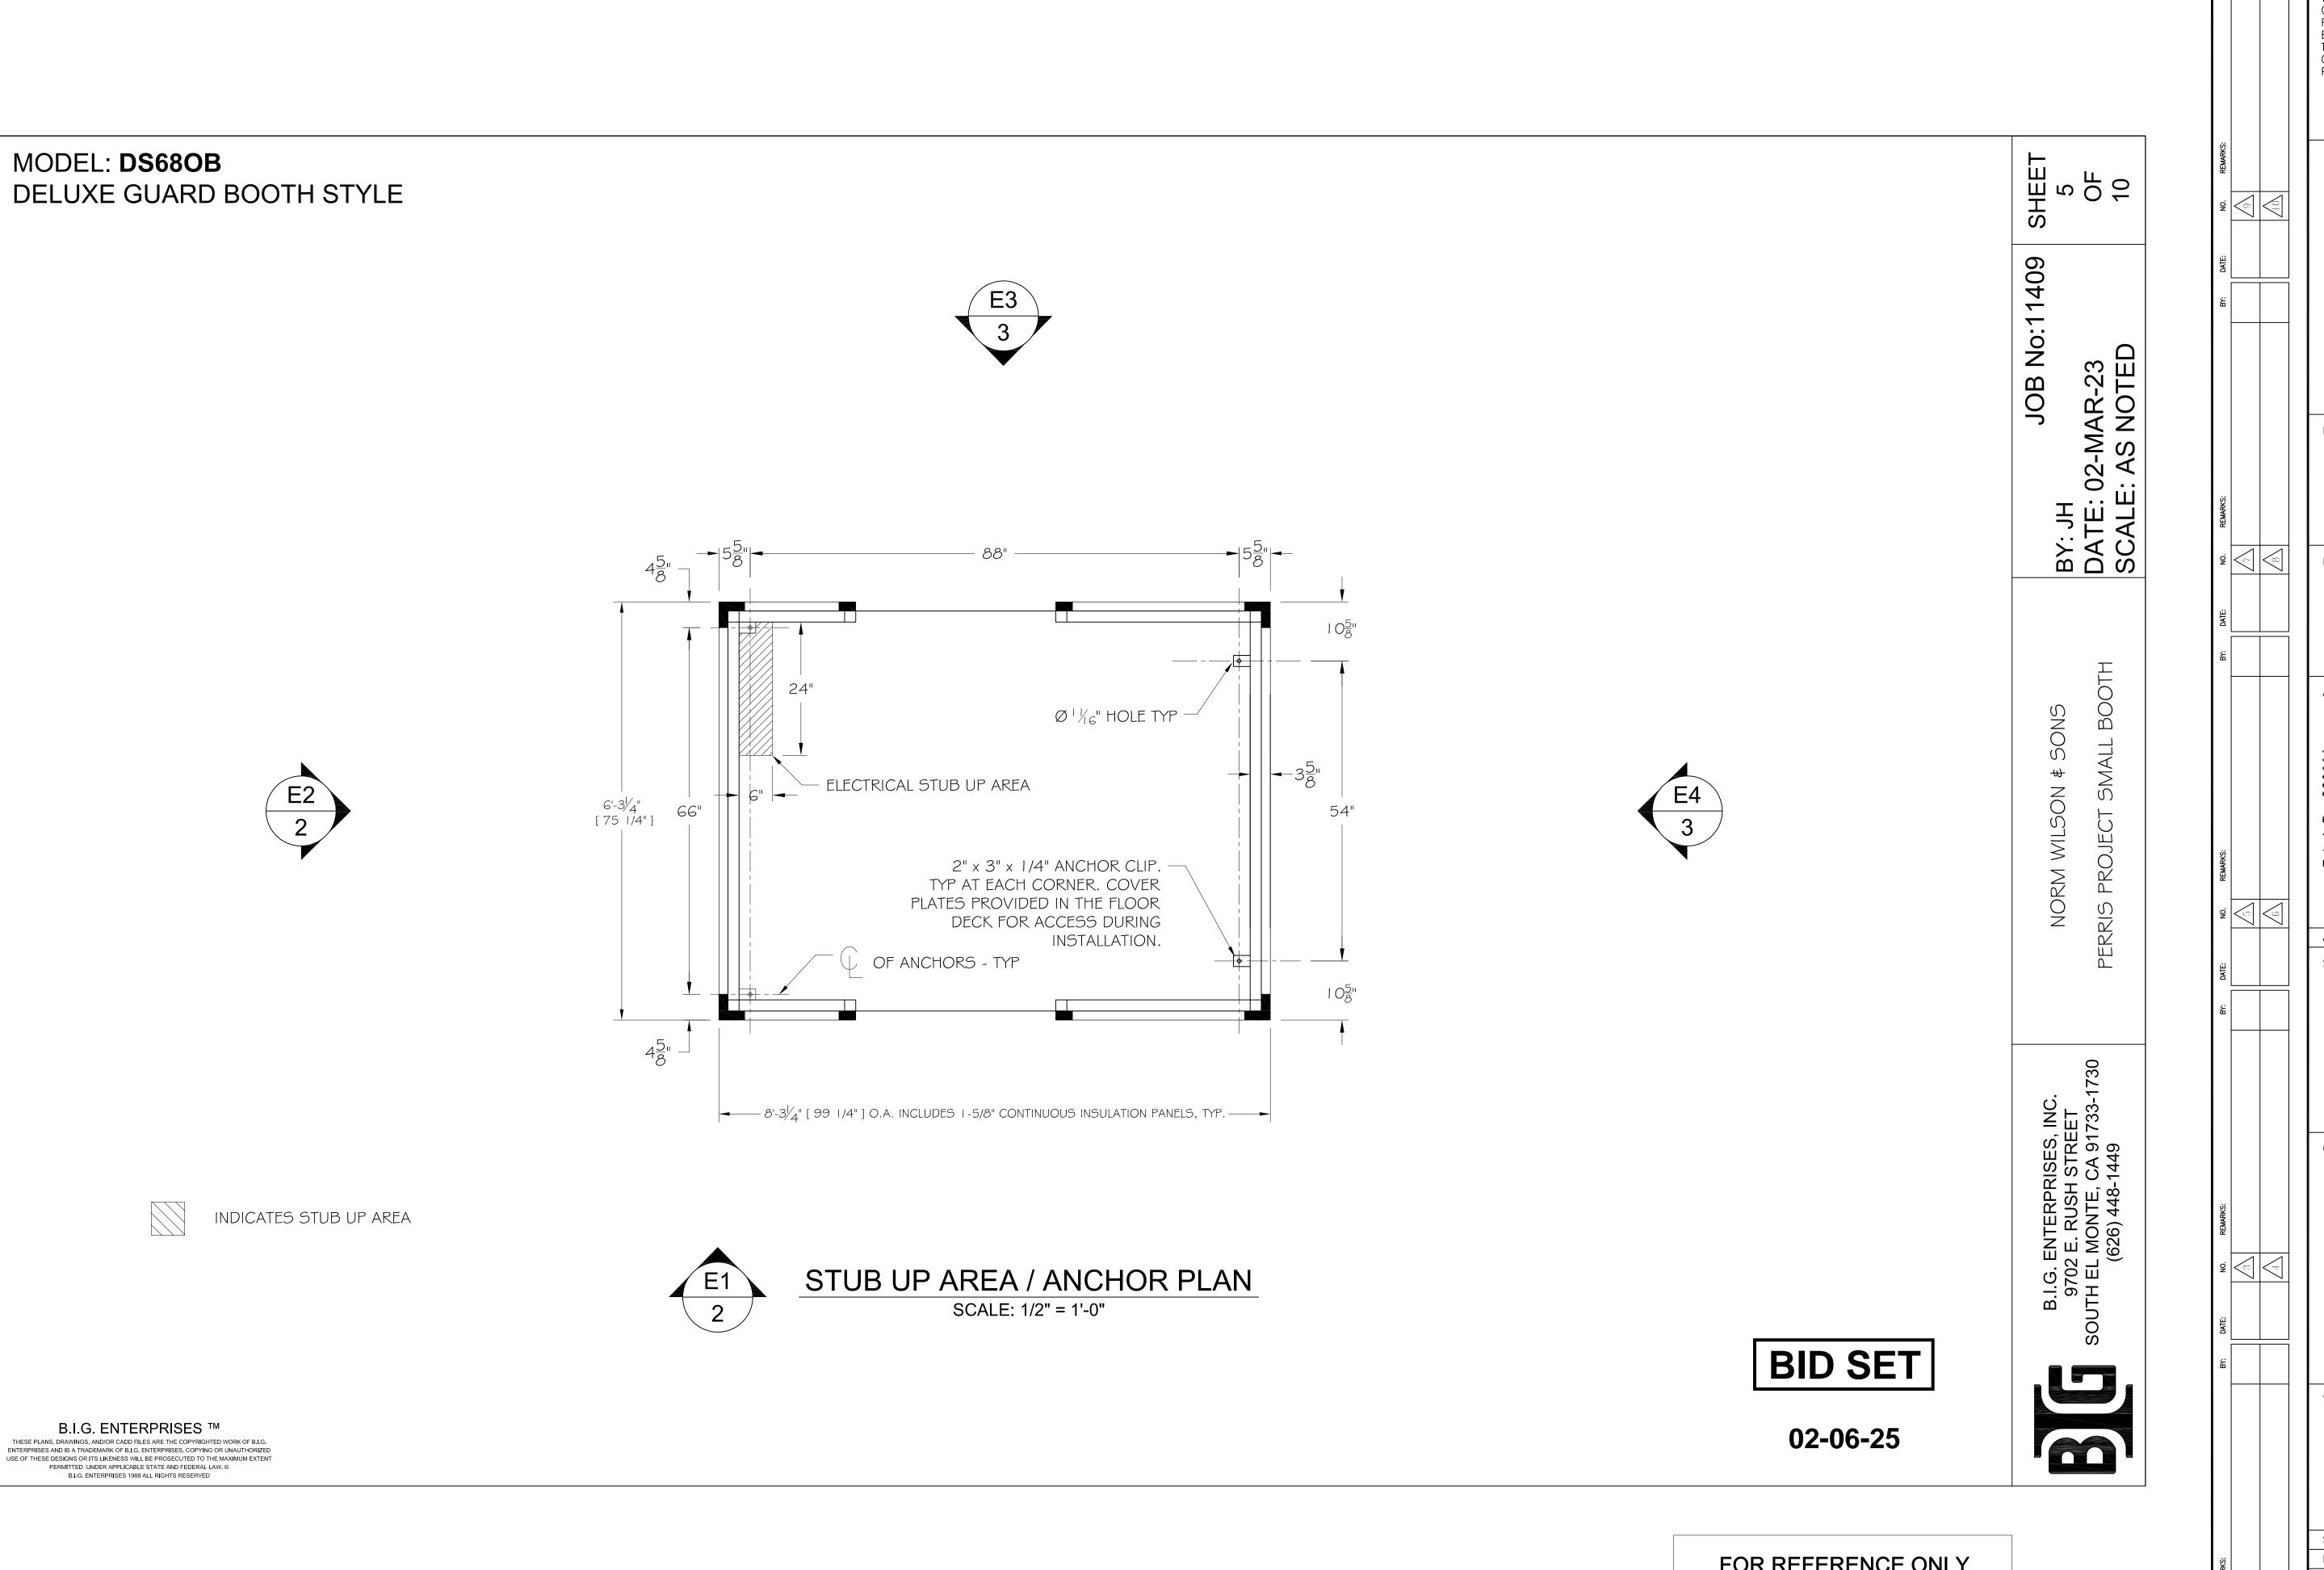JTC PROJECT NO: **37606.0D**

CONSULTANT :

SHEET NUMBER:

TITLE:

FLOOR PLAN -SHOWING STUB AREA

SCALE: AS NOTED 05-10-2023 DRAWN BY: JTC JTC CHECKED BY:

SEC-5

FOR REFERENCE ONLY **MANUFACTURER** SHOP DRAWING

MODEL: **DS680B** DELUXE GUARD BOOTH STYLE

ELECTRICAL NOTES:

- EI. UNIT TO HAVE ONE SINGLE PHASE THREE WIRE, I 2 POLE, I 25 AMP RATED, I 20/240V LOAD CENTER (SUBJECT TO AVAILABILITY) SURFACE MOUNTED ON THE EXTERIOR FRONT WALL IN A NEMA 3R ENCLOSURE.
 - A. UNIT TO HAVE A $6" \times 6" \times 4"$ DEEP JUNCTION BOX IN AN ELECTRICAL CABINET ON THE INTERIOR WITH A \emptyset I I/2" NIPPLE THROUGH THE WALL INTO THE LOAD CENTER. FACTORY-INSTALLED WIRING WILL RUN THROUGH THIS JUNCTION BOX.
- E2. ALL ELECTRICAL EQUIPMENT TO BE U.L. LISTED AND ALL WIRING TO BE PER CURRENT PUBLISHED NEC STANDARDS. ALL CONDUCTORS TO BE COPPER, WITH A MINIMUM SIZE OF THHN #12 SOLID COPPER. EXPOSED WIRING TO BE IN SURFACE MOUNTED EMT CONDUIT. CONCEALED WIRING TO BE IN FLEXIBLE ALUMINUM CONDUIT. FINAL POWER CONNECTION AND GROUNDING TO BE DONE ON SITE BY OTHERS. ALL WORK TO BE DONE BY A QUALIFIED ELECTRICIAN IN ACCORDANCE WITH ALL APPLICABLE LOCAL CODES.
 - A. ALL CIRCUITS TO BE GROUNDED.
- B. ALL STEEL EQUIPMENT AND EXPOSED STRUCTURAL STEEL TO BE BONDED TO ELECTRICAL SYSTEM.
- E3. UNIT TO HAVE (2) 125V DUPLEX RECEPTACLES MOUNTED UNDER THE SHELF.
- UNIT TO HAVE (I) SINGLE GANG JUNCTION BOX MOUNTED UNDER THE SHELF.
- ALL EMPTY JUNCTION BOXES TO HAVE PULL STRINGS W/ LABELS AT EACH END, U.N.O.
- ITEMS OF A SIMILAR NATURE SHALL BE OF THE SAME TYPE AND MANUFACTURE, U.N.O.
- E7. ALL HEIGHT CALLOUTS FOR LIGHT SWITCHES & RECEPTACLE/JUNCTION BOXES TO BE MEASURED TO TOP OF BOX, U.N.O.
- ALL DETAILS, SECTIONS, AND NOTES SHOWN ON THE DRAWINGS ARE INTENDED TO BE TYPICAL AND SHALL APPLY TO SIMILAR SITUATIONS ELSEWHERE, UNLESS NOTED OTHERWISE. NOTES AND DETAILS ON THE DRAWINGS TAKE PRECEDENCE OVER THE GENERAL NOTES AND TYPICAL DETAILS.


MECHANICAL NOTES:


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- MI. THE UNIT TO HAVE ONE THRU-WALL HEAT PUMP UNIT; EQUIPMENT TO BE A GENERAL ELECTRIC ZONELINE MODEL AZ65H I 5DAB (OR EQUAL).
- A. A/C UNIT TO BE PLUG AND CORD CONNECTED AND WILL HAVE A DEDICATED CIRCUIT.





ELECTRICAL PLAN

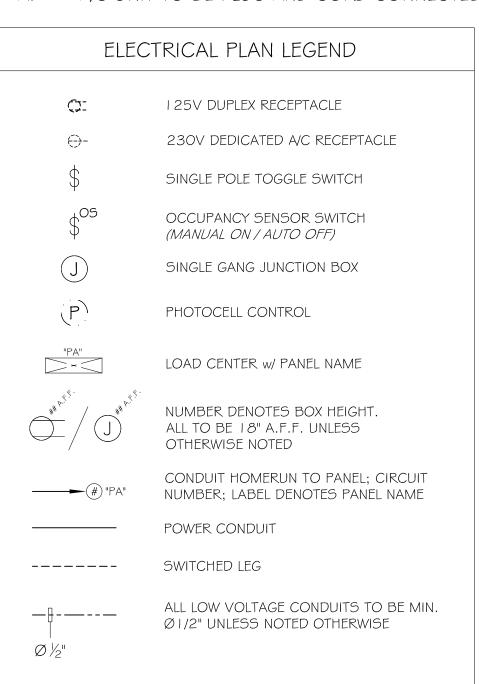SCALE: 1/2" = 1'-0"

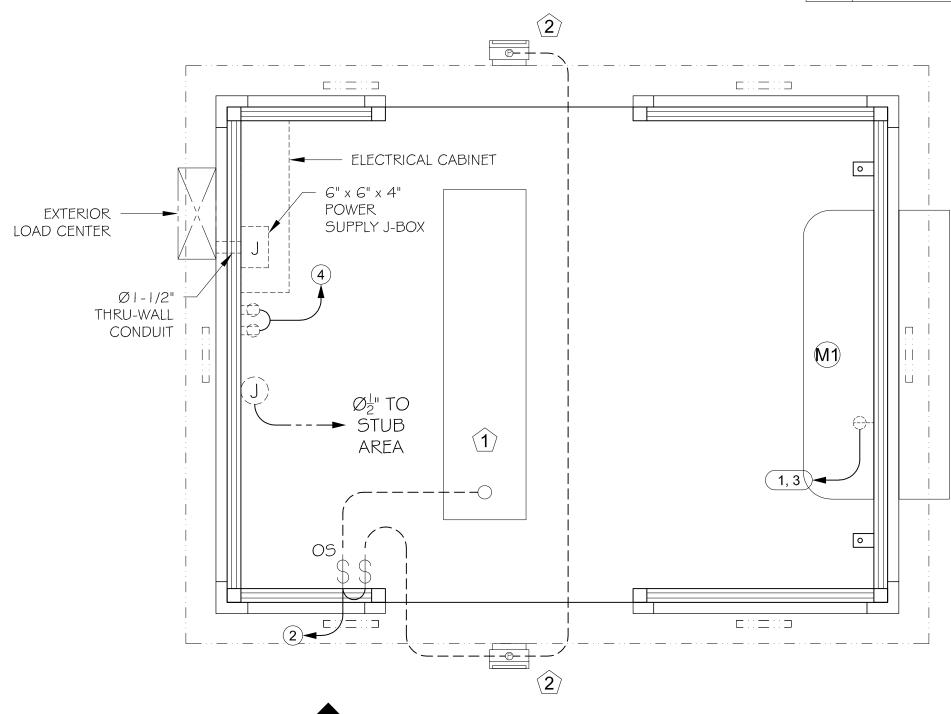												-	
				PANE	EL S	CHE	DULE	=					о Н О
	PANEL NAME: TBD		VOLTS:	120 / 2	40V					MAIN TYPE: MAIN LUGS	,		- 0 +
	MOUNTING: SURFACE		WIRES:	THRE	E					BUS RATING: 125A		S	
	ENCLOSURE: NEMA 3R		PHASE:	SINGL	.E				MAI	N BREAKER RATING: N/A			
СКТ	DESCRIPTION	C.B. AMPS	C.B. POLES	,	4	E	3	C.B. POLES	C.B. AMPS	DESCRIPTION	СКТ	409	
1	HVAC UNIT	204	2	2415	44			1	20A	(1) INTERIOR & (2) EXTERIOR LIGHTS	2		
3	HVAC UNIT	30A	2			2415	360	1	20A	(2) DUPLEX	4	1	
5											6	2	
7											8		23 E
9											10	\Box	2 F
11											12		\mathbb{Z}
		TOTAI	_ A LEG	24	.59	27	75	TOTAL	B LEG			7	₹ Z
			Т	OTAL V	WATTS	52	34						-M S
			Т	OTAL :	x 125%	654	12.5)2: A
				WATTS	/ 240V	27	7. 3	AMPS					0 E:
												_	┯╶╬╬┖╩╣

MECHANICAL EQUIPMENT SCHEDULE								
ITEM	DESCRIPTION	MANUFACTURER	MODEL NO.	BTU/h COOL HEAT		EER RATING	NOTES	
MI	ZONELINE A/C	GENERAL ELEC.	AZG5H I 5DAB	14,500	16,300	10.4	HEAT PUMP MODEL	

	LIGHTING SCHED	DULE				
ITEM	DESCRIPTION	MANUFACTURER	MODEL NO.	TYPE	QTY	NOTES
	I' x 4' LED FIXTURE	MAXLITE	MLFP I 4G420WCS	20 W	1	OCCUPANCY SENSOR
2	LED WALL PACK	LUMARK	XTOR I B-PC I	12 W	2	PHOTOCELL CONTROL

NORM PERRIS

BY: JH DATE: SCALE


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02-06-25

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DEPARTMENT OF PUBLIC WORKS
900 SOUTH FREMONT AVE. 8TH FLOOR ALHAMBRA, CA 91803

PROJECT :

CAMP ROCKEY SECURITY UPGRADES PW15739, PCA: P9700226, PCS ID:00002237

LOCATION

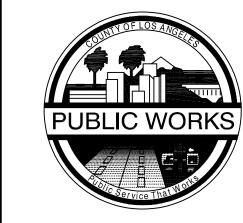1900 N. SYCAMORE ROAD, SAN DIMAS, CA 91773

ARCHITECT

......JTC

65 N. 18T AVENUE, SUITE 201 ARCADIA, CA 91008 r: 626-254-8884 E: info@jtcarch.com

JTC PROJECT NO: **37606.0D**

CONSULTANT

TITLE:


ELECTRICAL NOTES

SCALE: AS NOTED 05-10-2023 DRAWN BY: JTC CHECKED BY: JTC

SEC-6

SHEET NUMBER:

SHOP DRAWING

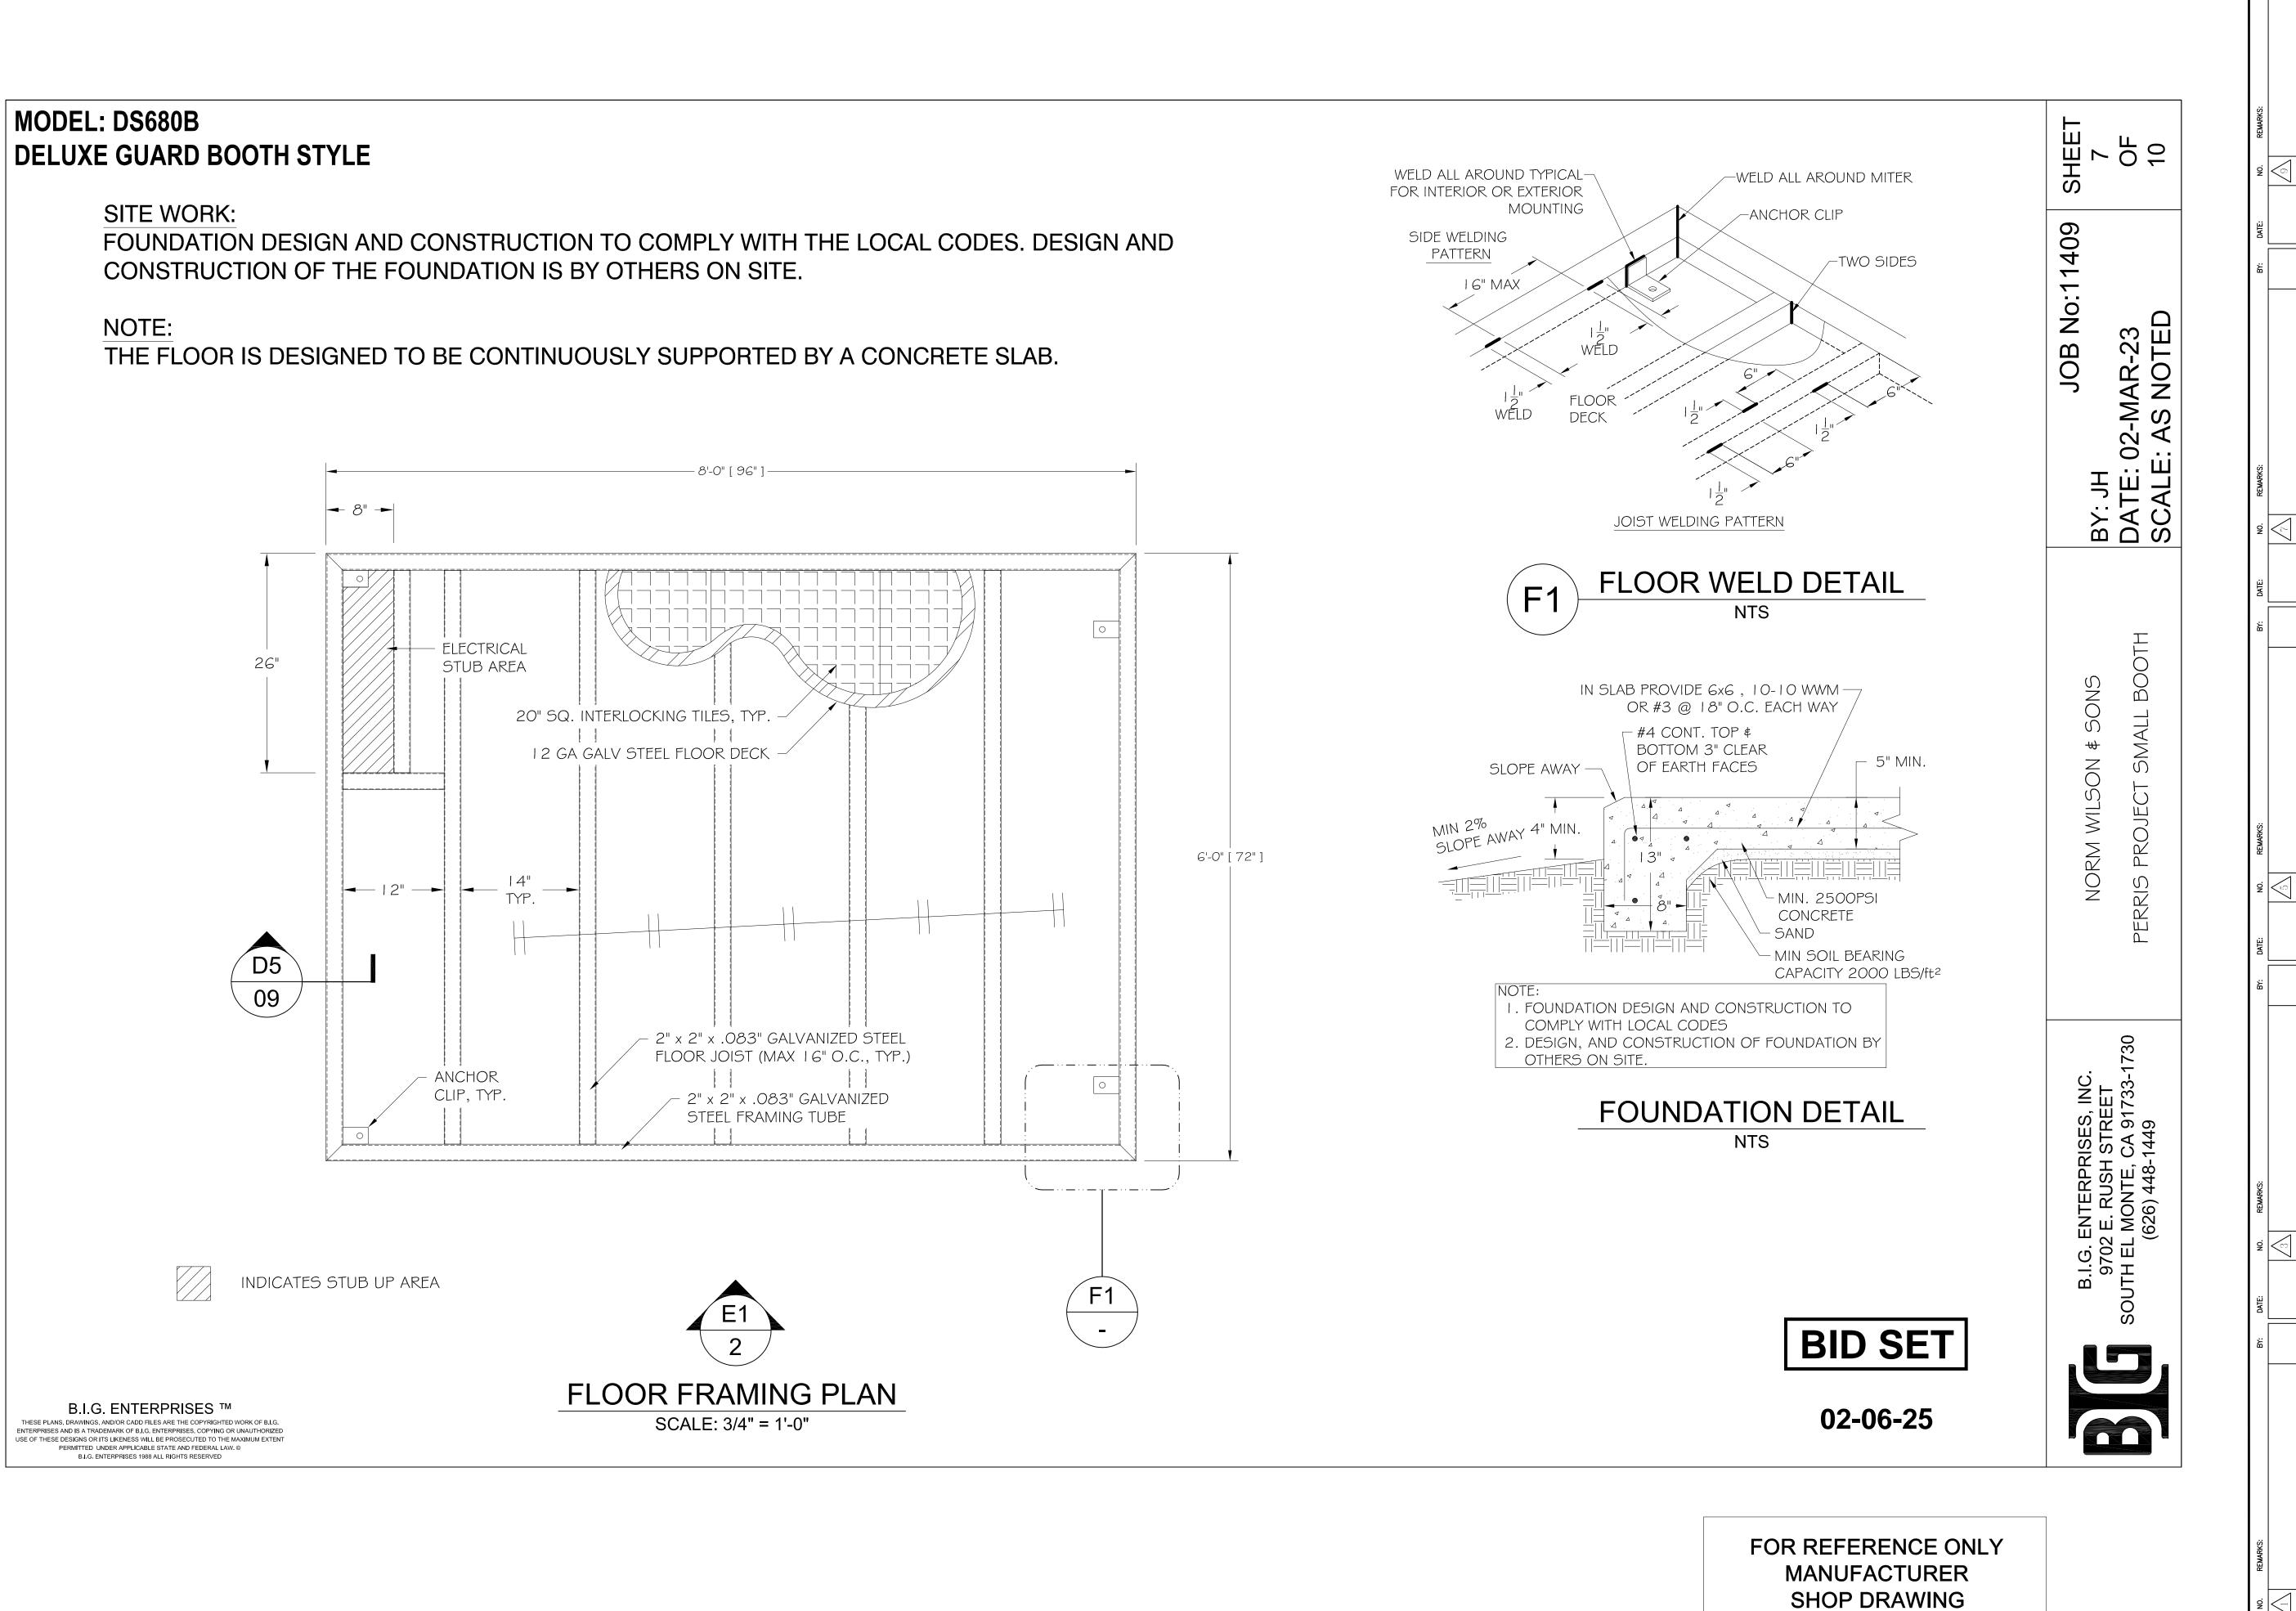

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ARCHITECT

LOCATION

JTC

65 N. 18T AVENUE, SUITE 201 ARCADIA, CA 91006 r: 626-254-8884 E: info@jtcarch.com

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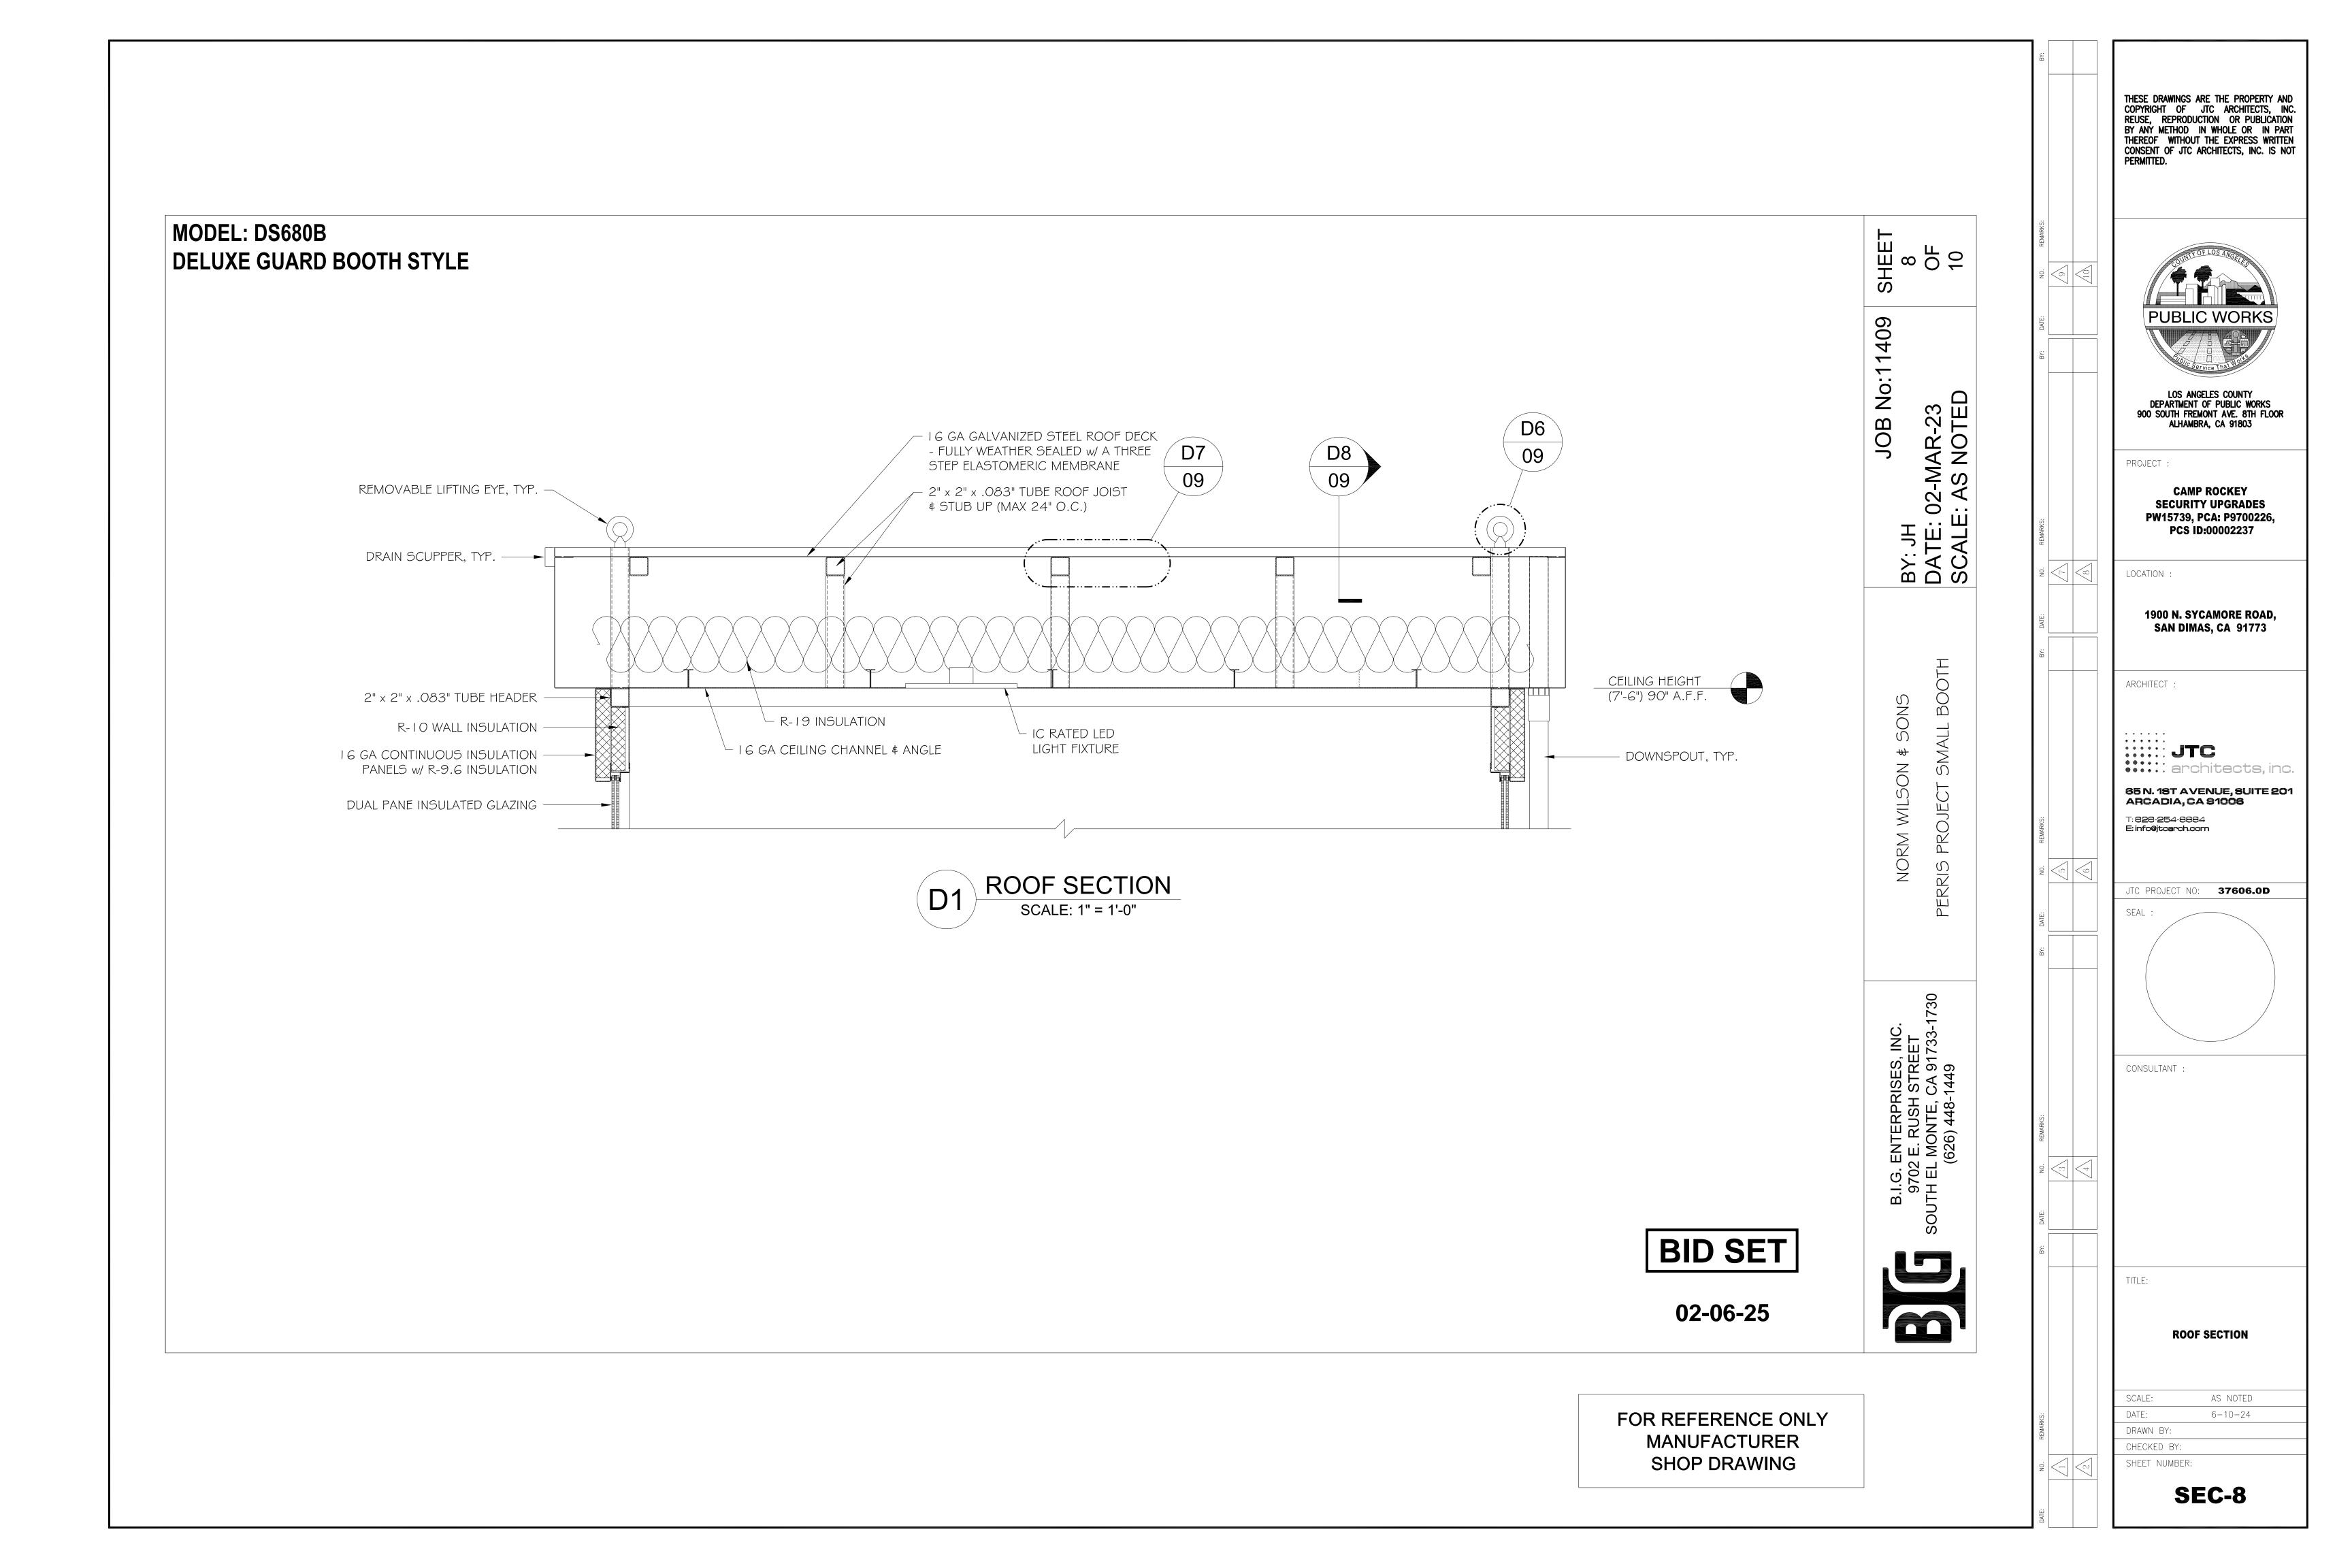
CONSULTANT


FLOOR FRAMING PLAN

SCALE: AS NOTED


05-10-2023 DRAWN BY: JTC CHECKED BY: JTC SHEET NUMBER:

SEC-7



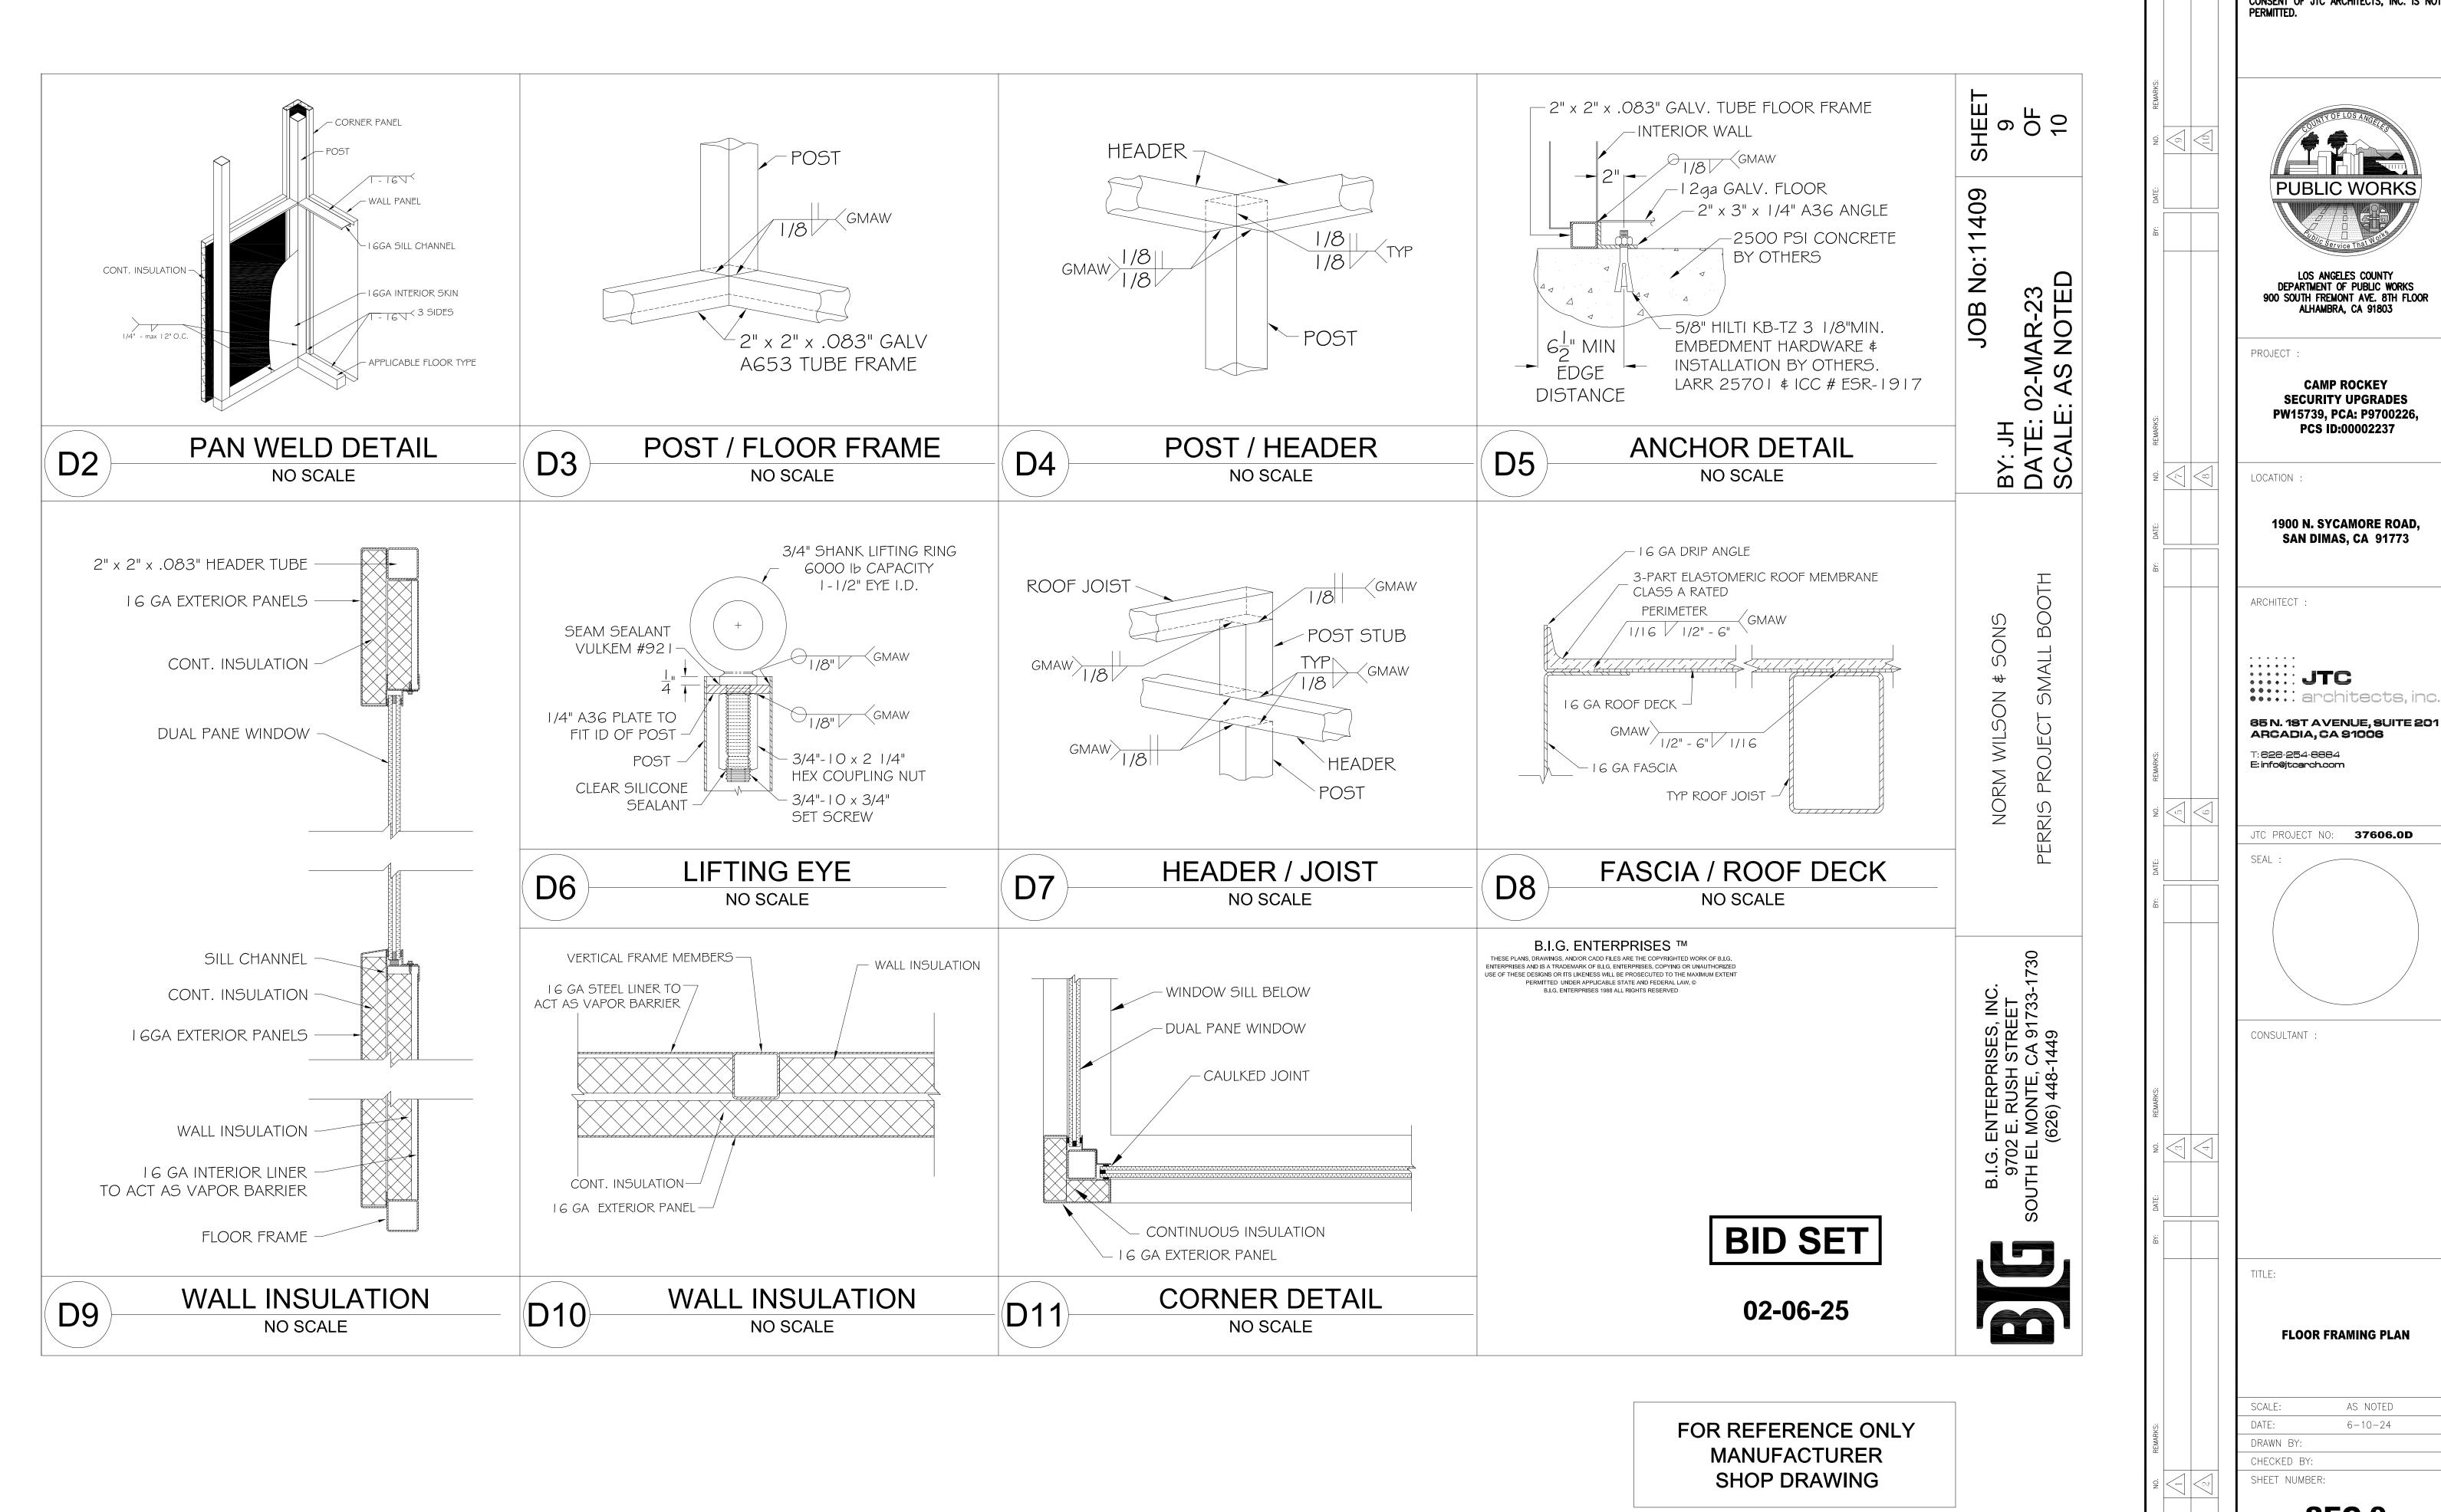

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1900 N. SYCAMORE ROAD, SAN DIMAS, CA 91773

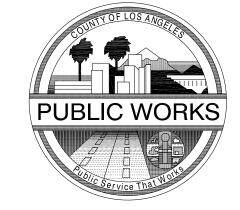JTC

85 N. 18T AVENUE, SUITE 201 ARCADIA, CA 91006

T: 626-254-8884 **E: info@jtcarch.com**

TC PROJECT NO: **37606.0D**

FLOOR FRAMING PLAN

AS NOTED 6-10-24

SEC-9

MODEL: **DS68OB**DELUXE GUARD BOOTH STYLE

GENERAL NOTES:

STRUCTURAL:

- SI. Frame members to consist of 2" x 2" x .083" tube.
- S2. Unit to have half glazed 16 ga galvanized steel interior and exterior walls.
- S3. Walls to have an R-10 insulation value plus an additional layer of continuous R-9.6 insulation for a total of R-19.6.
- 54. Unit to have a 12 ga A653 galvanized steel floor covered with 1/4" thick x 20" square, black commercial polyvinyl chloride interlocking tiles with a 4" high black perimeter cove molding. Floor to be mounted on a 2" tall galvanized steel tube frame.
- A. Floor will require a ramp the full width of one door opening with a slope of I" to I'- O" to meet ADA handicap access requirements (ramp by others onsite) or alternatively the booth can be recessed 2" into the slab.

CAUTION: Please contact your sales representative for additional information when planning on recessing the booth into the slab.

S5. Unit to have four interior anchor clips. Four 5/8" Hilti KB-TZ bolts (LARR 25701, ICC-ESR-1917) with 3 1/8" minimum embedment in 2500 psi concrete (or equal) are required for placement of booth. Concrete to be level. If sloped, slope towards drain opening(s) on booth. Concrete, bolts and mounting shall be by others. For a 3-1/8" embedment the foundation/slab design must be a minimum of 5" thick and be sized to allow for a minimum distance of 6-1/2" from the edge of the slab to the center line of the anchors for maximum strength.

ROOF:

- RI. Unit to have an 8" tall fascia, with a 6" overhang and I" drip angle on all sides, a 16 ga galvanized steel roof designed to drain through two rear mount ØI-I/2" PVC
- R2. Roof to have insulation with an R-19 value.
- R3. Unit to have four 3/4" shank lifting eyes (3/4" dia. shank, eye is 1-1/2" I.D.) mounted on the roof. Lifting eyes are designed for a STRAIGHT VERTICAL LIFT ONLY. Spreader bars must be used when lifting booth to ensure this vertical lift. All warranties will be void if not lifted in this manner.

DOORS # WINDOWS:

- D1. Unit to have two commercial grade steel framed slide doors on the left wall and right walls, 36" x 80" constructed of 16 ga steel panels with steel tube frames. Doors to be top hung, in a steel track, on a minimum of eight 2 1/4" steel ball bearing rollers with stainless steel lower guide, mortise hook type lock and complete weather stripping. **Doors to be keyed alike.**
- WI. Unit to have 3/4" Gray tinted tempered dual pane insulating glass with Low-E coating.

ACCESSORIES:

- A1. Unit to have one 20" deep steel shelf, with one Ø3" electric access hole with grommet insert for drop down cords. Shelf to be painted same color as the booth interior and mounted at 34" above finished floor.
- A2. Shelf to be rated for a 250 lb. load.

WEATHERPROOFING & FINISHING:

- FI. Unit to have a 16 ga galvanized steel ceiling mounted at 90" A.F.F. The ceiling is to be painted to match the building interior.
- F2. All exposed steel surfaces except roof deck to be coated with two component high solids polyurethane rust inhibitive primer, and two component high solids polyurethane finish coat.

F3. Unit to be painted one color, inside and out.

A. Customer to provide paint color selection prior to manufacturing.

- F4. Roof to be fully weather sealed with a three step elastomeric membrane as follows:
- A. All seams are sealed with a high bond seam sealing tape.
- B. The entire roof deck is then coated with a liquid applied one-part polyurethane coating forming a tough waterproof, weather-resistant elastomeric coating.
- C. The entire deck surface finished with a white heat reflective polyurethane coating. The coating meets Energy Star reflectance and emissivity performance requirements, has an SRI of 95, and is approved by the Cool Roof Rating Council (CRC)

SHEET 10 OF 10

JOB No:11409

BY: JH DATE: 02-MAR-23 SCALE: AS NOTED

NORM WILSON \$ SONS PERRIS PROJECT SMALL BOOTH

B.I.G. ENTERPRISES, INC. 9702 E. RUSH STREET SOUTH EL MONTE, CA 91733-1730 (626) 448-1449

Sor

BID SET

02-06-25

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ARCHITECT :

JTC architects, inc.

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JTC PROJECT NO: **37606.0D**SEAL:

CONSULTANT :

TITLE:

GENERAL NOTES

: AS NOTED

6-10-24

DRAWN BY:

CHECKED BY:

SHEET NUMBER:

SEC-10

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