# **ATTACHMENT C**

## **GENERAL NOTES**

- CONTRACTOR SHALL BE HELD RESPONSIBLE FOR HAVING VISITED THE SITE AND HAVING FAMILIARIZED HIMSELF WITH THE EXISTING CONDITIONS PRIOR TO SUBMITTING HIS BID.
- 2. THE CONTRACTOR SHALL VERIFY ALL DIMENSIONS PRIOR TO ANY DEMOLITION OR CONSTRUCTION AT THE JOB SITE. ANY DISCREPANCY TO NOTIFY LA COUNTY ARCHITECT IMMEDIATELY
- . ALL WORK SHALL BE PERFORMED AS PER CALIFORNIA BUILDING CODE. 2022 EDITION AND ALL INSPECTIONS SHALL BE PERFORMED AS REQUIRED BY THE COUNTY OF LOS ANGELES BUILDING DEPARTMENT AND THEIR RELATED
- CONTRACTOR SHALL MAINTAIN A SET OF PLANS, APPROVED BY THE LOCAL BUILDING DEPARTMENT, ON THE JOB SITE AT ALL TIMES DURING
- 5. ALL WORK AND MATERIALS SHALL CONFORM TO THE REQUIREMENTS OF THE LATEST EDITIONS OF THE COUNTY OF LOS ANGELES BUILDING CODE AND UNIFORM BUILDING CODE STANDARDS, CALIFORNIA CODE OF REGULATIONS HANDICAPPED ACCESSIBILITY REQUIREMENTS (TITLE 24), AMERICANS WITH DISABILITIES ACT (ADA), THE PLANS AND THE PROJECT MANUAL.
- THIS PROJECT REQUIRES THE PRIME CONTRACTOR TO POSSESS A LICENSE CLASSIFICATION B AT THE TIME OF BID AWARD. CONTRACTORS SHALL VERIFY THAT ALL CORRECT LICENSES ARE POSSESSED FOR THIS PROJECT.
- CONTRACTOR SHALL BE RESPONSIBLE TO IDENTIFY & PROTECT AND REPAIR ALL UNDERGROUND UTILITIES, INCLUDING ELECTRICAL, PLUMBING, SPRINKLERS, GAS SEWERS, AND STORM DRAINS WITHIN THE CONSTRUCTION SITE OR AREAS THAT THEY WORK IN. CONTRACTOR SHALL BE RESPONSIBLE TO SOLICIT THE SERVICES OF USA/DIG ALERT PRIOR TO AN EXCAVATION WORK.
- B. CONTRACTOR SHALL FIELD VERIFY ALL EXISTING CONDITIONS, DIMENSIONS, AND FLEVATIONS. ANY DISCREPANCIES SHALL BE CALLED TO THE ATTENTION OF THE DEPARTMENT OF PUBLIC WORKS AND BE RESOLVED PRIOR TO STARTING WORK. DO NOT SCALE DRAWINGS.
- ). THE CONTRACTOR SHALL BE RESPONSIBLE FOR COORDINATING THE WORK OF ALL TRADES. CONTRACTOR TO COORDINATE CIVIL, ARCHITECTURAL, ELECTRICAL, MECHANICAL AND PLUMBING REQUIREMENTS BEFORE CONSTRUCTION. ALL CONDITIONED SPACES SHALL COMPLY WITH "TITLE 24" STATE ENERGY CONSERVATION REQUIREMENTS. THE CONTRACTOR SHALL MAINTAIN FIRE ACCESS DURING CONSTRUCTION.
- 10. CONTRACTOR SHALL BE RESPONSIBLE FOR THE PUBLIC SAFETY AND FOR THE SAFETY OF THE BUILDING DURING CONSTRUCTION. THIS INCLUDES ALL NECESSARY SHORING, BRACING AND GUY WIRES WHICH SHALL CONFIRM TO ALL APPLICABLE SAFETY ORDINANCES. CONSULTANTS ARE AVAILABLE AT OSHA
- 11. CONTRACTOR SHALL MAINTAIN THE SITE CLEAN OF RUBBISH SO AS NOT TO IMPEDE THE ACCESS AND WORK OF OTHER TRADES. THE CONTRACTOR SHALL PROVIDED BARRICADE/TEMPORARY FENCING/WARNING SIGNS TO PROTECT THE PUBLIC OR WORKMEN DURING CONSTRUCTION. BARRICADES/TEMPORARY FENCING SHALL BE LEFT IN PLACE UNTIL AUTHORIZED BY THE DEPARTMENT TO BE REMOVED BY THE CONTRACTOR, AND AFTER THE BARRICADES/TEMPARARY FENCING IS NOT LONGER REQUIRED FOR PROTECTION.
- 12. ALL ADJACENT FACILITIES SHALL CONTINUE IN NORMAL OPERATION DURING THE PERIOD OF THE CONTRACT. THE CONTRACTOR SHALL CONDUCT HIS WORK IN SUCH A MANNER NOT TO RESTRICT OR OBSTRUCT ENTRANCES EXITS OR DISRUPT UTILITY SERVICES. THE CONTRACTOR SHALL PROVIDE TEMPORARY CONNECTIONS, LINES AND SERVICES TO THE LOS ANGELES
- 13. ALL AREAS AFFECTED OR DAMAGED BY ALTERATION, REMOVAL OF EXISTING CONSTRUCTION AND NEW WORK SHALL BE PATCHED AND REPAIRED TO MATCH EXISTING OR IN A SATISFACTORY MANNER APPROVED BY LOS ANGELES COUNTY PUBLIC WORKS. MATCH ADJACENT SIMILAR MATERIALS IN TEXTURE
- 14. SEPARATE BUILDING PERMITS SHALL BE TAKEN OUT FOR ELECTRICAL AND MECHANICAL PORTIONS. REQUIRED PERMITS SHALL BE OBTAINED FROM THE "STATE DIVISION OF INDUSTRIAL SAFETY" FOR ANY TRENCHES OR EXCAVATIONS 5 FEET OR MORE IN DEPTH INTO WHICH A PERSON IS REQUIRED TO DESCEND. SEPARATE PLANS SHALL BE PLAN CHECKED AND SEPARATE PERMITS SHALL BE OBTAINED FOR AUTOMATIC FIRE EXTINGUISHING SYSTEM AS
- 15. ALL WORK AND MATERIALS ARE NEW UNLESS OTHERWISE INDICATED. THE CONTRACT DOCUMENTS AND SPECIFICATIONS REPRESENT THE FINISHED STRUCTURE UNLESS OTHERWISE SHOWN. THEY DO NOT INDICATE THE METHOD OF CONSTRUCTION. CONTRACTOR SHALL SUPERVISE AND DIRECT THE WORK AND HE SHALL BE SOLELY RESPONSIBLE FOR ALL CONSTRUCTION MEANS, METHODS, TECHNIQUES, SEQUENCES AND PROCEDURES, INCLUDING BUT NOT LIMITED TO INSTALLATION OF ADEQUATE SHORING, BRACING, ETC., TO SAFELY EXECUTE ALL WORK.
- 16. DRAWINGS ARE DIVIDED INTO SEPARATE SHEETS FOR GENERAL CONVENIENCE ONLY. SHEET DESIGNATIONS OR NUMBERS SHALL NOT BE CONSIDERED TO LIMIT AREAS OF WORK, RESPONSIBILITY, OR TRADES. CONTRACTOR MUST COORDINATE THE DRAWINGS WITH EACH OTHER AND WITH PROJECT MANUAL IN ORDER TO COMPLETE THE PROJECT AS DESIGNED.
- 17. DIMENSIONS OF STUD WALLS ARE TO CENTERLINE OF STUDS UNLESS OTHERWISE NOTED. ALL DIMENSIONS ARE TO CENTER LINE OF COLUMNS UNLESS NOTED OTHERWISE. CONCRETE IS DIMENSIONED TO FACE OF WALL. CMU DIMENSIONS ARE TO CENTERLINE OF MORTAR JOINTS UNLESS OTHERWISE NOTED. FOR EXACT OVERALL WALL DIMENSIONS SUBTRACT ONE MORTAR JOINT. FOR EXACT WALL OPENING DIMENSION ADD ONE MORTAR JOINT TO BOTH WIDTH AND HEIGHT. VERTICAL DIMENSIONS FROM FINISH FLOOR LINE ARE TO TO TOP OF UNIT UNLESS OTHERWISE NOTED.
- 18. TYPICAL DETAILS AND GENERAL NOTES APPLY TO ALL PARTS OF THE JOB, EXCEPT WHERE THEY CONTRADICT WITH DETAILS NOTES SPECIFIED ON OTHER SHEETS. ALL INFORMATION SHOWN ON THE DRAWINGS RELATIVE TO EXISTING CONDITIONS IS GIVEN AS BEST AS POSSIBLE, BUT WITHOUT GUARANTEE OF ACCURACY. WHERE ACTUAL CONDITIONS CONFLICT WITH THE DRAWINGS, THEY SHALL BE REPORTED TO LOS ANGELES COUNTY PUBLIC WORKS ARCHITECTS SO THAT THE PROPER REVISIONS MAY BE MADE. MODIFICATIONS OF DETAILS OF CONSTRUCTION SHALL NOT BE MADE WITHOUT WRITTEN APPROVAL OF LOS ANGELES COUNTY PUBLIC WORKS ARCHITECTS. WHERE NO SPECIFIC DETAIL IS SHOWN, THE FRAMING OR CONSTRUCTION SHALL BE IDENTICAL OR SIMILAR TO THAT FOR LIKE CASES OF CONSTRUCTION ON THIS PROJECT, AND BE SUBJECT TO REVIEW AND APPROVAL BY LA COUNTY PUBLIC WORKS (PW)

# **CAMP GLENN ROCKEY** SECURITY UPGRADES CONTRACT NO. PW15739 PCA: P9700226 PCS ID:00002237

# 1900 SYCAMORE ROAD, SAN DIMAS, CA 91773

## APPLICABLE CODES PROJECT SUMMARY BUILDING OCCUPANCY: I - 3 BUILDING CODES: CALIFORNIA BUILDING CODE, 2022 EDITION JUVENILE DETENTION CENTER BUILDING USE: W/ 2023 COUNTY OF LOS ANGELES BUILDING CODE (TITLE 26) (W/ 2023 COUNTY OF LOS ANGELES AMENDMENTS FULLY CONSTRUCTION INTEGRATED INTO 2022 CALIFORNIA BUILDING CODE) YPE I —A (NON—FIRE SPRINKLER CALIFORNIA MECHANICAL CODE, 2022 EDITION CALIFORNIA ELECTRICAL CODE, 2022 EDITION CALIFORNIA PLUMBING CODE, 2022 EDITION CALIFORNIA ENERGY CODE, 2022 EDITION CALIFORNIA GREEN BLDG. STANDARDS CODE, 2022 EDITION OUTDOOR SECURITY BOOTH AREA OF WORK: APPROX. 45 SQ.FT. TYPE V-B CONSTRUCTION OUTDOOR ENGINE GENERATOR APPROX. <u>275 SQ.FT.</u> INSTALLATION OF AUTOMATIC TRANSFER SWITCH AT PUMP ROOM PARKING: NEW VAN ACCESSIBILITY ADA PARKING STALLS NEW ACCESSIBLE LOADING AREAS FOR ADA PARKING STALLS **SITE PLAN REVIEW** PERMIT #: RPPL2024004753

PROJECT #: PRJ2024-003210

APPROVAL DATE

CALVADA SURVEYING, INC.

ATTN.: ARMANDO DUPONT

AV/IT/SECURITY CONSULTANT

12970 BRNAFORD ST, UNIT F

ATTN.: JOE ALABASHYAN

TEL.: 818-630-5755

<u>CIVIL ENGINEER</u>

INNOVAVE

CORONA, CA 92878

TEL: 951-280-9960

ARLETA, CA 91331

**DIRECTORY** 

OWNER'S REPRESENTATIVE

900 S. FREMONT AVENUE

ALHAMBRA, CA 91803

TEL: 626-300-3246

JTC ARCHITECTS, INC.

ARCADIA, CA 91006

TEL: 626-254-8884

STRUCTURAL ENGINEER

LONG BEACH, CA 90808

FAX: 562-985-3200

ELECTRICAL ENGINEERS

150 S. ARROYO PARKWAY,

ATTN.: DEREK WEI (ELEC.)

TEL.: 626-445-8580

STE. 100 PASADENA, CA 91105

3900 COVER STREET

ATTN.: RICK BEALL

MECHANICAL/

dHA+CALPEC

ATTN.: JUNE QUEK

65 N. FIRST AVE., STE. 201

ATTN.: CHAM WADU

**ARCHITECT** 

PROJECT MANAGEMENT DIVISION II

LOS ANGELES COUNTY

PUBLIC WORKS

Approved by: Larry Jaramillo This plan is APPROVED in compliance with the Los Angeles County Zoning Code and subject to the requirements noted herein. This approval shall Demolition work is approved as shown on the plans. expire if it is not used within two years of the approval date and prior to any

change in ordinance requirements. This approval shall not be construed to permit the violation of any provision of the Los Angeles County Code or State or Federal Law. **Larry Jaramillo** SIGNATURE


This is not a building permit. EXPIRATION DATE

PERMIT APPLICATION INVOLVES CONSTRUCTING CONCRETE FOUNDATION FOR A PREFABRICATED SECURITY BOOTH AND REQUIRED POWER. PROVIDE ENGINE GENERATOR FOR EXISTING BOOSTER WATER PUMPS WITH ALL ASSOCIATED POWER SUPPORTS AND CONCRETE FOUNDATION SUPPORT. INSTALL NEW PROVIDE LOW VOLTAGE CONNECTION SYSTEM FOR SECURITY COMMUNICATION BETWEEN NEW SECURITY BOOTH AND MAIN ADMINISTRATION BUILDING. INSTALI

RECONFIGURE (E) HANDICAP PARKING STALLS IN FRONT FOR THE MAIN BUILDING TO INCLUDE THE REQUIRED VAN ACCESSIBILITY PARKING STALL PER ADA CODES

PATCH AND REPAIR AFFECTED ASPHALT PAVING. FINISH SITE PARKING AREA WITH NEW SLURRY COATINGS AND PARKING STRIPINGS

**SCOPE OF WORK** 

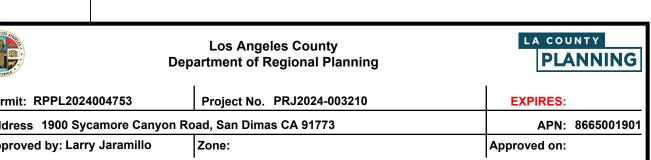

This is a County project on a County-owned property located within the City of San Dimas. The Department of Public Works completed and cleared a Conceptual Review of this project. Pursuant to sovereign immunity, the above referenced project approves the installation of a new prefabricated security

CHAINLINK FENCE FOR OUTDOOR ENGINE GENERATOR

NEW CAMERA ON POST FOR SECURITY

both on a new foundation, and a new engine generator for the existing booster water pumps. The new security booth is approved for a maximum height of 8'-5". A new 9'-6" high chain link fence will be installed for the outdoor engine generator. The existing handicap parking stalls in front of the main building will be reconfigured to include a new van

The asphalt paving of the existing parking lot will be patched and repaired with a new slurry coating. The parking paces of the affected parking area will be restriped to provide the same number of parking stalls as previously provided. A total of 52 standard parking spaces, two ADA spaces, and one van accessible parking space will be provided.

Informational signage is approved as shown on the plans. No grading proposed and none approved.

ADA requirements must be to the satisfaction of Building & Safety/Public Works. Obtain approvals from Building & Safety prior to construction activity.

PROJECT SITE

No oak tree encroachments are proposed. Lighting on the subject property shall be so arranged to prevent glare or direct illumination in any residential property. In no case shall a lighted sign or lighting device thereof be so placed or directed so as to permit the beams and umination therefrom to be directed or beamed upon a public street, highway, sidewalk or adjacent premises so as to

**VICINITY MAP** 

NOT TO SCALE

cause glare or reflection that may constitute a traffic hazard or nuisance.

. GENERAL NOTES, BUILDING SUMMARY, VICINITY MAP. DIRECTORY, DRAWING INDEX, SCOPE OF WORK, AND LEGAL DESCRIPTION 000000 C-1.01 TOPOGRAPHIC SURVEY **ARCHITECTURAL** A-0.00 OVERALL SITE PLAN - SHOWING AREA OF WORK PARTIAL SITE PLANS PARTIAL SITE PLAN SECURITY BOOTH AND ADA PARKING STALLS-DEMO PARTIAL SITE PLAN SECURITY BOOTH AND ADA PARKING STALLS-NEW PARTIAL ENLARGED SITE PLANS - NEW WORK PARTIAL ENLARGED SITE PLANS ENGINE GENERATOR-DEMO AND NEW A-1.05 ENLARGED PUMP HOUSE FLOOR PLAN - NEW A-1.06 SITE DETAILS SECTION AND ELEVATIONS - SECURITY BOOTH ECTION AND ELEVATIONS — ENGINE GENERATOR RCUTURAL NOTES AND ABBREVIATIONS STRCUTURAL NOTES AND ABBREVIATIONS S-2.00 PARTIAL SITE PLAN S-4.00 TYPICAL FOUNDATION DETAILS EQUIPMENT ANCHORAGE DETAILS EGENDS AND NOTES SINGLE LINE DIAGRAMS PANEL SCHEDULES PARTIAL POWER PLAN - CAMP GLENN ROCKEY PARTIAL POWER PLAN - PUMP BUILDING TITLE SHEET SITE PLAN PARTIAL SITE PLAN SE-04 SECURITIES BOOTH PLAN SE-05 DETAILS CURITY BOOTH FROM MANUFACTURER (FOR REFERENCE ONLY COVER PAGE LEVATIONS E1 AND E2 EVATIONS E3 AND E4 OOR PLAN STUB AREA AND ANCHOR PLAN ECTRICAL NOTES AND PLAN OOR FRAMING PLAN ROOF SECTION DETAILS GENERAL NOTES

**SPEC 7879** 

BUILDING PLAN CHECK

APPLICATION NUMBER

BLDC240417000421

**DRAWING INDEX** 

ISSUE DATE

DRAWING NUMBER AND TITLE

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LOS ANGELES COUNTY PUBLIC WORKS 900 SOUTH FREMONT AVE. ALHAMBRA, CA 91803

PROJECT

**CAMP GLENN ROCKEY SECURITY UPGRADES** 

LOCATION :

1900 N. SYCAMORE ROAD. SAN DIMAS, CA 91773

ARCHITECT

::::::JTC architects, inc.

65 N. 18T AVENUE, SUITE 201 ARCADIA, CA 91006

626-254-8884 E:info@jtcarch.com

JTC PROJECT NO: 37606.0D

CONSULTANT

TITLE SHEET

AS NOTED 6-10-24 DRAWN BY: JTC CHECKED BY: JTC SHEET NUMBER:

**T-1** 

**LEGAL DESCIPTION** 

TO A PT S O 02' W 405 FT FROM NW COR OF LOT 16 WESTERN WATER AND POWER CO'S TR TH NO 02' E 412.47 FT TH N 89 49'

10.09 FT. TH N 0 18' E 2620.48 FT TH S 89 15'50" W 2606.34

411 JENKS CIRCLE, SUITE 205 ADDRESS: 1900 SYCAMORE CANYON RD., SAN DIMAS CA 91773-1220


> PROPERTY BOUNDARY DESCRIPTION: THAT PARCEL (EX OF ST) IN SAN DIMAS CITY LTG DIST ZONE B OF LOT COM AT NW COR OF SEC 35 T IN R 9W TH S ON W LINE OF SD SEC 1305.15 FT. TH N 89 27'25" E TO E LINE OF SYCAMORE CYN. RD. TH S AND FOLLOWING SD RD TO SW LINE OF LAND DESC IN DDS 3922-283 TO L A CO TH SE THEREON


FT TO BEG PARTOF W 1/2 OF SEC 35 T IN R 9W


ASSESSOR'S ID NO.: 8665-001-901

TOPOGRAPHIC SURVEY

GLENN ROCKEY CAMP SCHOOL 1900 SYCAMORE CANYON ROAD, SAN DIMAS, CA 91773

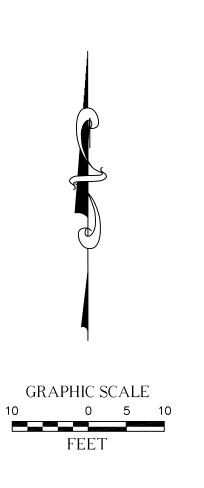

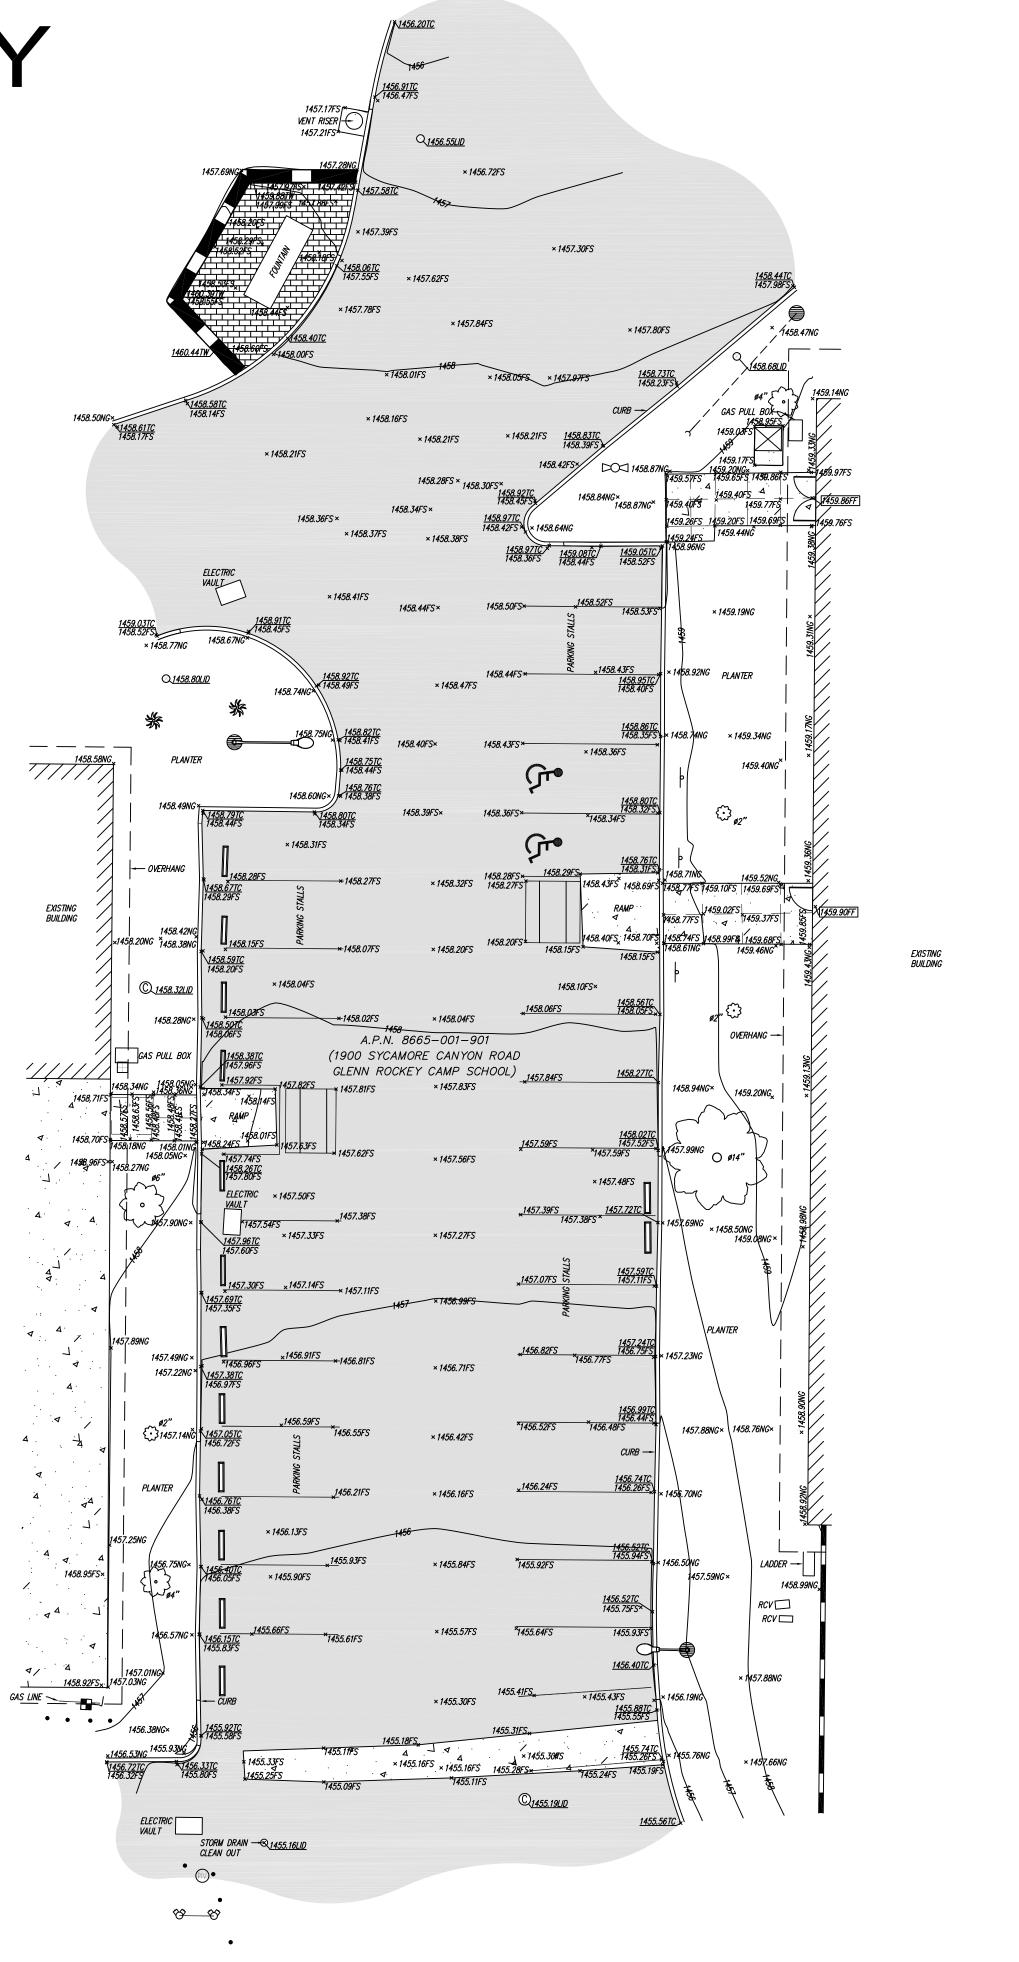

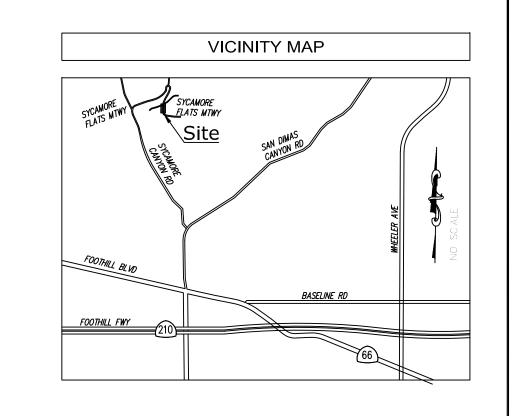

LEG	END
$\boxtimes$	AIR CONDITIONING UNIT
	ASPHALT PAVEMENT
	CAR STOP
3/45/2	CONCRETE PAVEMENT
▲	CONTROL POINT
	DECORATIVE BRICK
$\Box$	DOOR
♡	FIRE DEPARTMENT CONNECTION
	FIRE HYDRANT
	GAS METER
•	GUARD POST
	GUY WIRE
<u>د</u> *	HANDICAP
*	PALM TREE
	POST INDICATOR VALVE
©	SEWER CLEAN OUT
S	SEWER MANHOLE
<del></del>	SIGN
	STREET LIGHT
₿	TREE (TYPICAL)
	UTILITY POLE
	WATER METER
$\otimes$	WATER VALVE
APN	ASSESSOR'S PARCEL NUMBER
Ø	DIAMETER OF EXISTING TREE
FF	FINISH FLOOR
FS	FINISH SURFACE
NG	NATURAL GROUND
TC	TOP OF CURB
Τ₩	TOP OF WALL
	BLOCK WALL
	OVERHANG


**SPEC 7879** 

BUILDING PLAN CHECK APPLICATION NUMBER:
BLDC240417000421

DATE: 6-10-24

C-1.01

REVISIONS		UTILITY STATEMENT	PREPARED FOR	BASIS OF COORDINATES	BENCHMARK	SITE INFORMATION	SURVEYOR OF RECORD	FIELD COMPLETION DATE: APRIL 21, 2023
NO. DATE REVISIONS	S BY	BURIED UTILITIES AND/OR PIPELINES SHOWN HEREON ARE PER VISIBLE AND APPARENT SURFACE EVIDENCE, RECORD	JTC Architects	THE COORDINATES SHOWN HEREON ARE BASED UPON THE CALIFORNIA COORDINATE SYSTEM OF 1983, CCS83, ZONE 5 (2018.00) IN ACCORDANCE TO THE CALIFORNIA PUBLIC RESOURCES CODE SECTIONS 8801-8819; SAID COORDINATES AR	ANGELES COUNTY BENCHMARK NG5339, ELEVATION		CALVADA	
0 05/02/23 SUBMITTAL	\L VG	DRAWINGS OF THE CONSTRUCTED UTILITY LINES OBTAINED FROM RELIABLE AND RESPONSIBLE SOURCES NOT Underground Service Alert	65 N. 1ST AVENUE, SUITE 201 ARCADIA, CA 91006	DETERMINED LOCALLY UPON FIELD-OBSERVED TIES TO THE FOLLOWING LEICA SMARTNET NORTH AMERICA (S.N.N.A. CONTINUOUSLY OPERATING REFERENCE STATIONS (C.O.R.S.):	) 1073.07 FEET (NAVD 88).	LOS ANGELES, CA 91773		
		CONNECTED WITH CALVADA SURVEYING, INC. OR MARKINGS PROVIDED BY AN INDEPENDENT LOCATING CONTRACTOR. NO GUARANTEF OR WARRANTY, FITHER EXPRESSED OR IMPLIFD.  CLIARANTEF OR WARRANTY, FITHER EXPRESSED OR IMPLIFD.	PHONE: (626) 254-8884		LACO BM TAG IN N CB SAN DIMAS CYN RD 3' W/O END C B 43' N/O C/L & 43' E/O C/L SYCAMORE	ASSESSOR'S PARCEL NO.: 8665-001-901	SURVEYII	_
		IS MADE AS TO THE ACCURACY OR THOROUGHNESS OF SUCH INFORMATION. IF MORE ACCURATE LOCATIONS OF $1-800$		NORTHING = 1869156.79' EASTING = 6614016.57'  S.N.N.A. CANC:	CYN RD	·	411 Jenks Circle, Suite 2 Phone: 951-280-9960	205, Corona, CA 92878 Fax: 951-280-9746
		UNDERGROUND UTILITIES OR PIPE LINES ARE REQUIRED, THE UTILITY OR PIPELINE WILL HAVE TO BE VERIFIED BY FIELD  TWO WORKING DAYS		NORTHING = 1800791.49' EASTING = 6537285.30'			Toll Free: 800-CALVADA	www.calvada.com
		POTHOLING. CALVADA SURVEYING, INC. AND THE SURVEYOR OF RECORD SHALL NOT BE HELD LIABLE FOR THE LOCATION OF OR THE FAILURE TO NOTE THE LOCATION OF					EST. 1989	JOB NO. 23215-PW
		NON-VISIBLE UTILITIES OR PIPELINES.					Armando D. DuPont Registration No. 7780	SHEET 1 OF 1

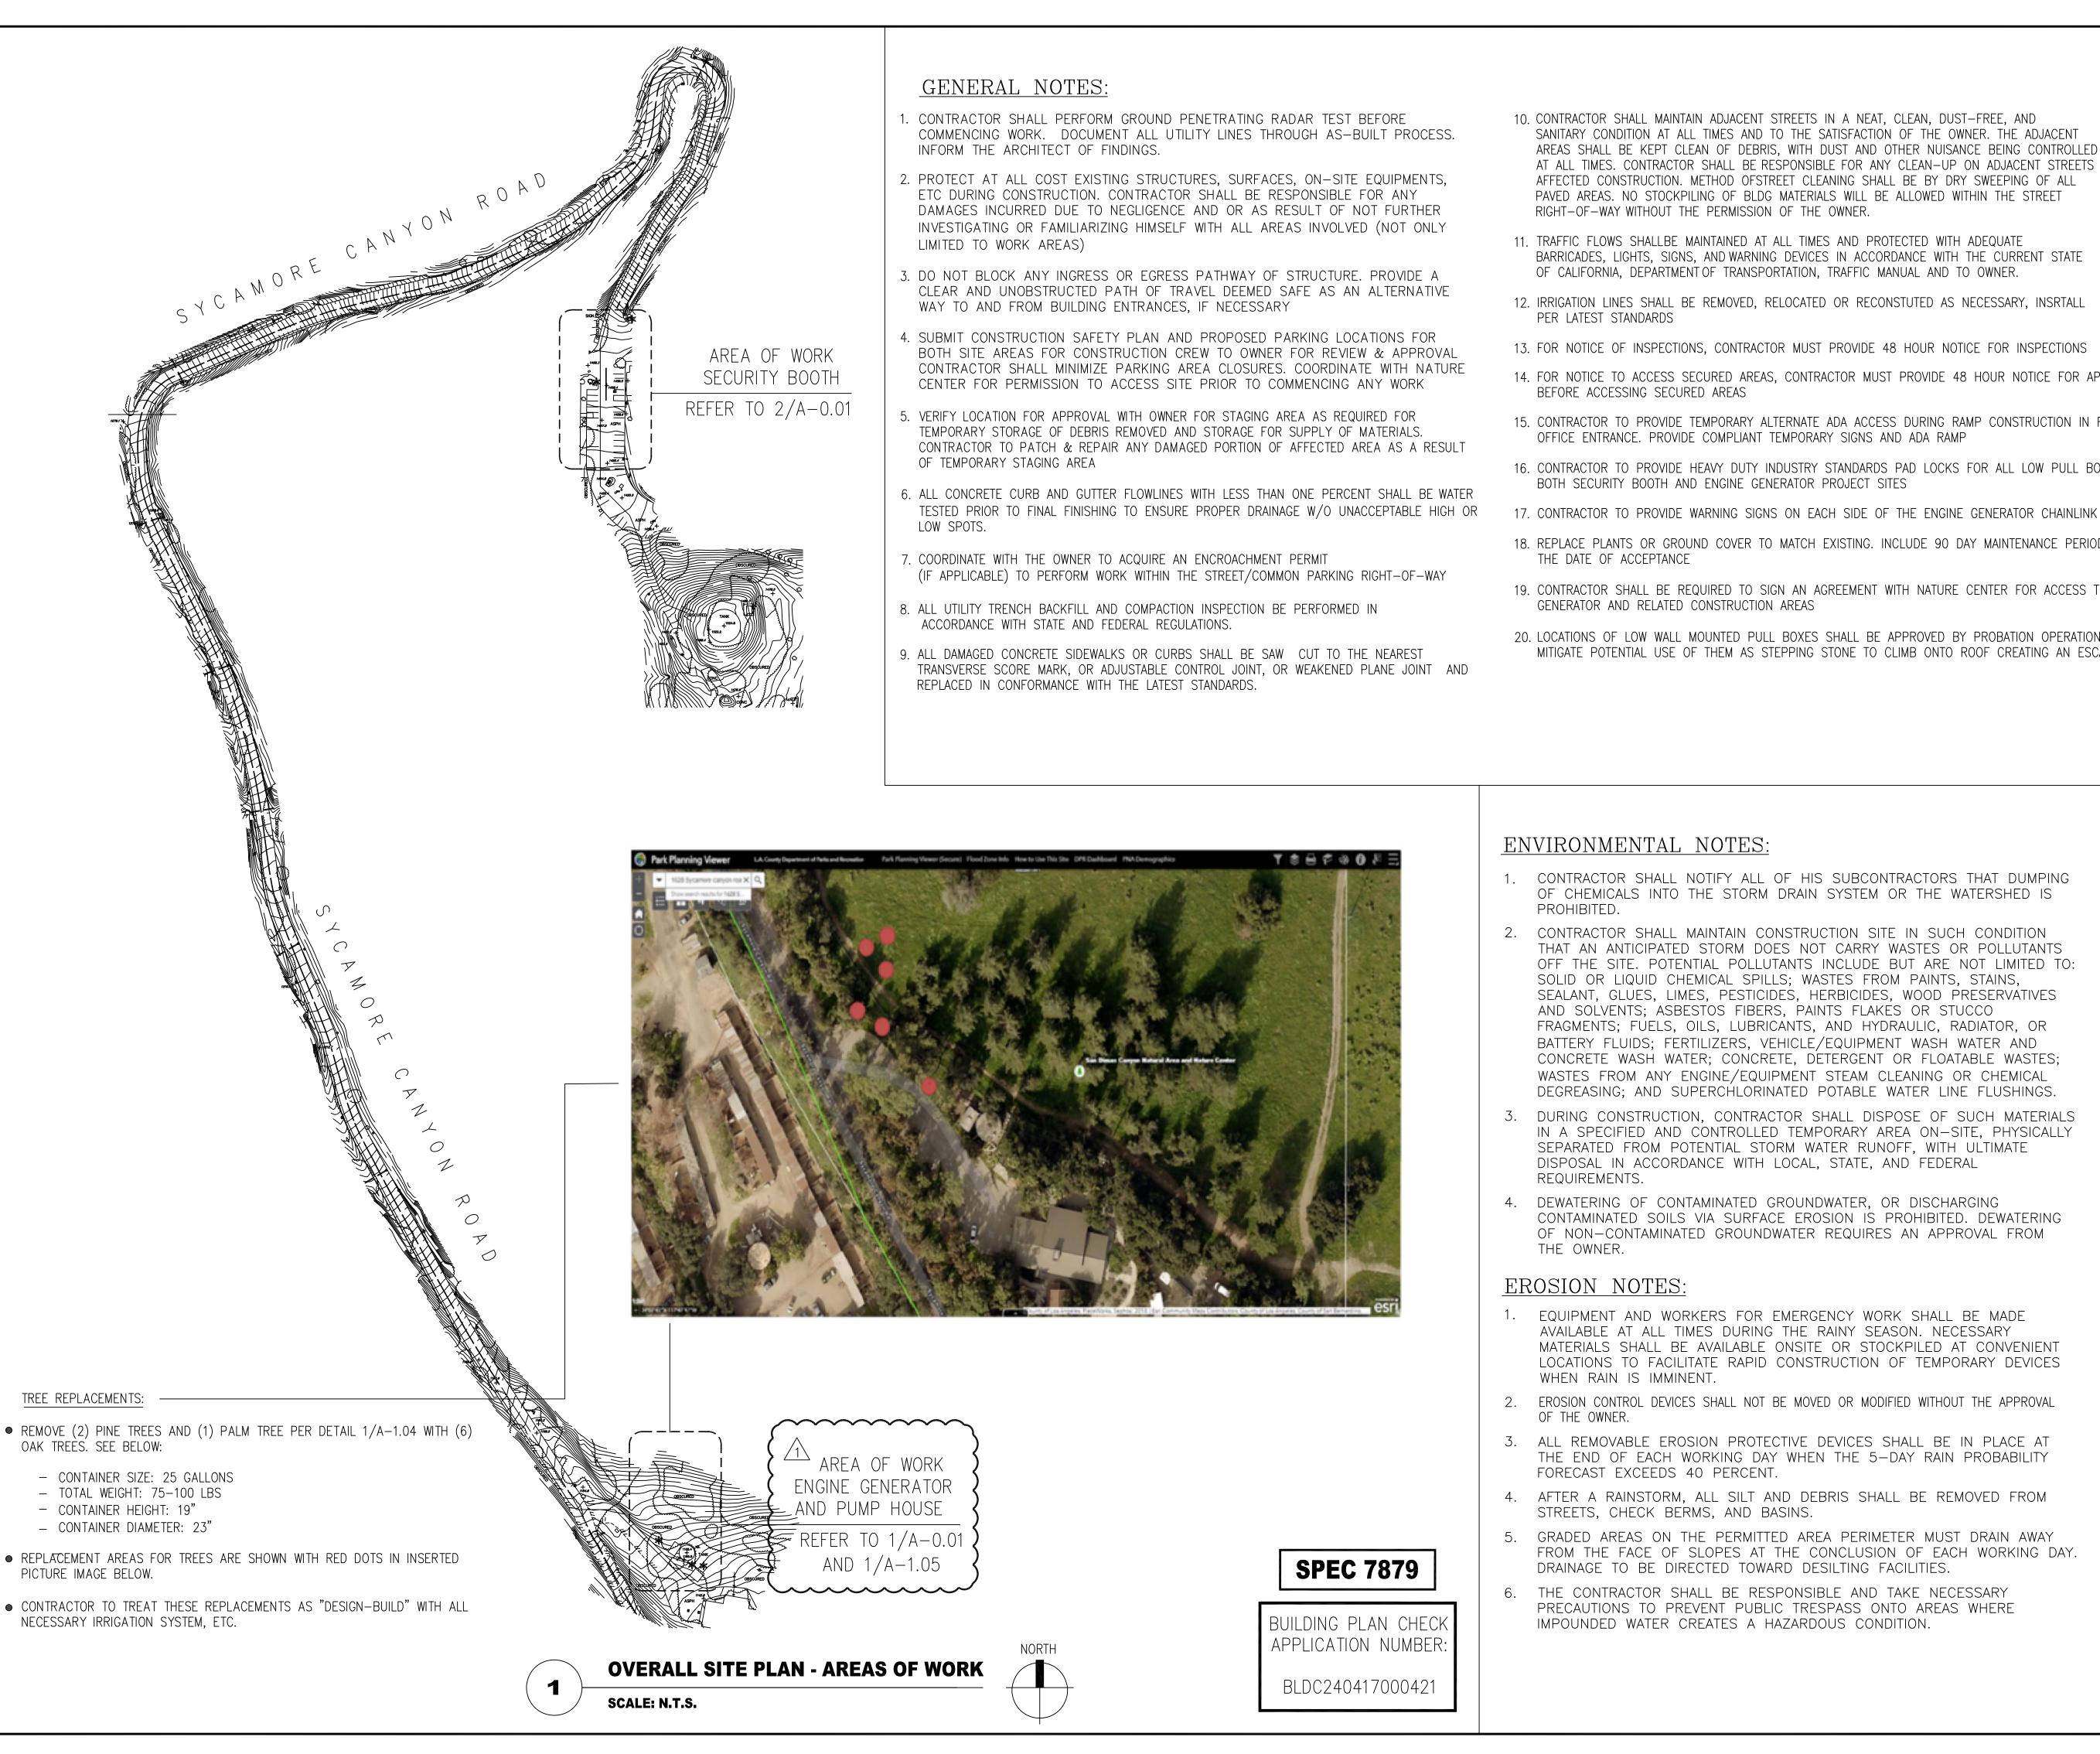

AT ALL TIMES. CONTRACTOR SHALL BE RESPONSIBLE FOR ANY CLEAN-UP ON ADJACENT STREETS AFFECTED CONSTRUCTION. METHOD OFSTREET CLEANING SHALL BE BY DRY SWEEPING OF ALL PAVED AREAS. NO STOCKPILING OF BLDG MATERIALS WILL BE ALLOWED WITHIN THE STREET RIGHT-OF-WAY WITHOUT THE PERMISSION OF THE OWNER.

11. TRAFFIC FLOWS SHALLBE MAINTAINED AT ALL TIMES AND PROTECTED WITH ADEQUATE BARRICADES, LIGHTS, SIGNS, AND WARNING DEVICES IN ACCORDANCE WITH THE CURRENT STATE OF CALIFORNIA, DEPARTMENT OF TRANSPORTATION, TRAFFIC MANUAL AND TO OWNER.

- 12. IRRIGATION LINES SHALL BE REMOVED, RELOCATED OR RECONSTUTED AS NECESSARY, INSRTALL PER LATEST STANDARDS
- 13. FOR NOTICE OF INSPECTIONS, CONTRACTOR MUST PROVIDE 48 HOUR NOTICE FOR INSPECTIONS
- 14. FOR NOTICE TO ACCESS SECURED AREAS, CONTRACTOR MUST PROVIDE 48 HOUR NOTICE FOR APPROVAL BEFORE ACCESSING SECURED AREAS
- 15. CONTRACTOR TO PROVIDE TEMPORARY ALTERNATE ADA ACCESS DURING RAMP CONSTRUCTION IN FRONT OF OFFICE ENTRANCE. PROVIDE COMPLIANT TEMPORARY SIGNS AND ADA RAMP
- 16. CONTRACTOR TO PROVIDE HEAVY DUTY INDUSTRY STANDARDS PAD LOCKS FOR ALL LOW PULL BOXES FOR BOTH SECURITY BOOTH AND ENGINE GENERATOR PROJECT SITES
- 17. CONTRACTOR TO PROVIDE WARNING SIGNS ON EACH SIDE OF THE ENGINE GENERATOR CHAINLINK FENCE
- 18. REPLACE PLANTS OR GROUND COVER TO MATCH EXISTING. INCLUDE 90 DAY MAINTENANCE PERIOD FROM THE DATE OF ACCEPTANCE
- 19. CONTRACTOR SHALL BE REQUIRED TO SIGN AN AGREEMENT WITH NATURE CENTER FOR ACCESS TO THE GENERATOR AND RELATED CONSTRUCTION AREAS
- 20. LOCATIONS OF LOW WALL MOUNTED PULL BOXES SHALL BE APPROVED BY PROBATION OPERATIONS TO MITIGATE POTENTIAL USE OF THEM AS STEPPING STONE TO CLIMB ONTO ROOF CREATING AN ESCAPE PATH.

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LOS ANGELES COUNTY PUBLIC WORKS 900 SOUTH FREMONT AVE. ALHAMBRA, CA 91803

**CAMP GLENN ROCKEY SECURITY UPGRADES** 

LOCATION :

1900 N. SYCAMORE ROAD, SAN DIMAS, CA 91773

ARCHITECT

::::::JTC

65 N. 18T AVENUE, SUITE 201 ARCADIA, CA 91006

626-254-8884 E:info@jtcarch.com

JTC PROJECT NO: 37606.0D

CONSULTANT:

**OVERALL SITE PLAN AREAS OF WORK** 

AS NOTED 6-10-24 DRAWN BY: JTC CHECKED BY: JTC

> SHEET NUMBER: **A-0.00**

CONTRACTOR SHALL NOTIFY ALL OF HIS SUBCONTRACTORS THAT DUMPING OF CHEMICALS INTO THE STORM DRAIN SYSTEM OR THE WATERSHED IS PROHIBITED.


CONTRACTOR SHALL MAINTAIN CONSTRUCTION SITE IN SUCH CONDITION THAT AN ANTICIPATED STORM DOES NOT CARRY WASTES OR POLLUTANTS OFF THE SITE. POTENTIAL POLLUTANTS INCLUDE BUT ARE NOT LIMITED TO: SOLID OR LIQUID CHEMICAL SPILLS; WASTES FROM PAINTS, STAINS, SEALANT, GLUES, LIMES, PESTICIDES, HERBICIDES, WOOD PRESERVATIVES AND SOLVENTS; ASBESTOS FIBERS, PAINTS FLAKES OR STUCCO FRAGMENTS; FUELS, OILS, LUBRICANTS, AND HYDRAULIC, RADIATOR, OR BATTERY FLUIDS; FERTILIZERS, VEHICLE/EQUIPMENT WASH WATER AND CONCRETE WASH WATER; CONCRETE, DETERGENT OR FLOATABLE WASTES; WASTES FROM ANY ENGINE/EQUIPMENT STEAM CLEANING OR CHEMICAL DEGREASING; AND SUPERCHLORINATED POTABLE WATER LINE FLUSHINGS.


3. DURING CONSTRUCTION, CONTRACTOR SHALL DISPOSE OF SUCH MATERIALS IN A SPECIFIED AND CONTROLLED TEMPORARY AREA ON-SITE, PHYSICALLY SEPARATED FROM POTENTIAL STORM WATER RUNOFF, WITH ULTIMATE DISPOSAL IN ACCORDANCE WITH LOCAL, STATE, AND FEDERAL REQUIREMENTS.

4. DEWATERING OF CONTAMINATED GROUNDWATER, OR DISCHARGING CONTAMINATED SOILS VIA SURFACE EROSION IS PROHIBITED. DEWATERING OF NON-CONTAMINATED GROUNDWATER REQUIRES AN APPROVAL FROM THE OWNER.

# **EROSION NOTES:**

- 1. EQUIPMENT AND WORKERS FOR EMERGENCY WORK SHALL BE MADE AVAILABLE AT ALL TIMES DURING THE RAINY SEASON. NECESSARY MATERIALS SHALL BE AVAILABLE ONSITE OR STOCKPILED AT CONVENIENT LOCATIONS TO FACILITATE RAPID CONSTRUCTION OF TEMPORARY DEVICES WHEN RAIN IS IMMINENT.
- 2. EROSION CONTROL DEVICES SHALL NOT BE MOVED OR MODIFIED WITHOUT THE APPROVAL OF THE OWNER.
- 3. ALL REMOVABLE EROSION PROTECTIVE DEVICES SHALL BE IN PLACE AT THE END OF EACH WORKING DAY WHEN THE 5-DAY RAIN PROBABILITY FORECAST EXCEEDS 40 PERCENT.
- 4. AFTER A RAINSTORM, ALL SILT AND DEBRIS SHALL BE REMOVED FROM STREETS, CHECK BERMS, AND BASINS.
- 5. GRADED AREAS ON THE PERMITTED AREA PERIMETER MUST DRAIN AWAY FROM THE FACE OF SLOPES AT THE CONCLUSION OF EACH WORKING DAY. DRAINAGE TO BE DIRECTED TOWARD DESILTING FACILITIES.
- 6. THE CONTRACTOR SHALL BE RESPONSIBLE AND TAKE NECESSARY PRECAUTIONS TO PREVENT PUBLIC TRESPASS ONTO AREAS WHERE IMPOUNDED WATER CREATES A HAZARDOUS CONDITION.

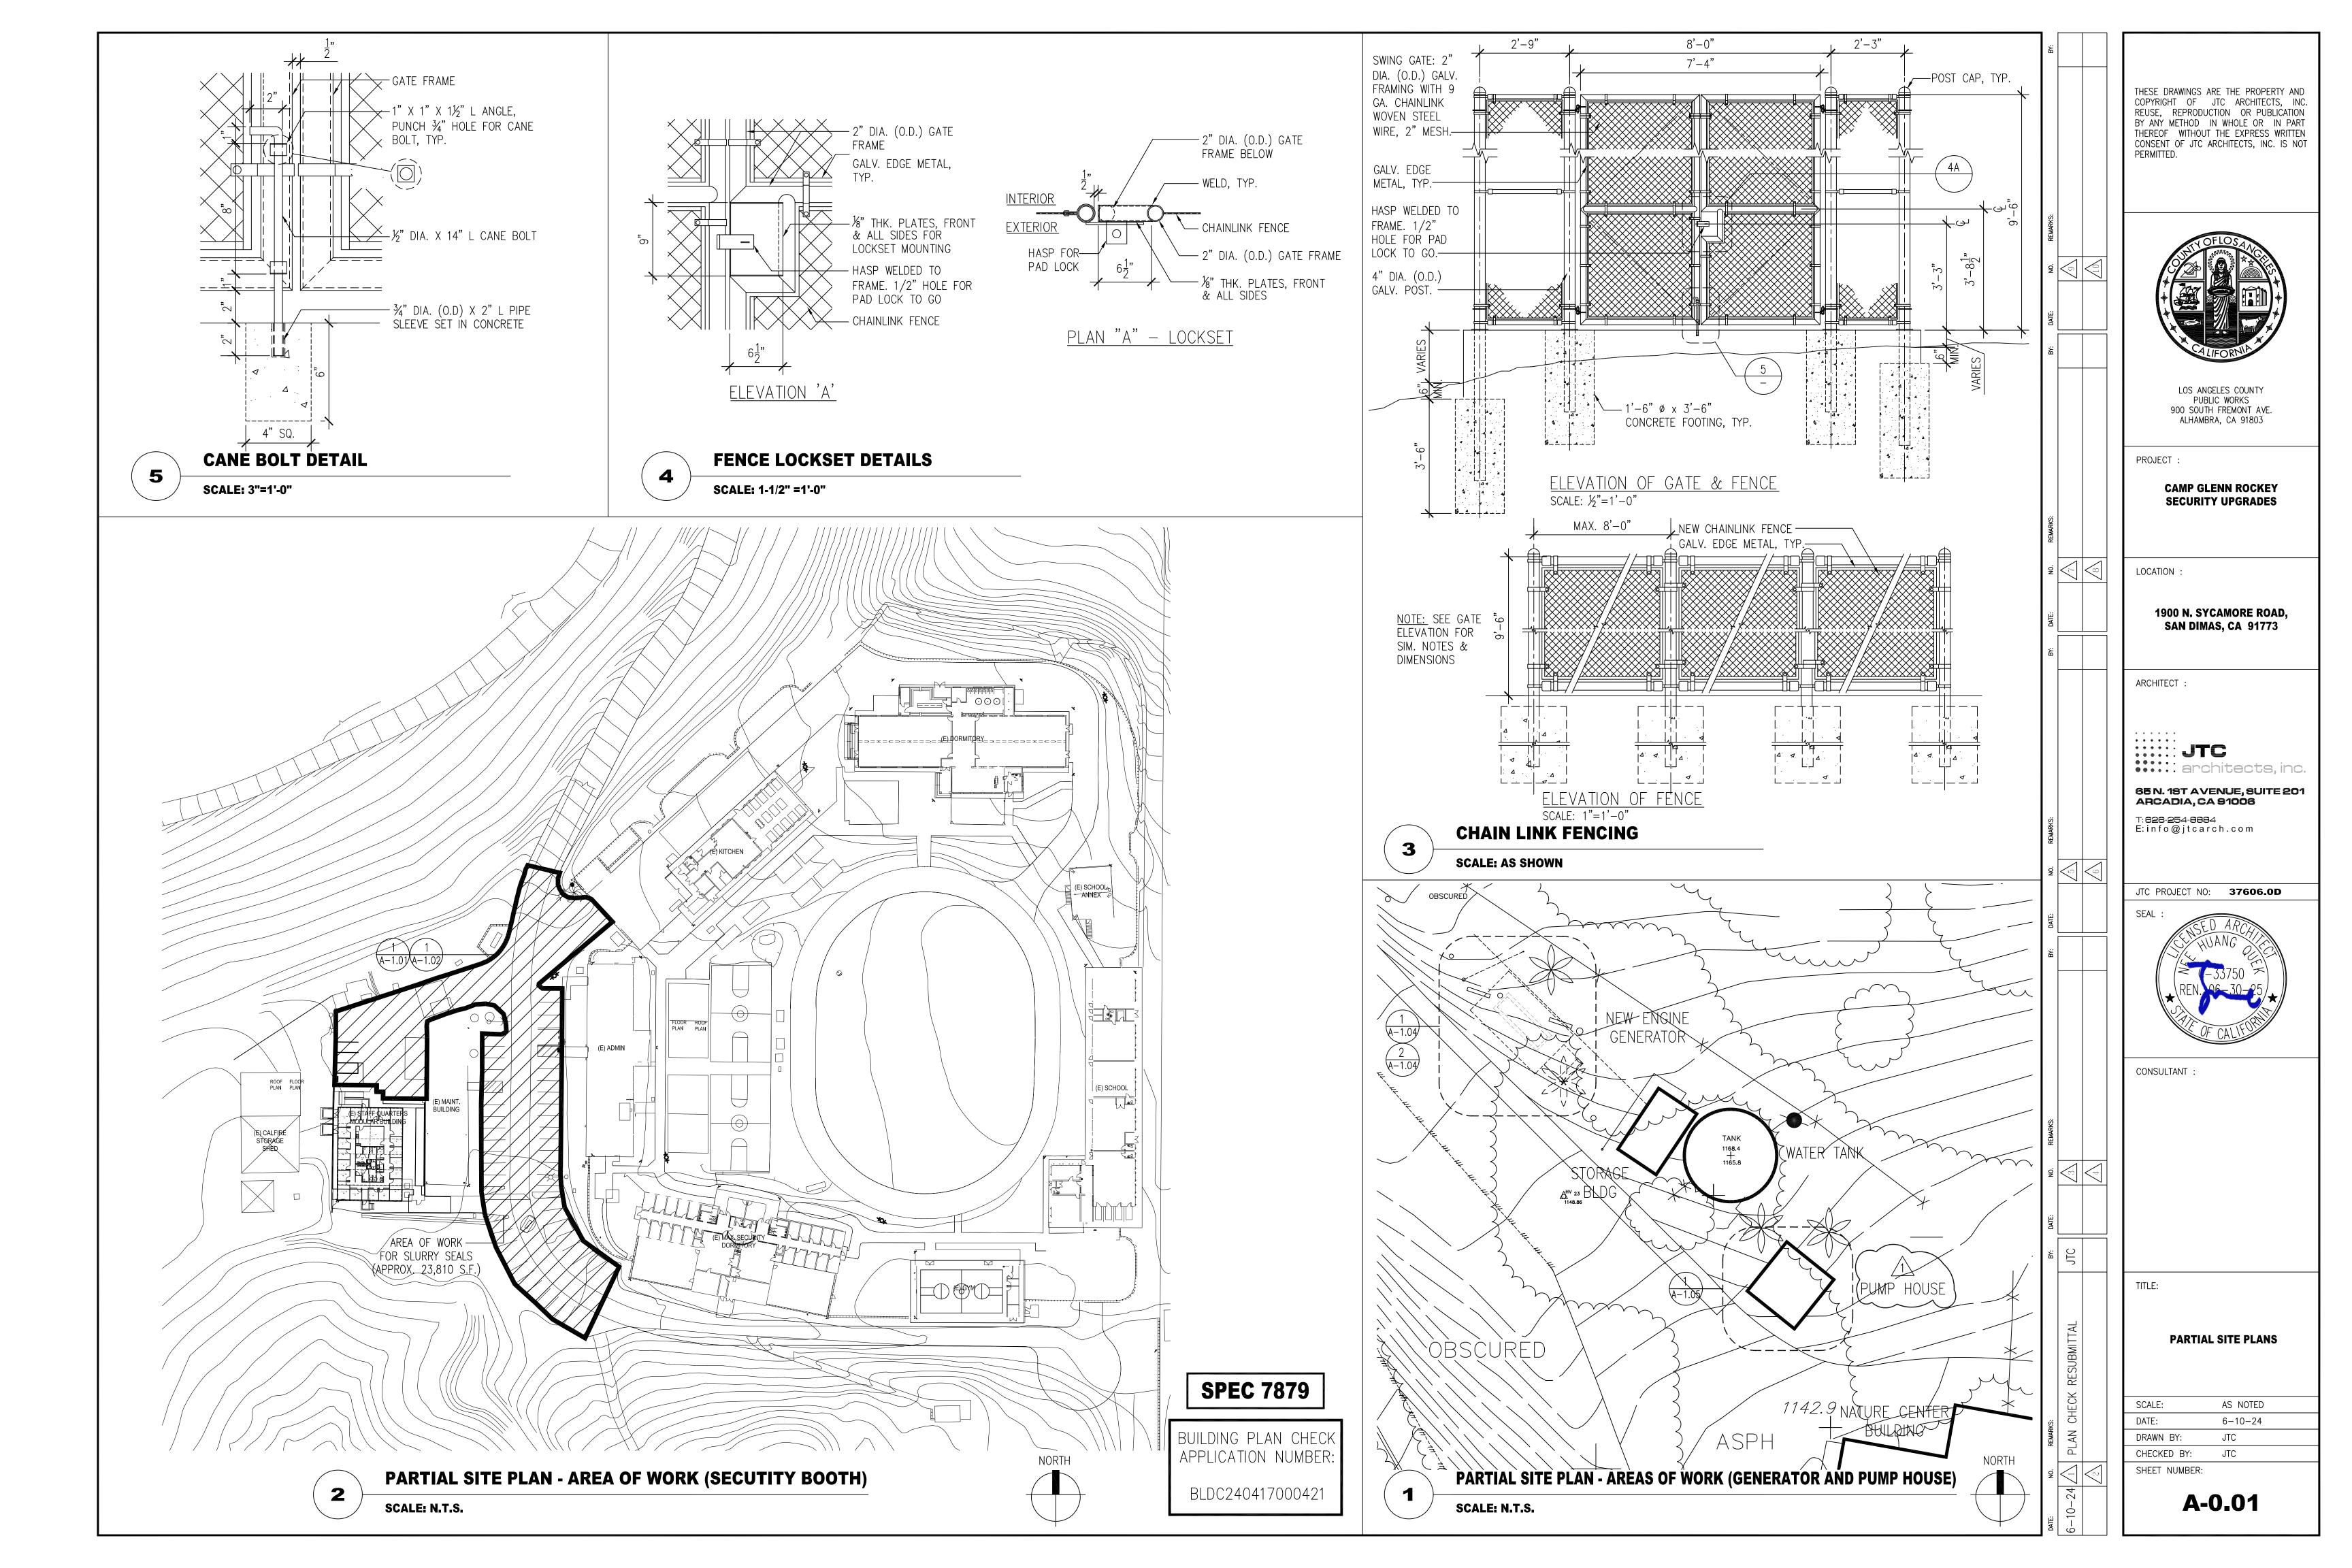

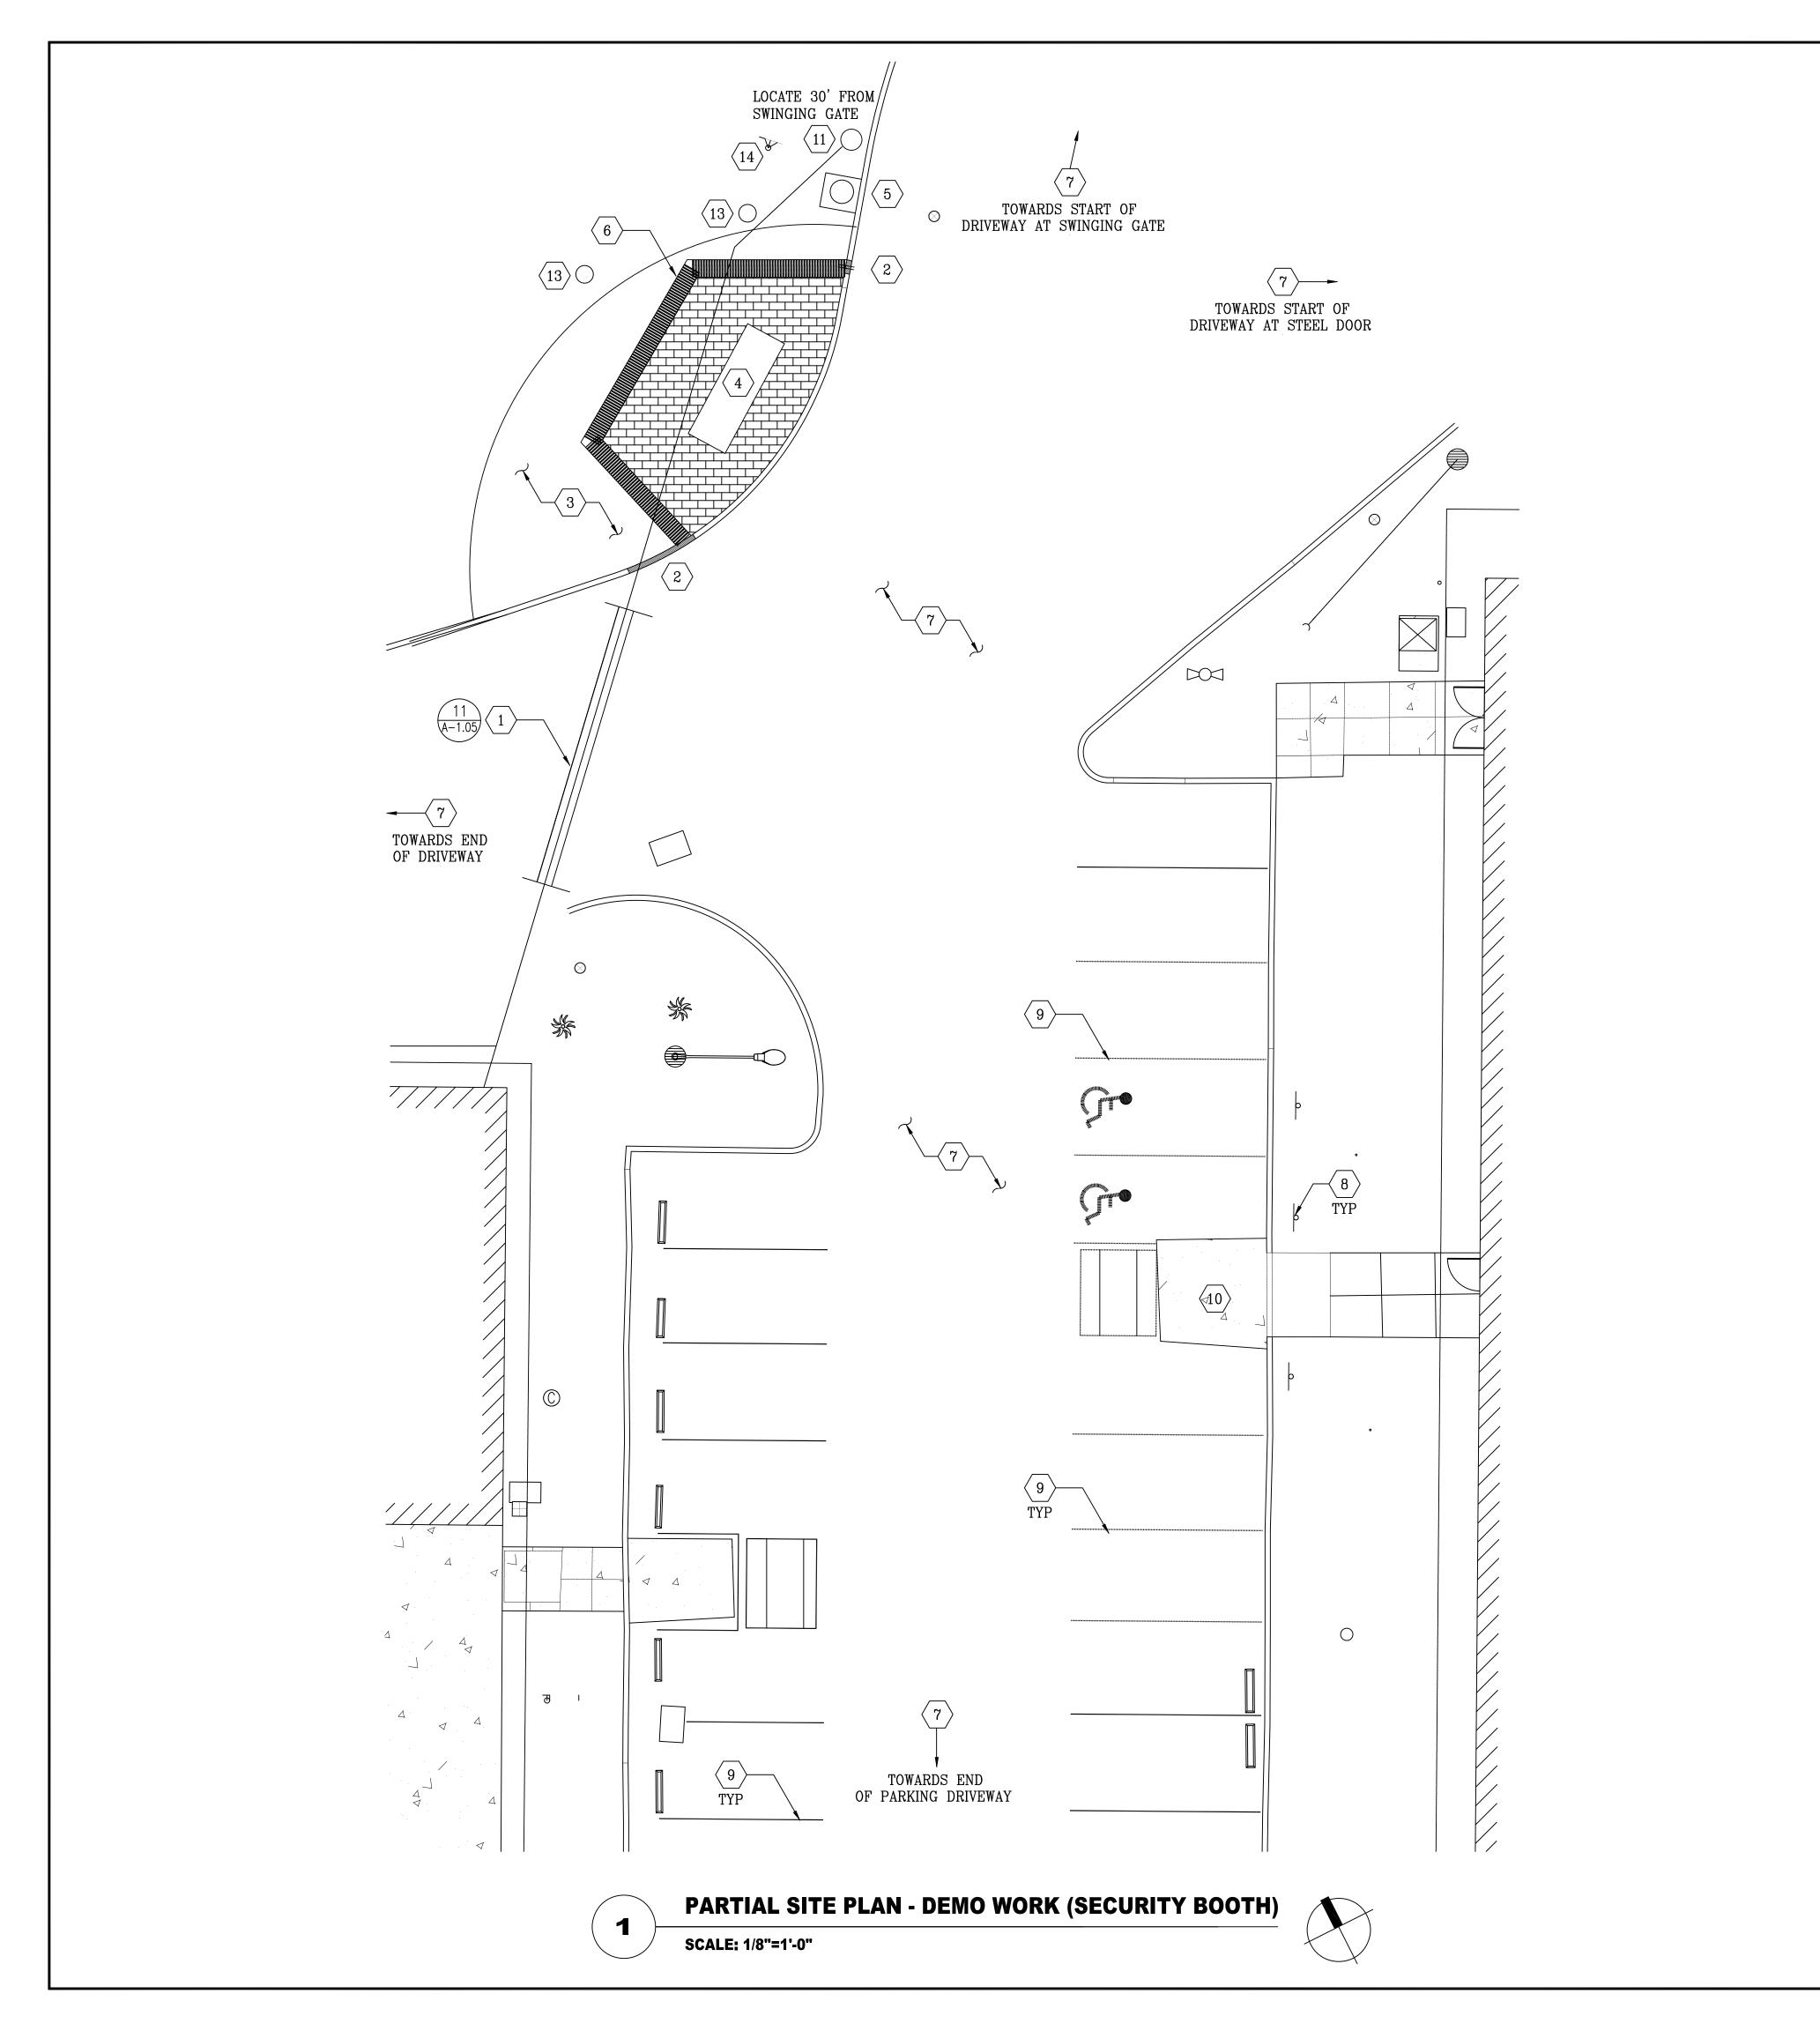

# REFERENCE NOTES: (DETAIL 2)

- SAWCUT AND REMOVE AFFECTED (E) ASPHALT PAVEMENT, CONCRETE CURB AND LANDSCAPES AREAS TO ACCOMMODATE BELOW GROUND (N) CONDUITS FOR SECURITY BOOTH POWER AND LOW VOLTAGE. ROUTINGS SHOWN ARE FOR REFERENCE ONLY. SEE ELEC AND LOW VOLTAGE DRAWINGS FOR GENERAL ROUTINGS. COORIDNATE WITH OWNER FOR EXTENT OF WORK. FOR TRENCH DETAIL, SEE 11
- SAWCUT AND REMOVE AFFECTED (E) CONCRETE SIDEWALK. PATCH AND REPAIR PER INDUSTRY STANDARDS
- $\langle 3 \rangle$  EXCAVATE, REMOVE AND RECOMPACT PORTION OF (E) LANDSCAPED AREAS FOR (N) CONC PAVEMENT & FOUNDATION SUPPORTS (APPROX. 10,500 S.F.)
- 4 REMOVE IN ITS ENTIRETY (E) CONCRETE SINK AND ALL ACCESSORIES. CAP PLUMBING LINES IN DRIVEWAY AREA. COORDINATE WITH THE COUNTY IF SINK HAS TO BE DISCARDED OR SALVAGED AND STORED AT A LOCATION APPROVED BY THE COUNTY
- (E) EXHAUST VENT BOX. PROTECT-IN-PLACE DURING CONSTRUCTION
- 6 REMOVE (E) MASONRY BRICK LOW WALLS (APPROX. 46 L.F.) AND FOUNDATION. RECOMPACT AREAS
- CLEAN AND PREP AREAS FOR NEW SLURRY COATING APPLICATIONS. REPAIR CONDITION OF (E) ASPHALT PAVEMENT IN AREAS OF WORK. APPROXIMATELY 23,810 S.F. SEE 2 (REPAIR CRACKS PER STANDARDS)

HTTPS: //DPW.LACOUNTY.GOV/GMED/LACROADS/TREATMENTSLURRYSEAL.ASPX FOR ADDITIONAL INFO ON STANDARDS.

- FOR MORE DETAILS, REFER TO THE FOLLOWING SECTIONS OF LA COUNTY SPECIAL PROVISIONS - SECTION R - ROADWAY:
- SECTION 203-5 SLURRY SEAL
- SECTION 302-4 SLURRY SEAL SURFACING • SECTION 908 - POLYMER MODIFIED EMULSIFIED ASPHALT-RECLAIMED ASPHALT PAVEMENT AGGREGATE SLURRY SEAL (PMERAPAS)
- (8) REMOVE AND DISCARD (E) ADA PARKING SIGNS ON STEEL POSTS
- 9 REMOVE (E) PARKING STRIPES, CLEAN AND PREP AREAS FOR (N) STRIPINGS. SEE NOTE 5 OF DETAIL 1/A-1.02 AND 2/A-0.01 FOR EXTENT OF WORK AREAS
- SAWCUT AND REMOVE (E) SLOPED RAMP IN ITS ENTIRETY.
  REPAIR AFFECTED ADJACENT AREAS OF WORK
- (11) EXCAVATE AND RECOMPACT AREA FOR (N) CCTV CAMERA METAL POLE CONCRETE BASE
- (E) TREES TO REMAIN. PROTECT—IN—PLACE DURING CONSTRUCTION. ADVISE THE COUNTY IF TREES HAVE TO BE REMOVED BEFORE COMMENCING WORK. AT A MINIMUM, TRIM BRANCHES TO ALLOW FOR THE OPERATION OF THE PROPOSED CCTV CAMERA ON METAL POLE. SEE NOTE 11 ABOVE
- (E) TREES TO REMAIN. PROTECT-IN-PLACE DURING CONSTRUCTION. CONTRACTOR TO ADVISE IF REMOVAL IS NECESSARY WITH THE OWNER
- (E) MAIN ENTRANCE SIGN TO REMAIN. PROTECT-IN-PLACE DURING CONSTRUCTION

# GENERAL NOTES:

- 1. CONTRACTOR SHALL PERFORM GROUND PENETRATING RADAR TEST BEFORE COMMENCING WORK. DOCUMENT ALL UTILITY LINES THROUGH AS-BUILT PROCESS. INFORM THE ARCHITECT OF FINDINGS.
- 2. PROTECT AT ALL COST EXISTING STRUCTURES, SURFACES, ON-SITE EQUIPMENTS, ETC DURING CONSTRUCTION. CONTRACTOR SHALL BE RESPONSIBLE FOR ANY DAMAGES INCURRED DUE TO NEGLIGENCE AND OR AS RESULT OF NOT FURTHER INVESTIGATING OR FAMILIARIZING HIMSELF WITH ALL AREAS INVOLVED (NOT ONLY LIMITED TO WORK AREAS)
- 3. DO NOT BLOCK ANY INGRESS OR EGRESS PATHWAY OF STRUCTURE. PROVIDE A CLEAR AND UNOBSTRUCTED PATH OF TRAVEL DEEMED SAFE AS AN ALTERNATIVE WAY TO AND FROM BUILDING ENTRANCES, IF NECESSARY
- 4. SUBMIT CONSTRUCTION SAFETY PLAN TO OWNER FOR REVIEW AND APPROVAL
- 5. VERIFY LOCATION FOR APPROVAL WITH OWNER FOR STAGING AREA AS REQUIRED FOR TEMPORARY STORAGE OF DEBRIS REMOVED AND STORAGE FOR SUPPLY OF MATERIALS. CONTRACTOR TO PATCH & REPAIR ANY DAMAGED PORTION OF AFFECTED AREA AS A RESULT OF TEMPORARY STAGING AREA

**SPEC 7879** 

BUILDING PLAN CHECK APPLICATION NUMBER

BLDC240417000421

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LOS ANGELES COUNTY PUBLIC WORKS 900 SOUTH FREMONT AVE. ALHAMBRA, CA 91803

PROJECT

**CAMP GLENN ROCKEY SECURITY UPGRADES** 

LOCATION:

1900 N. SYCAMORE ROAD, SAN DIMAS, CA 91773

ARCHITECT

:::::JTC •••••• architects, inc.

65 N. 18T AVENUE, SUITE 201 ARCADIA, CA 91006

:626-254-8884 E:info@jtcarch.com

JTC PROJECT NO: 37606.0D

CONSULTANT :


TITLE:

PARTIAL SITE PLAN SECURITY BOOTH & ADA PARKING -**DEMO WORK** 

AS NOTED 6-10-24 DRAWN BY: JTC CHECKED BY:

A-1.01

SHEET NUMBER:

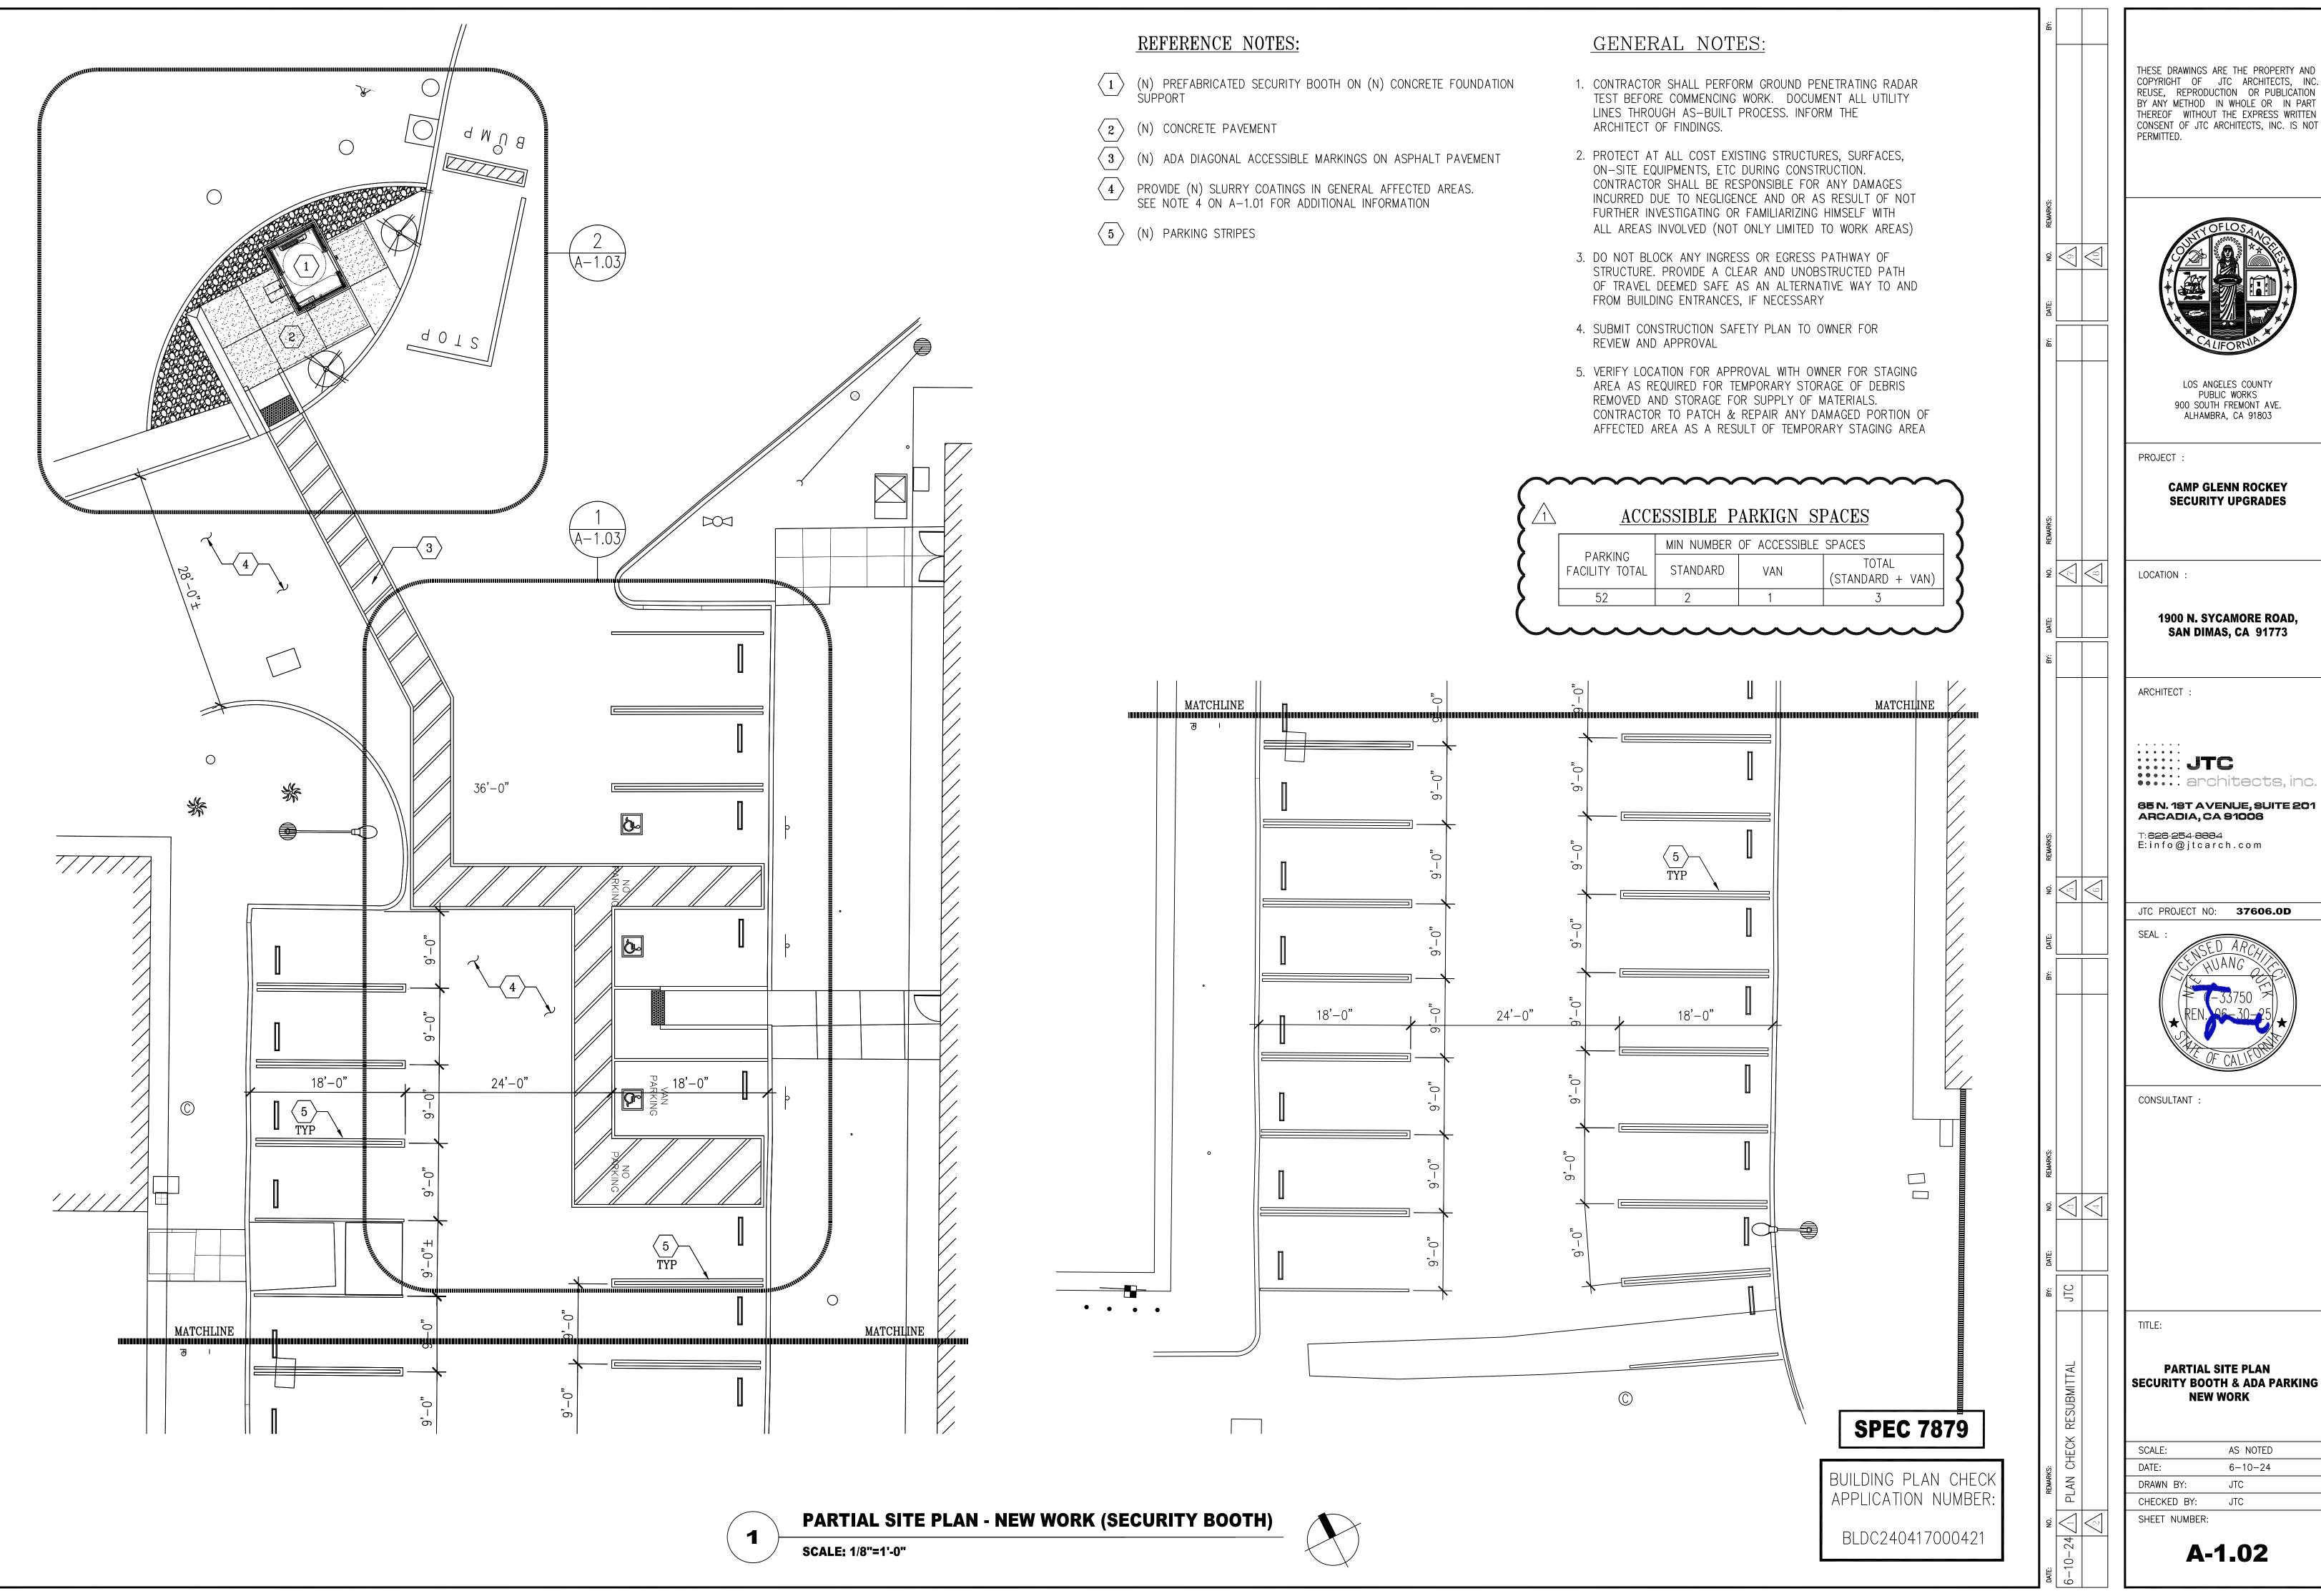

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LOS ANGELES COUNTY
PUBLIC WORKS
900 SOUTH FREMONT AVE.

**CAMP GLENN ROCKEY SECURITY UPGRADES** 

1900 N. SYCAMORE ROAD,

65 N. 18T AVENUE, SUITE 201 ARCADIA, CA 91006


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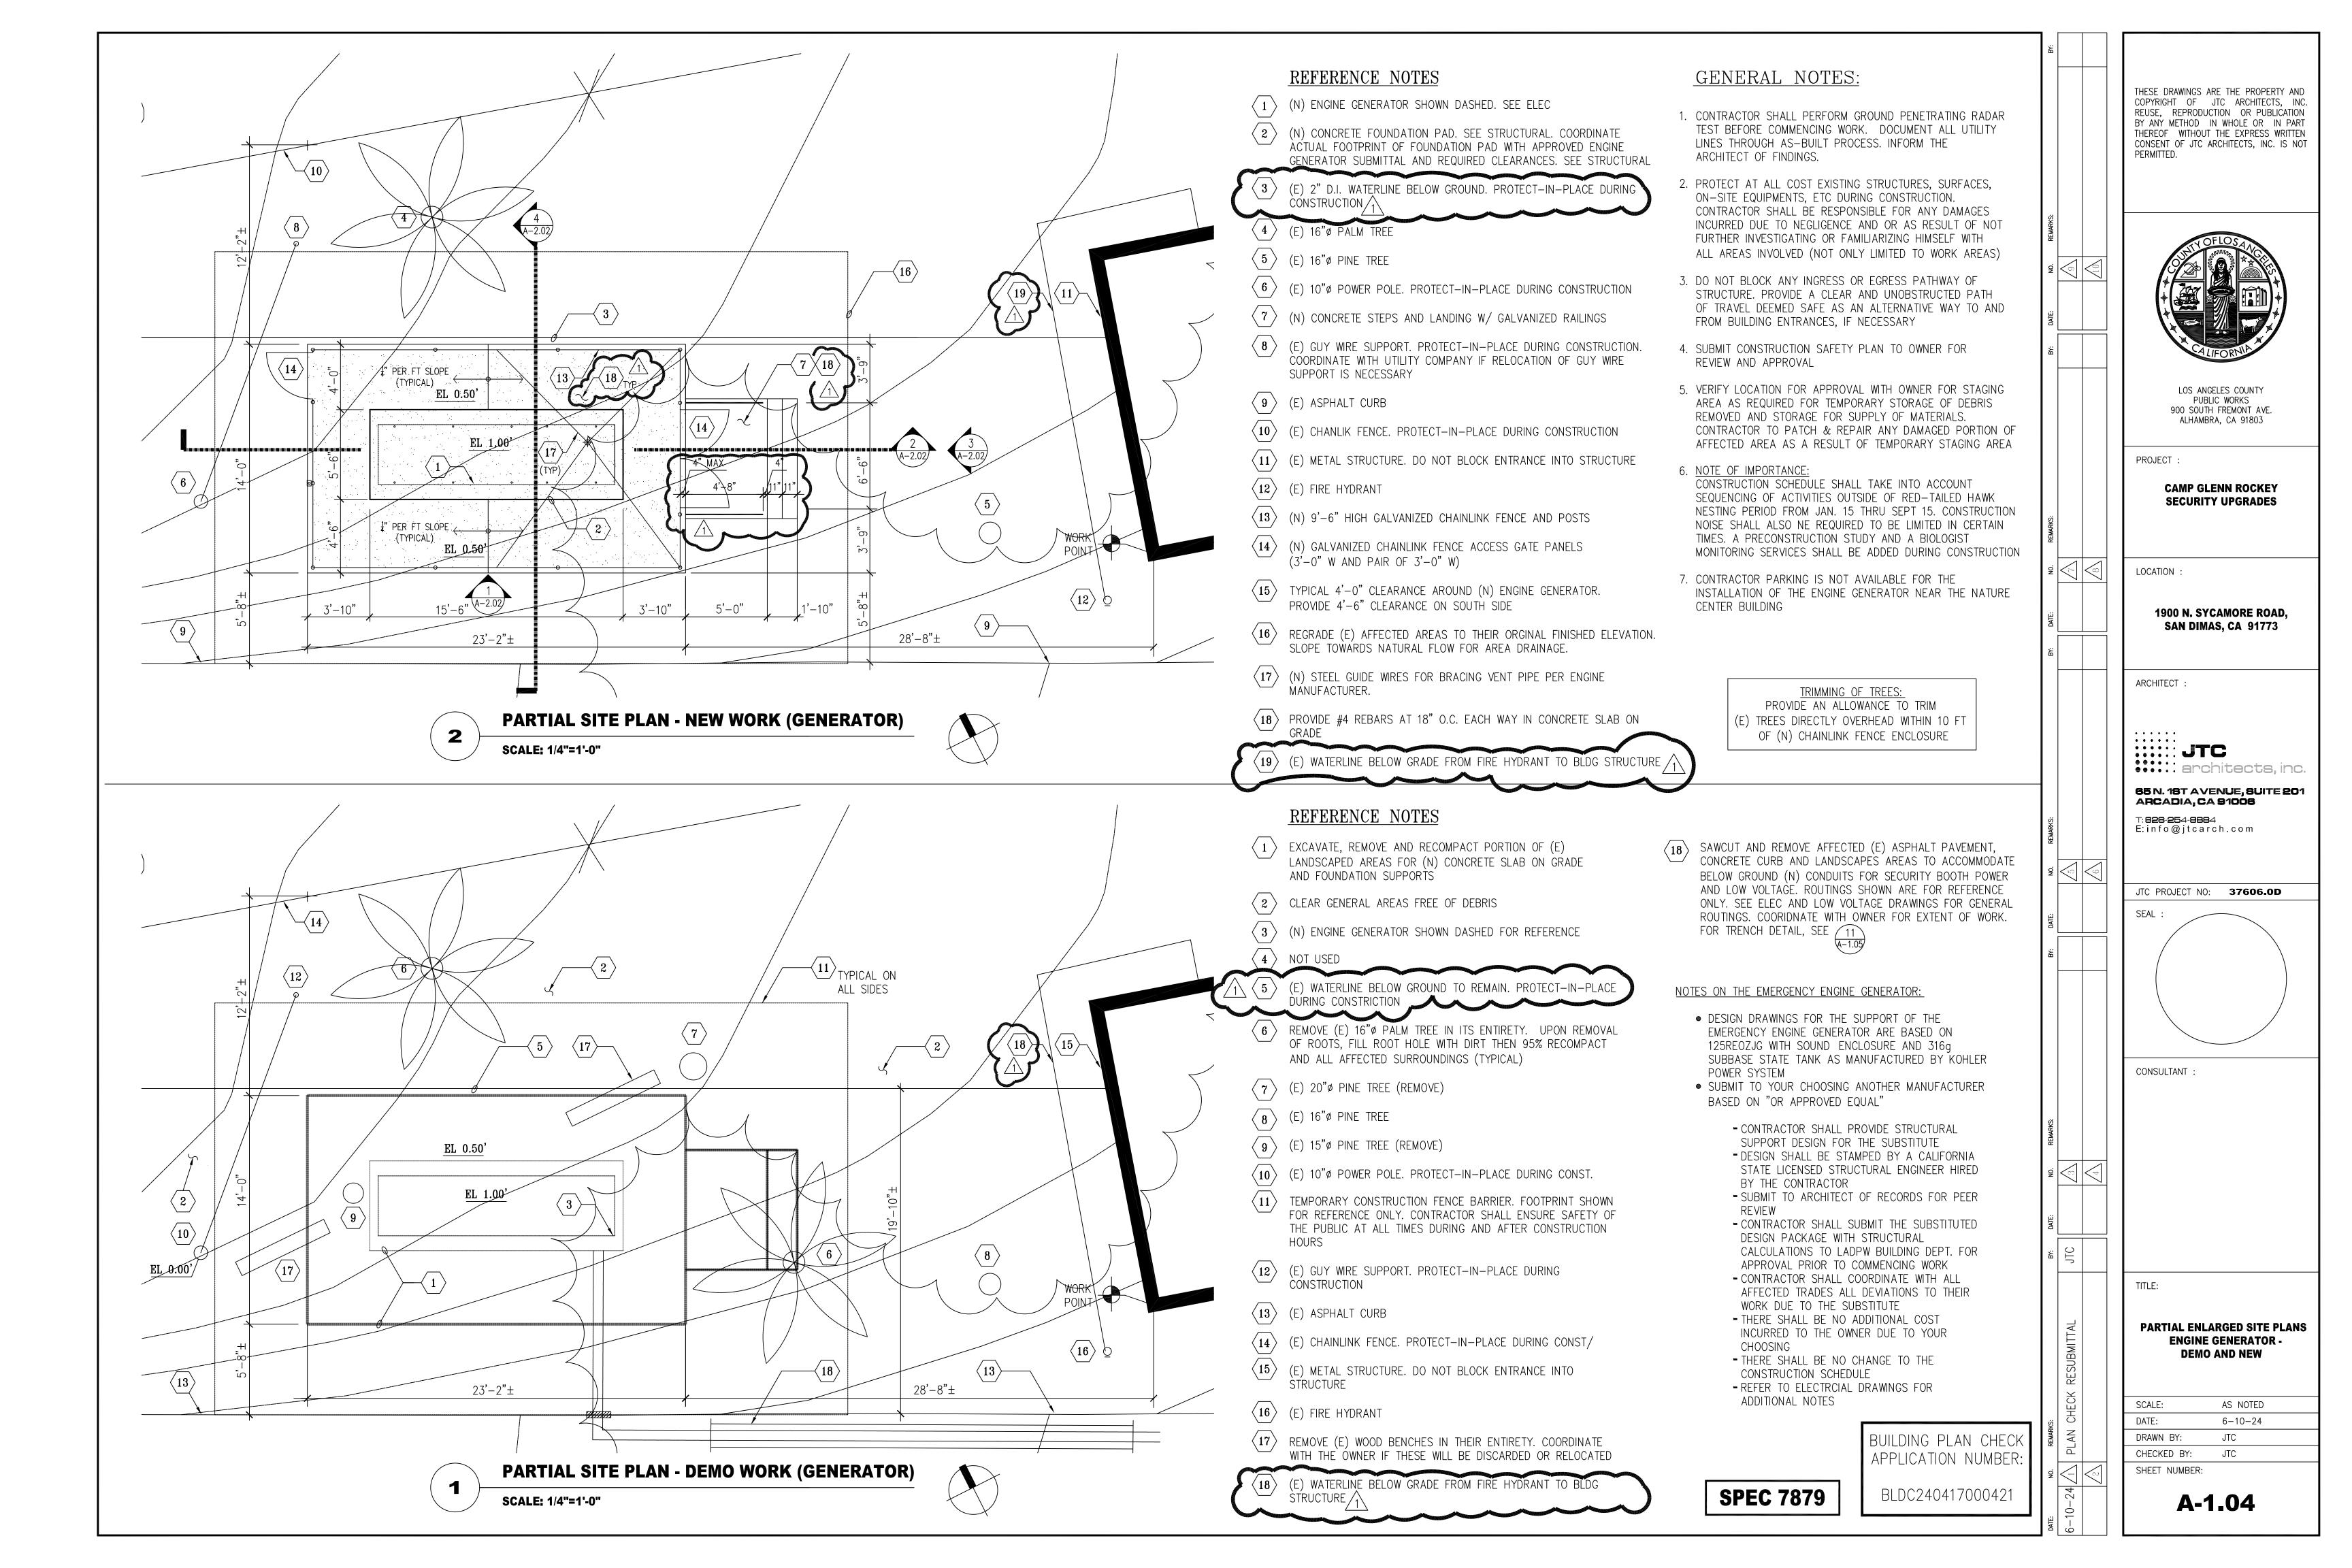
JTC PROJECT NO: **37606.0D** 


**PARTIAL SITE PLAN** SECURITY BOOTH & ADA PARKING -**NEW WORK** 

AS NOTED 6-10-24 JTC

**A-1.02** 




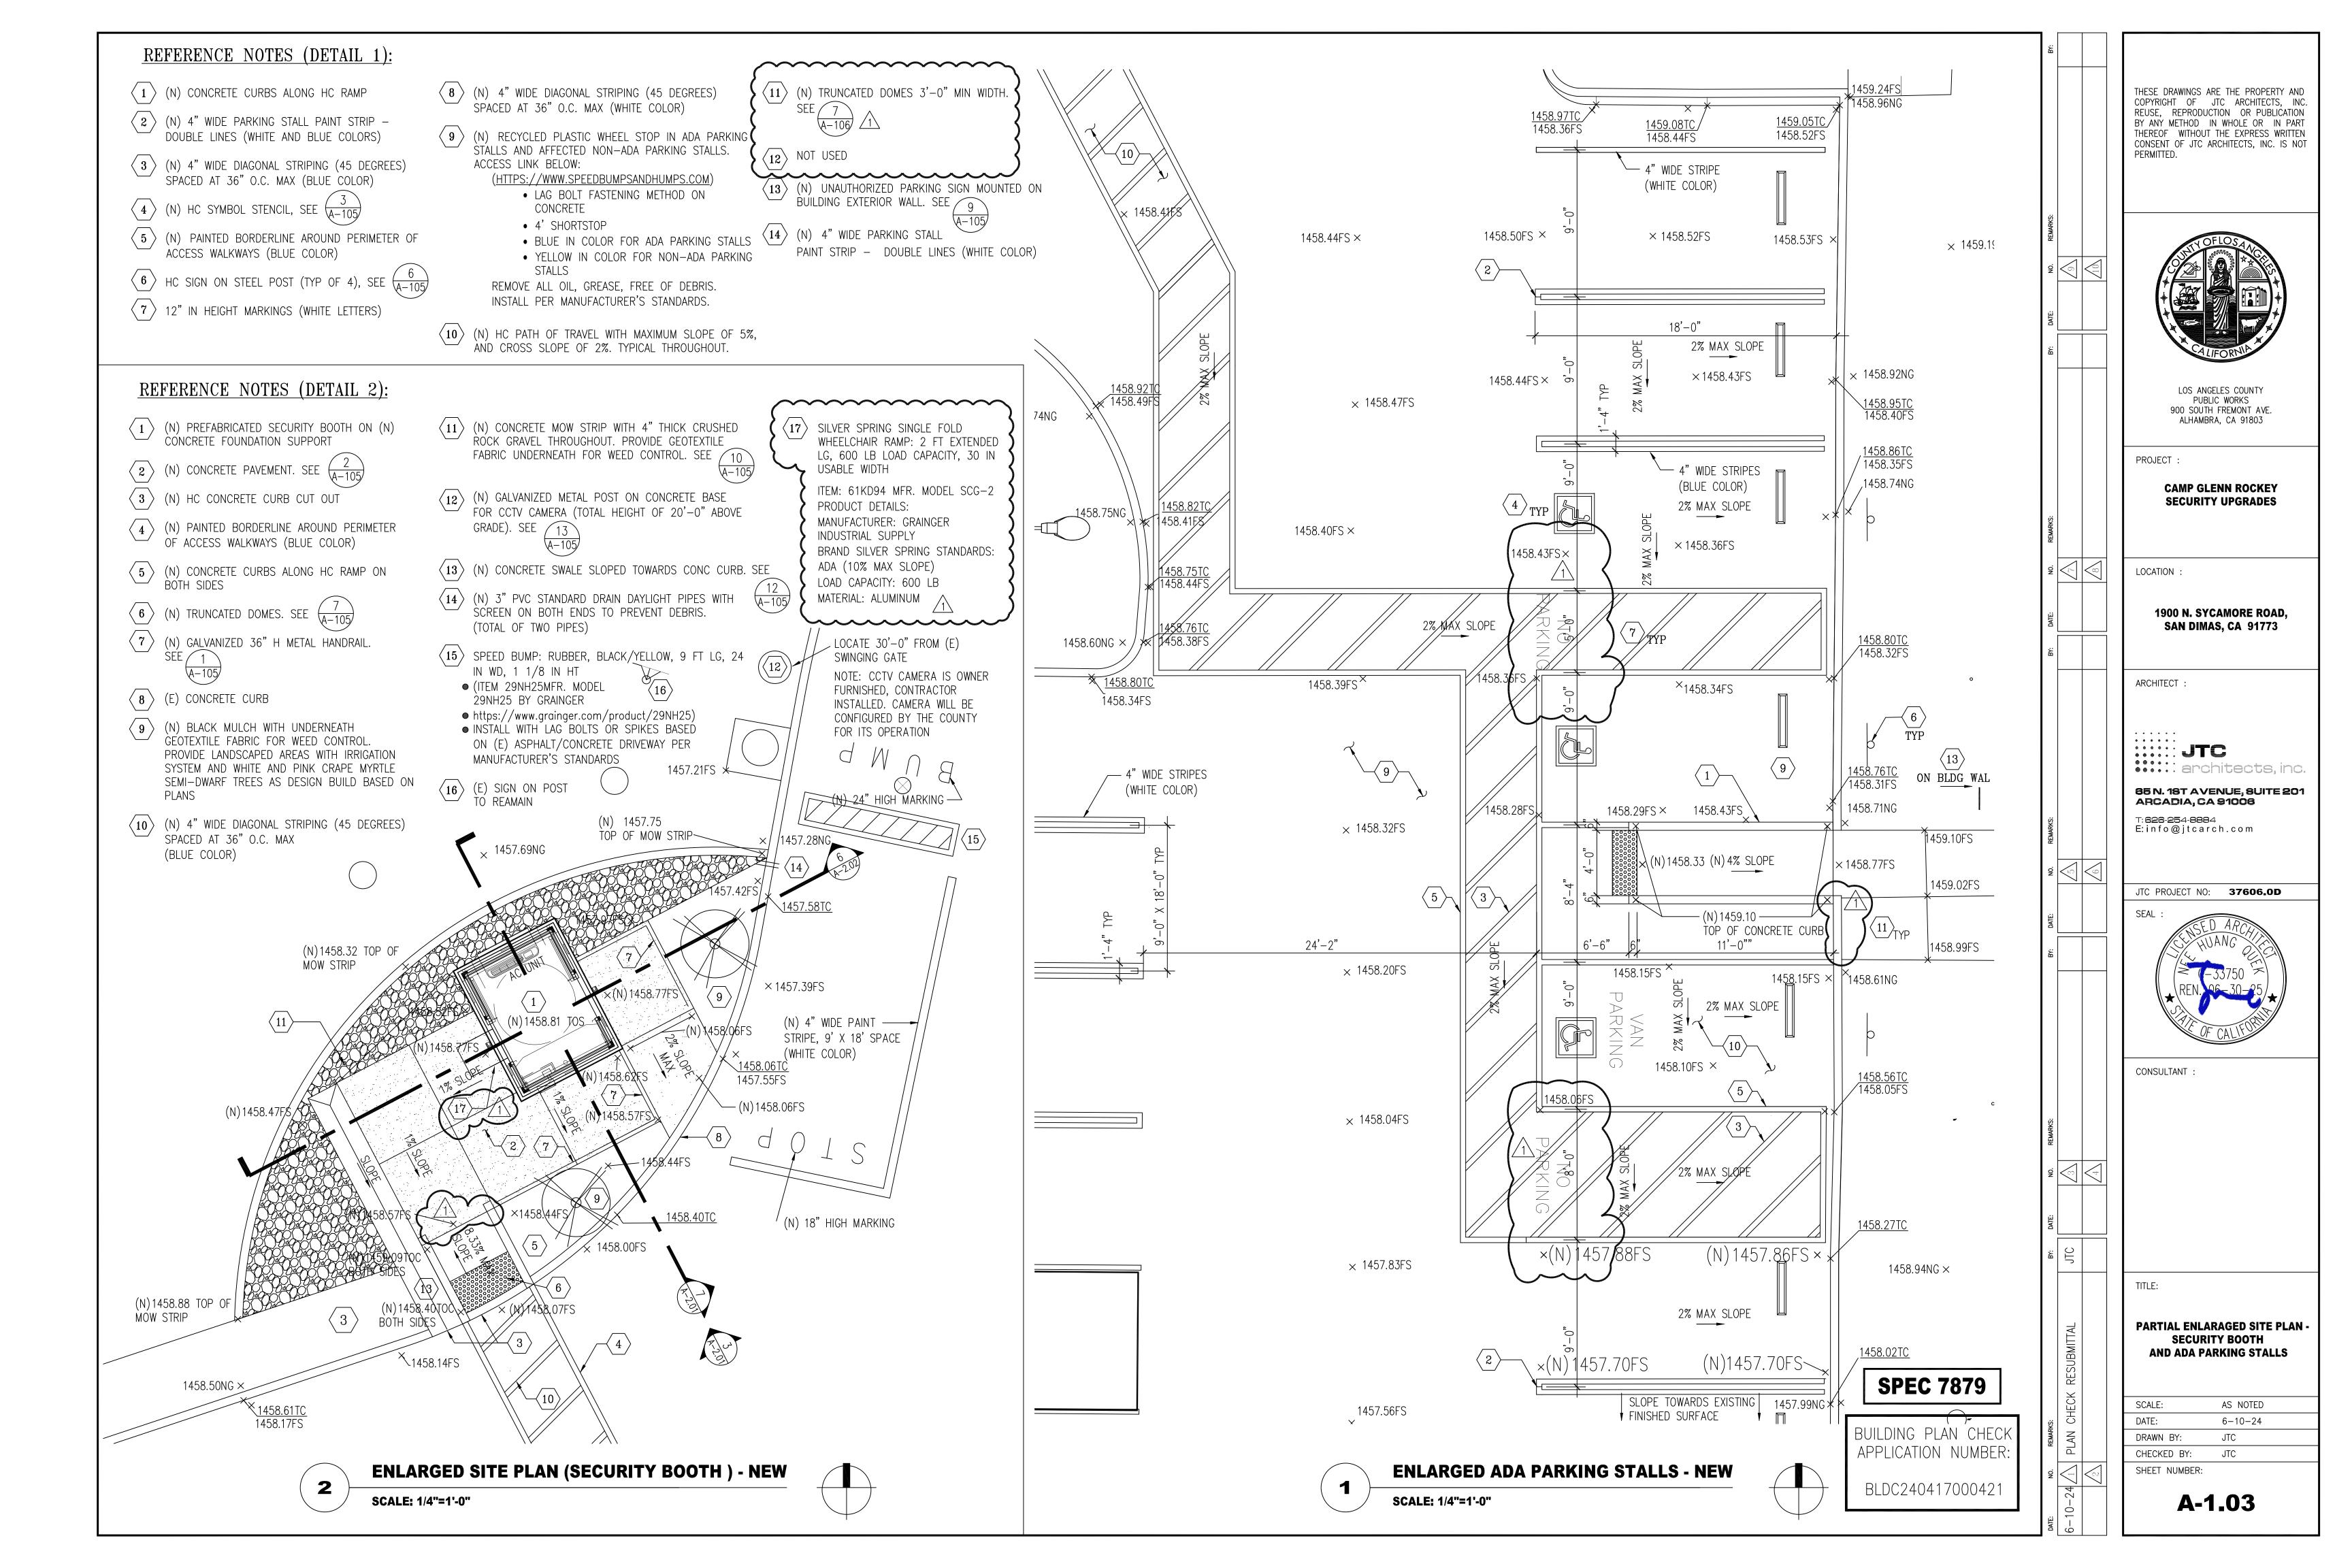


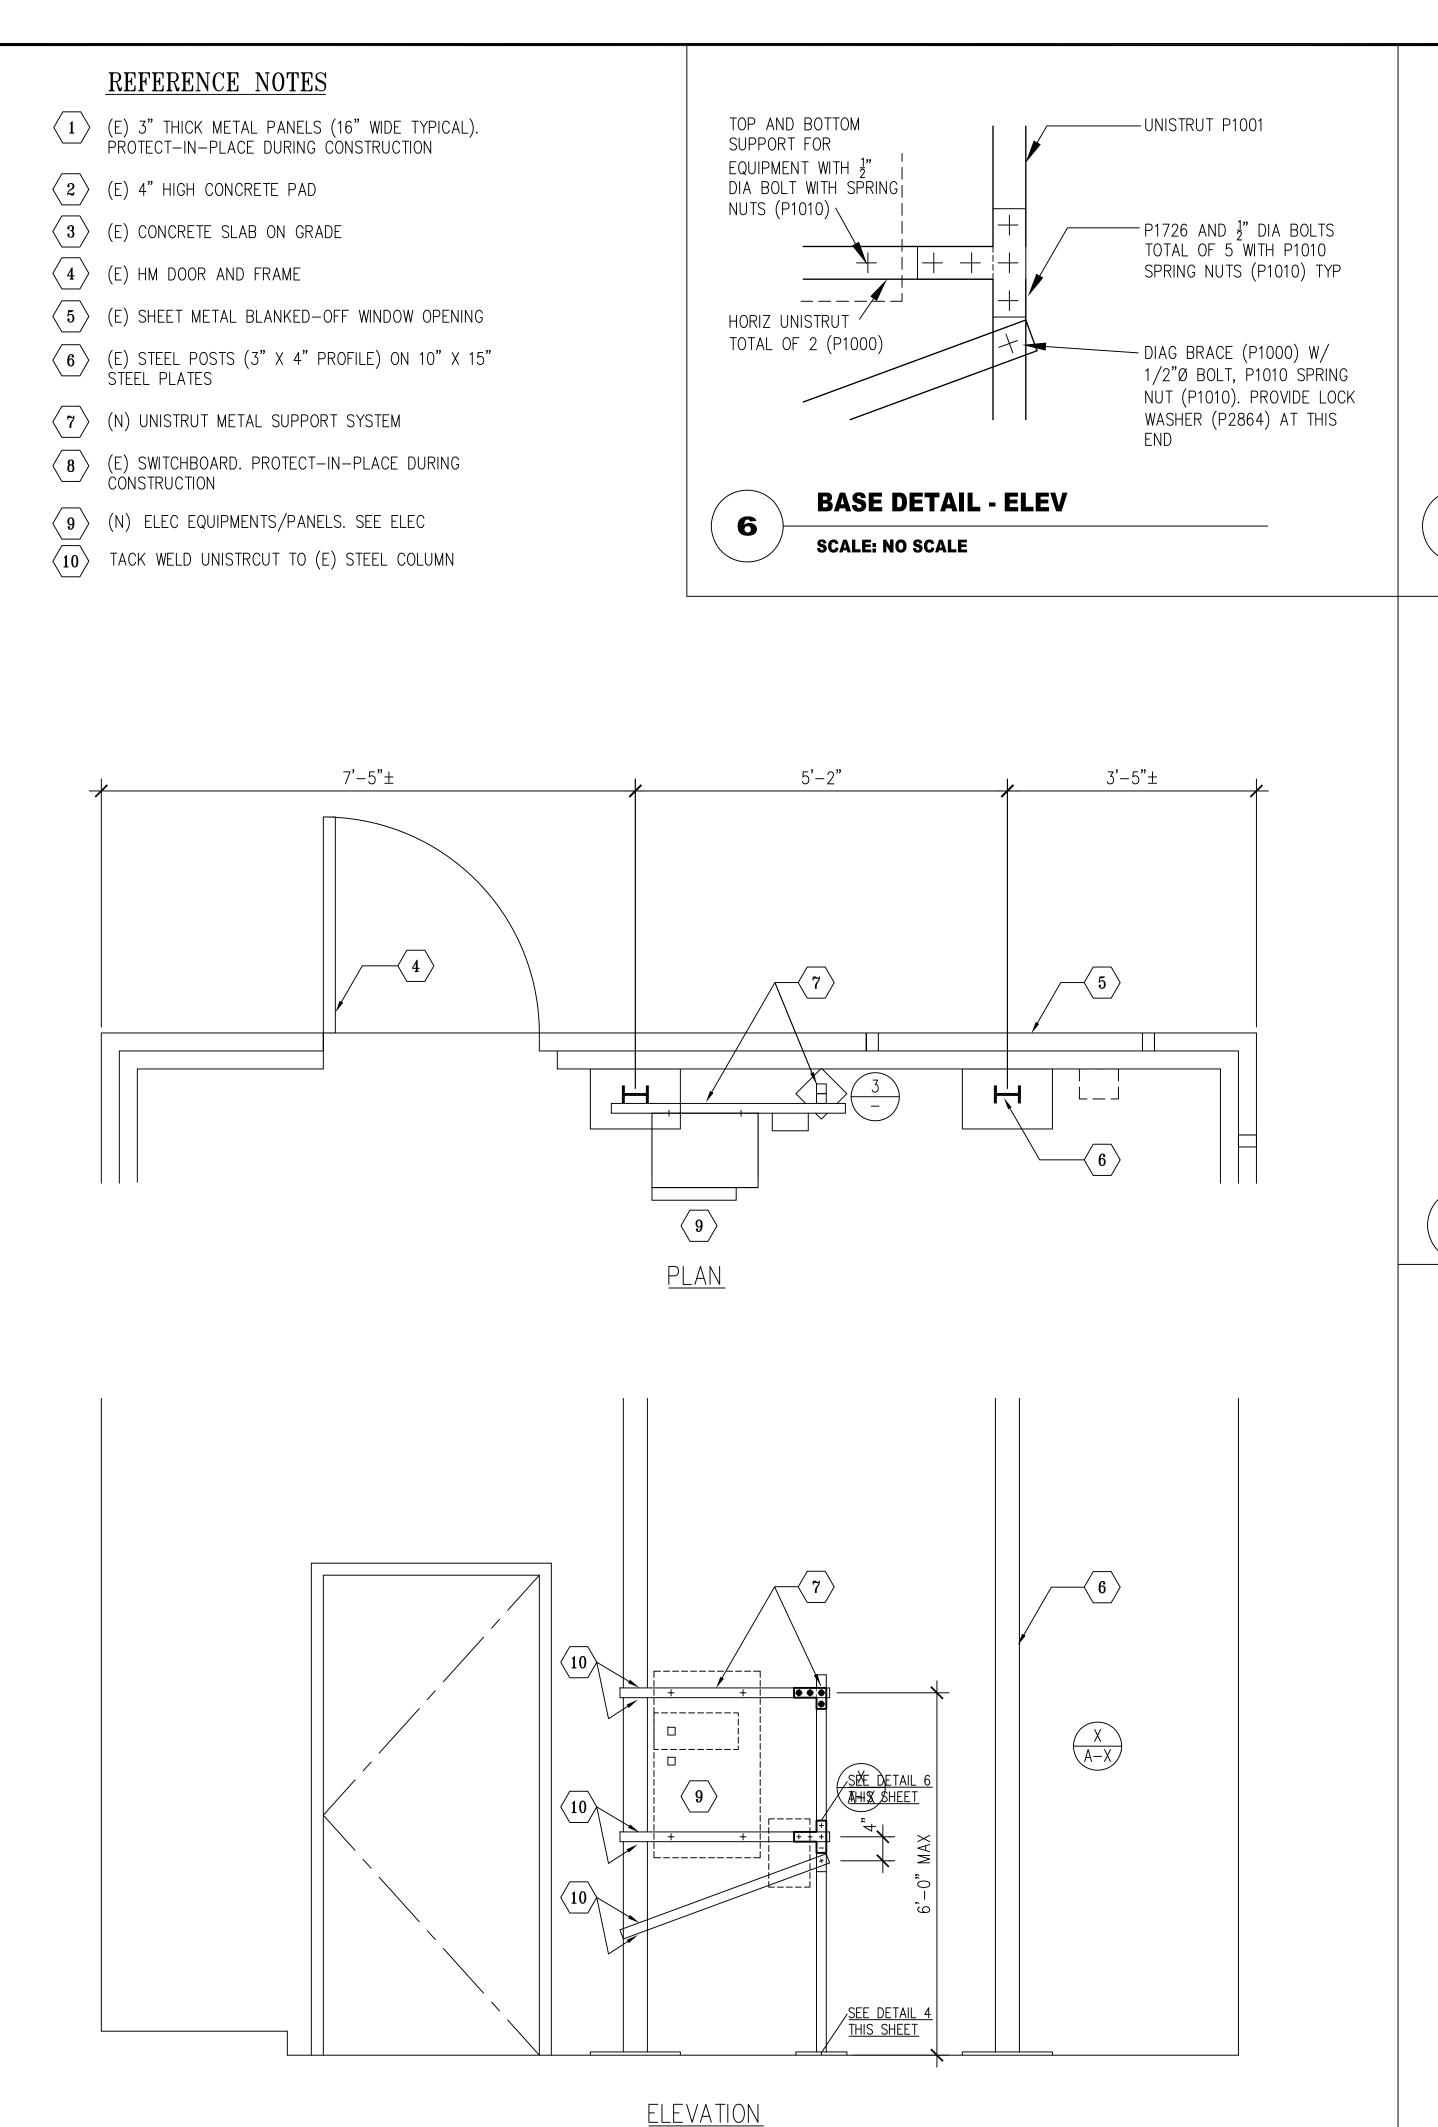


**STEEL FRAME SUPPORT DETAIL** 

SCALE: 3/4"=1'-0"

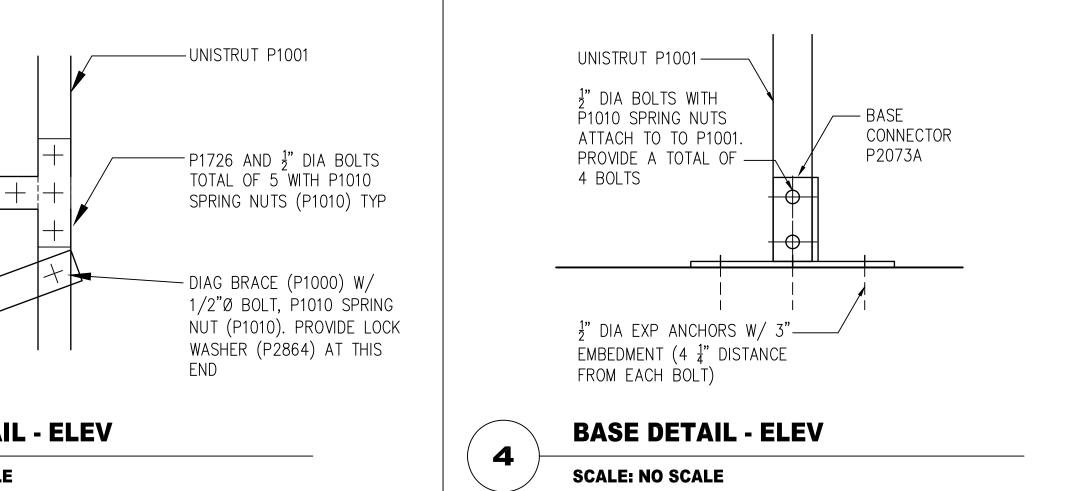

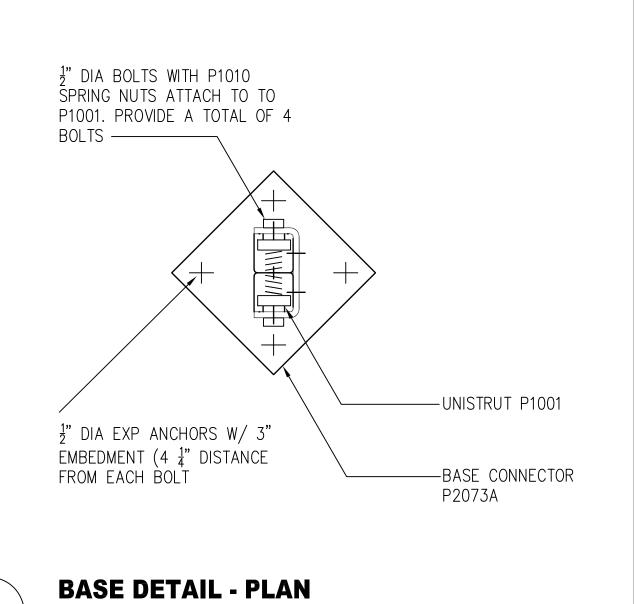

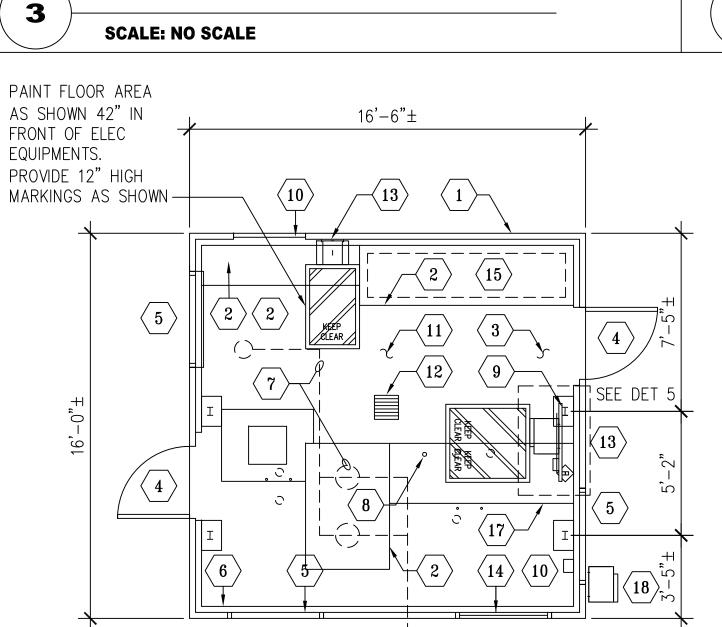

# $\langle 15 \rangle$ (E) SWITCHBOARD. PROTECT-IN-PLACE DURINF

- (E) SHEET METAL BLANKED-OFF DOOR OPENING
- $\langle 17 \rangle$  (E) ISOLATION JOINT IN CONCRETE FLOOR SLAB
- REMOVE (E) OUTDOOR MTS AND ITS SUPPORTS IN THEIR ENTIRETY.

REFERENCE NOTES

SCALE: NO SCALE

GENERAL NOTES, THIS DETAIL

3. MAXIMUM DIAMETER  $(\phi)$  OF OPENING = 8"

ANNULAR MAXIMUM OPENING = 1-1/4"

FOR INFO NOT SHOWN HEREIN

4. ANNULAR MINIMUM OPENING = 1/2"

WALL/PARTITION ASSEMBLY

2. F RATING = 4 HOUR

WALL/PARTITION

T RATING = O HOUR

1. REFER TO UL THROUGH PENETRATION FIRESTOP DETAIL, REFERENCED BELOW,

5. PIPE, CONDUIT, OR TUBING TO BE RIGIDLY SUPPORTED ON BOTH SIDES OF

KEYED REFERENCE NOTES, THIS DETAIL [X]

1. WALL/PARTITION ASSEMBLY: 1-HOUR RATING DESIGNATION

2. SINGLE CONCENTRIC OR ECCENTRIC THROUGH PENETRANT:

B) STEEL CONDUIT: NOM MAX 4"Ø (STEEL EMT)

3. FILL MATERIAL (SEALANT): MIN 1-1/2" THICK, APPLIED

4. NOM 8"Ø (OR SMALLER) SCHD 40 (OR HEAVIER) FRICTION

FIT; STEEL SLEEVE: SLÉEVE LENGTH EQUAL TO PARTITION

SEE KEYNOTE

WITHIN ANNULUS, FLUSH WITH BOTH SURFACE OF

A) STEEL PIPE: NOM MAX 6"Ø (SCHD 10 OR HEAVIER)

C) COPPER TUBING: NOM MAX 6"ø (TYPE L OR HEAVIER)

D) COPPER PIPE: NOM MAX 6"Ø (REGULAR OR HEAVIER)

(E) 3" THICK METAL PANELS (16" WIDE TYPICAL). PROTECT—IN—PLACE DURING CONSTRUCTION

WALL PENETRATION DETAILS

- $\langle 2 \rangle$  (E) 4" HIGH CONCRETE PAD
- $\langle 3 \rangle$  (E) CONCRETE SLAB ON GRADE
- $\langle 4 \rangle$  (E) HM DOOR AND FRAME
- $\langle 5 \rangle$  (E) SHEET METAL BLANKED-OFF WINDOW OPENING
- (E) CONCRETE BASE ALL AROUND PERIMETER OF STRUCTURE
- $\langle 7 \rangle$  (E) WATER PUMPS WITH ASSOCIATED PIPING AND
- $\langle$  8  $\rangle$  (E) CONDUIT STUB OUTS. CUT AND CAP CONDUITS ÀS CLOSE TO FLOOR
- $\langle 9 \rangle$  (E) STEEL POSTS (3" X 4" PROFILE) ON 10" X 15"
- $\langle 10 \rangle$  (E) EQUIPMENTS/PANELS. SEE ELEC
- CLEAN ENTIRE FLOOR AREA FREE OF DIRT AND DEBRIS
- (E) AREA DRAIN
- $\langle 13 \rangle$  (N) ELEC EQUIPMENTS/PANELS. SEE ELEC
- $\langle 14 \rangle$  (E) WINDOW GLAZING IN METAL FRAME





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LOS ANGELES COUNTY PUBLIC WORKS 900 SOUTH FREMONT AVE. ALHAMBRA, CA 91803

PROJECT :

**CAMP GLENN ROCKEY SECURITY UPGRADES** 

LOCATION:


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CONSULTANT:


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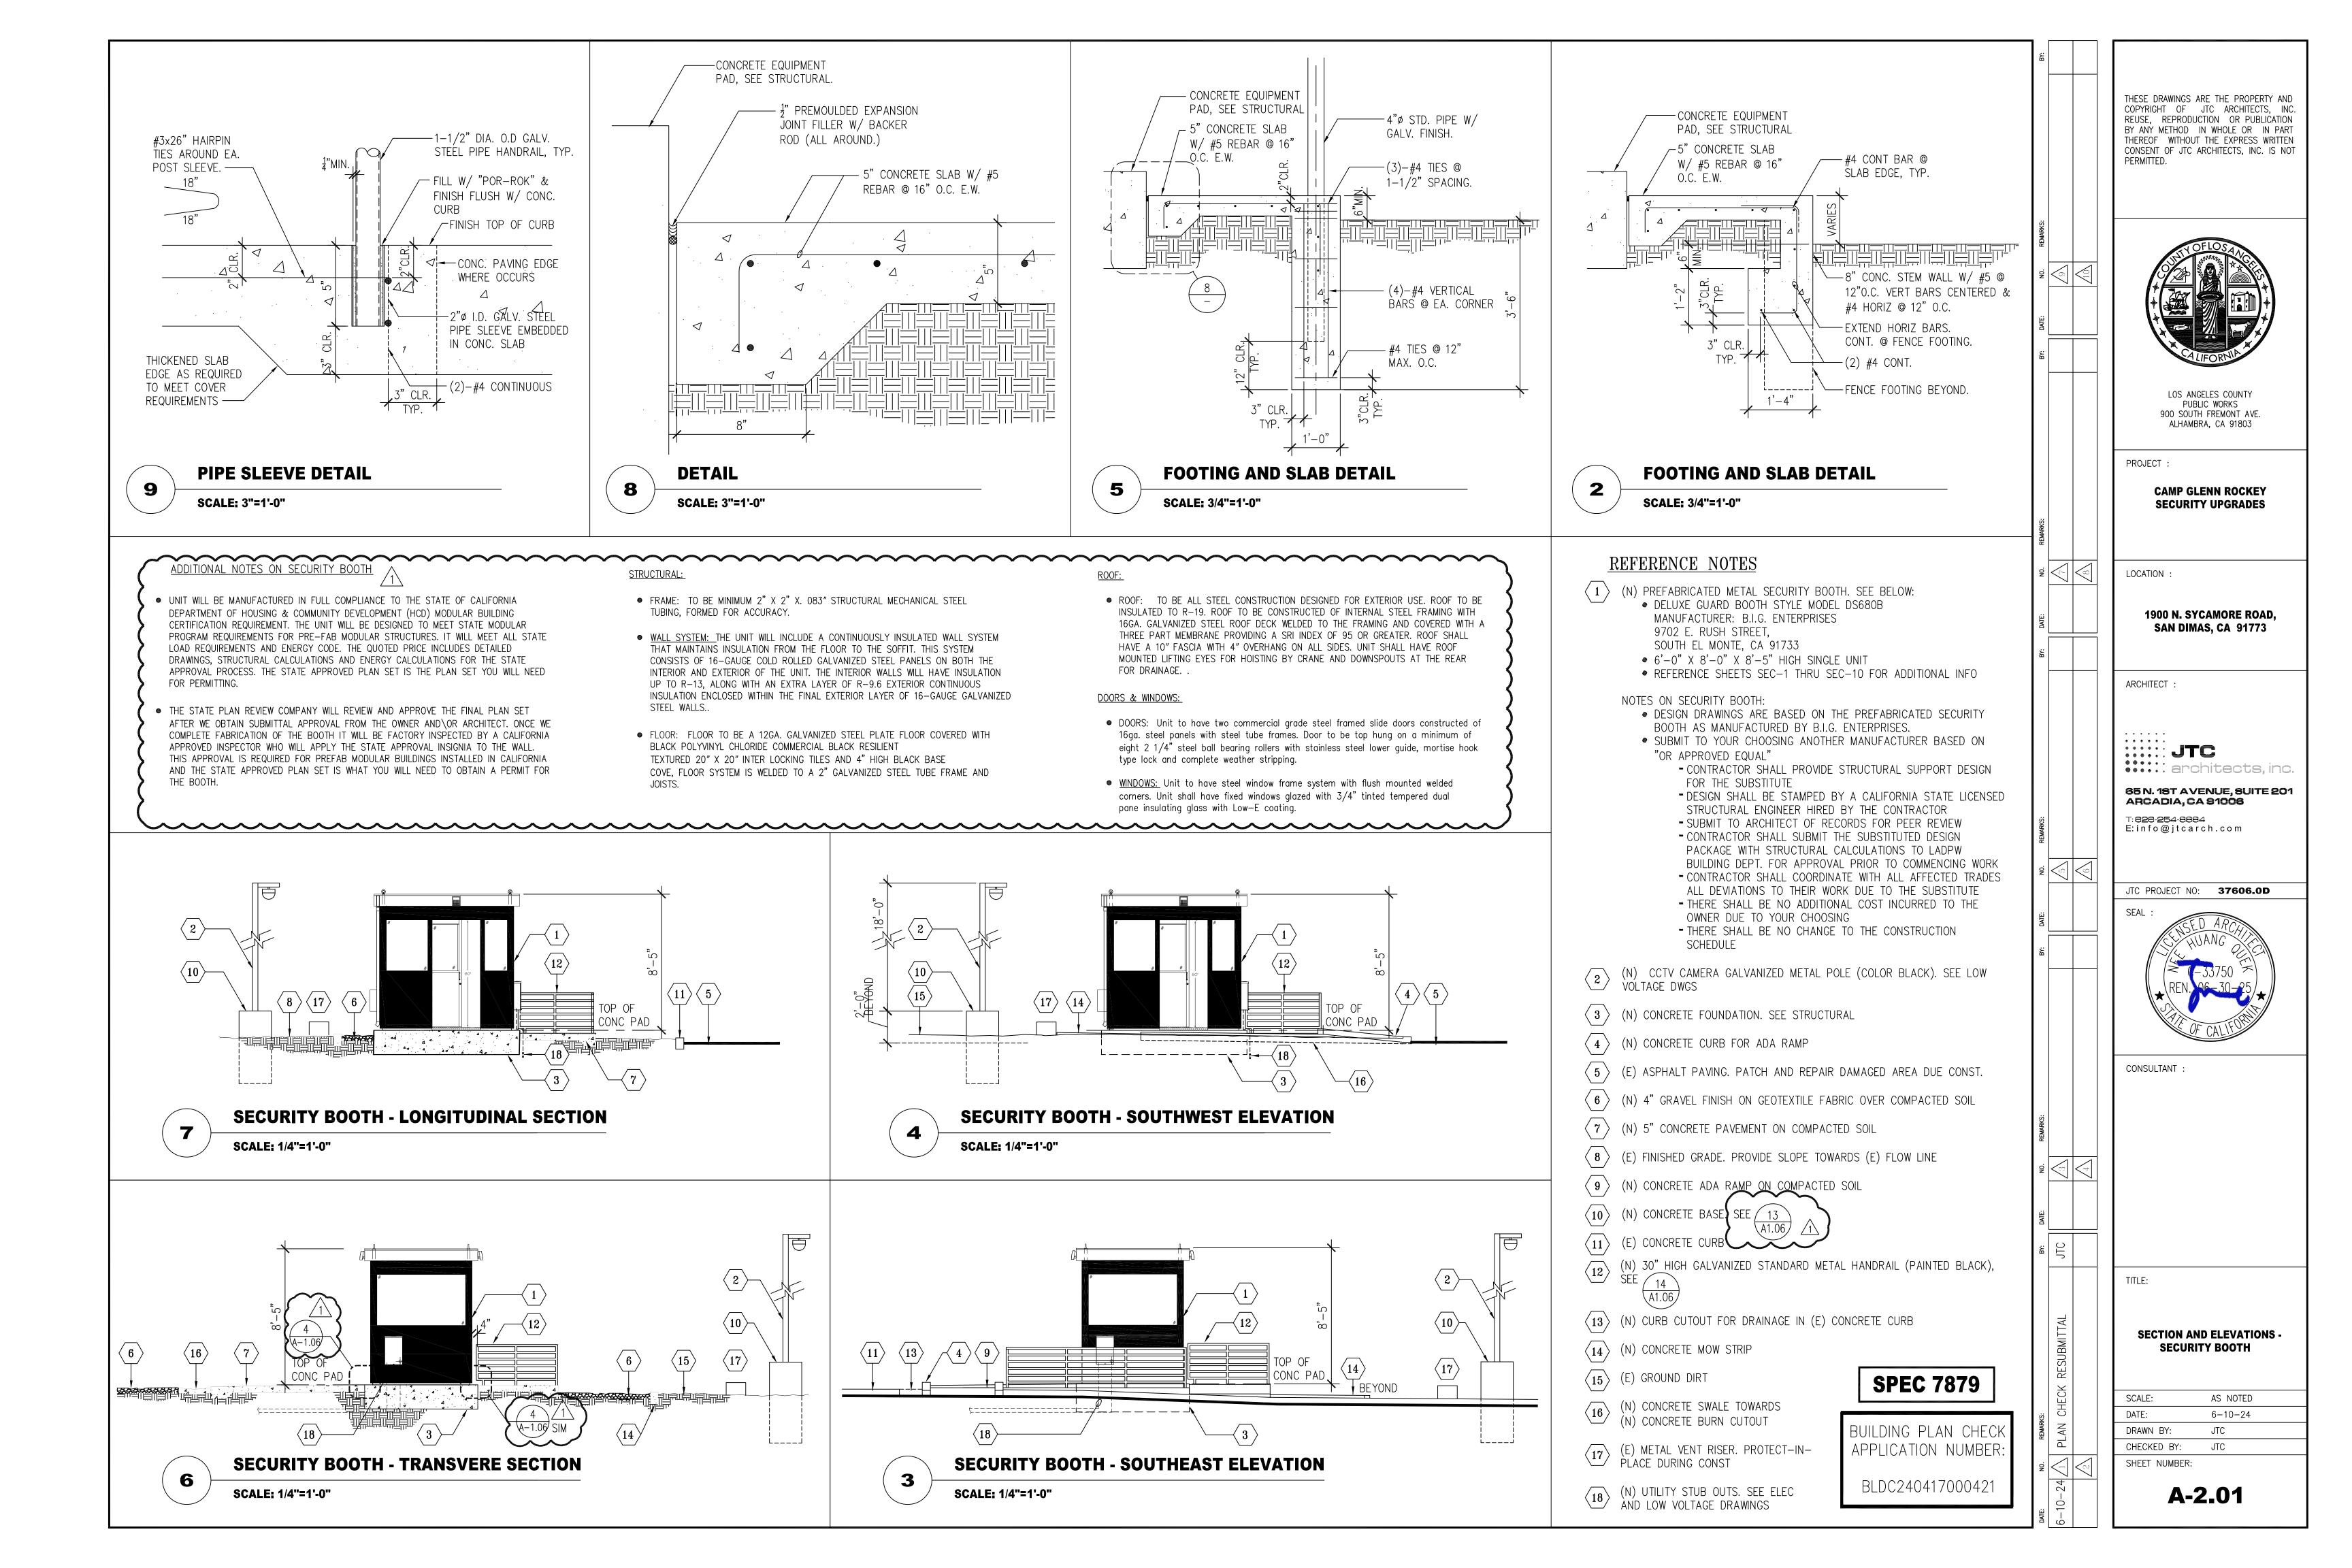
**ENLARGED PUMP HOUSE** FLOOR PLAN - NEW WORK


AS NOTED 6-10-24 DRAWN BY: CHECKED BY:

SHEET NUMBER:

**A-1.05** 

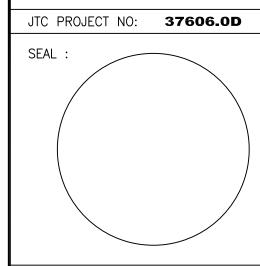

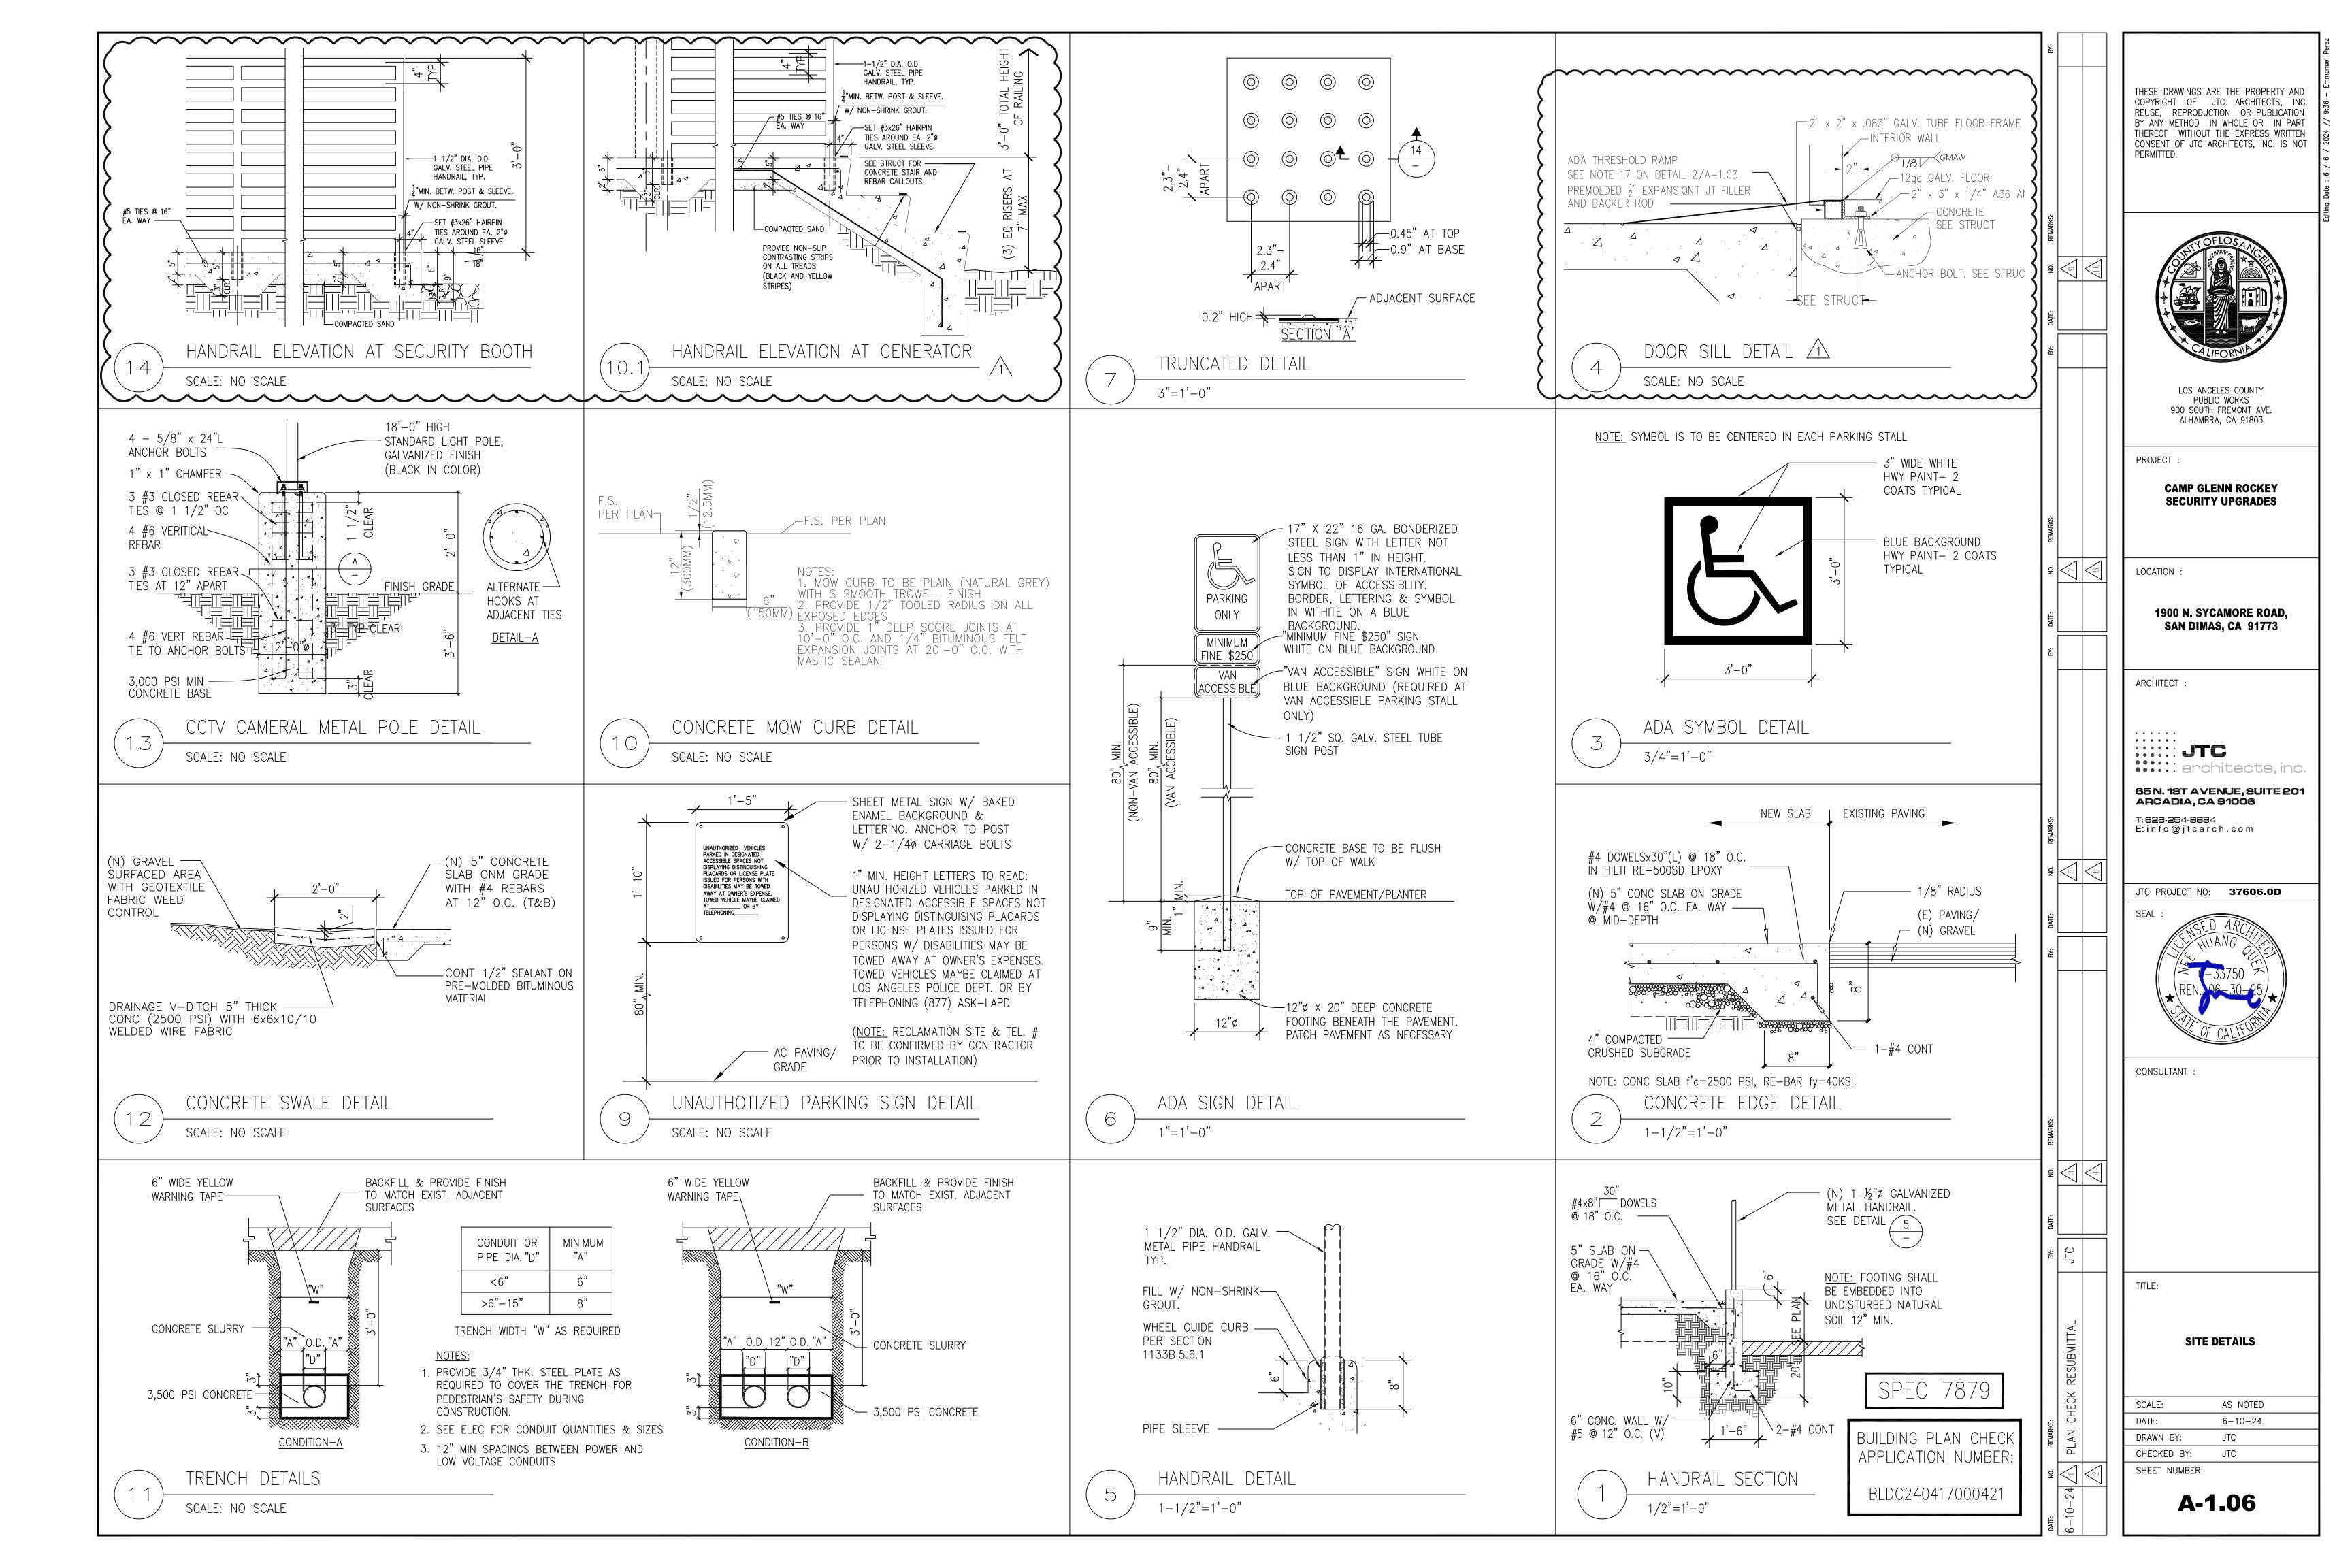

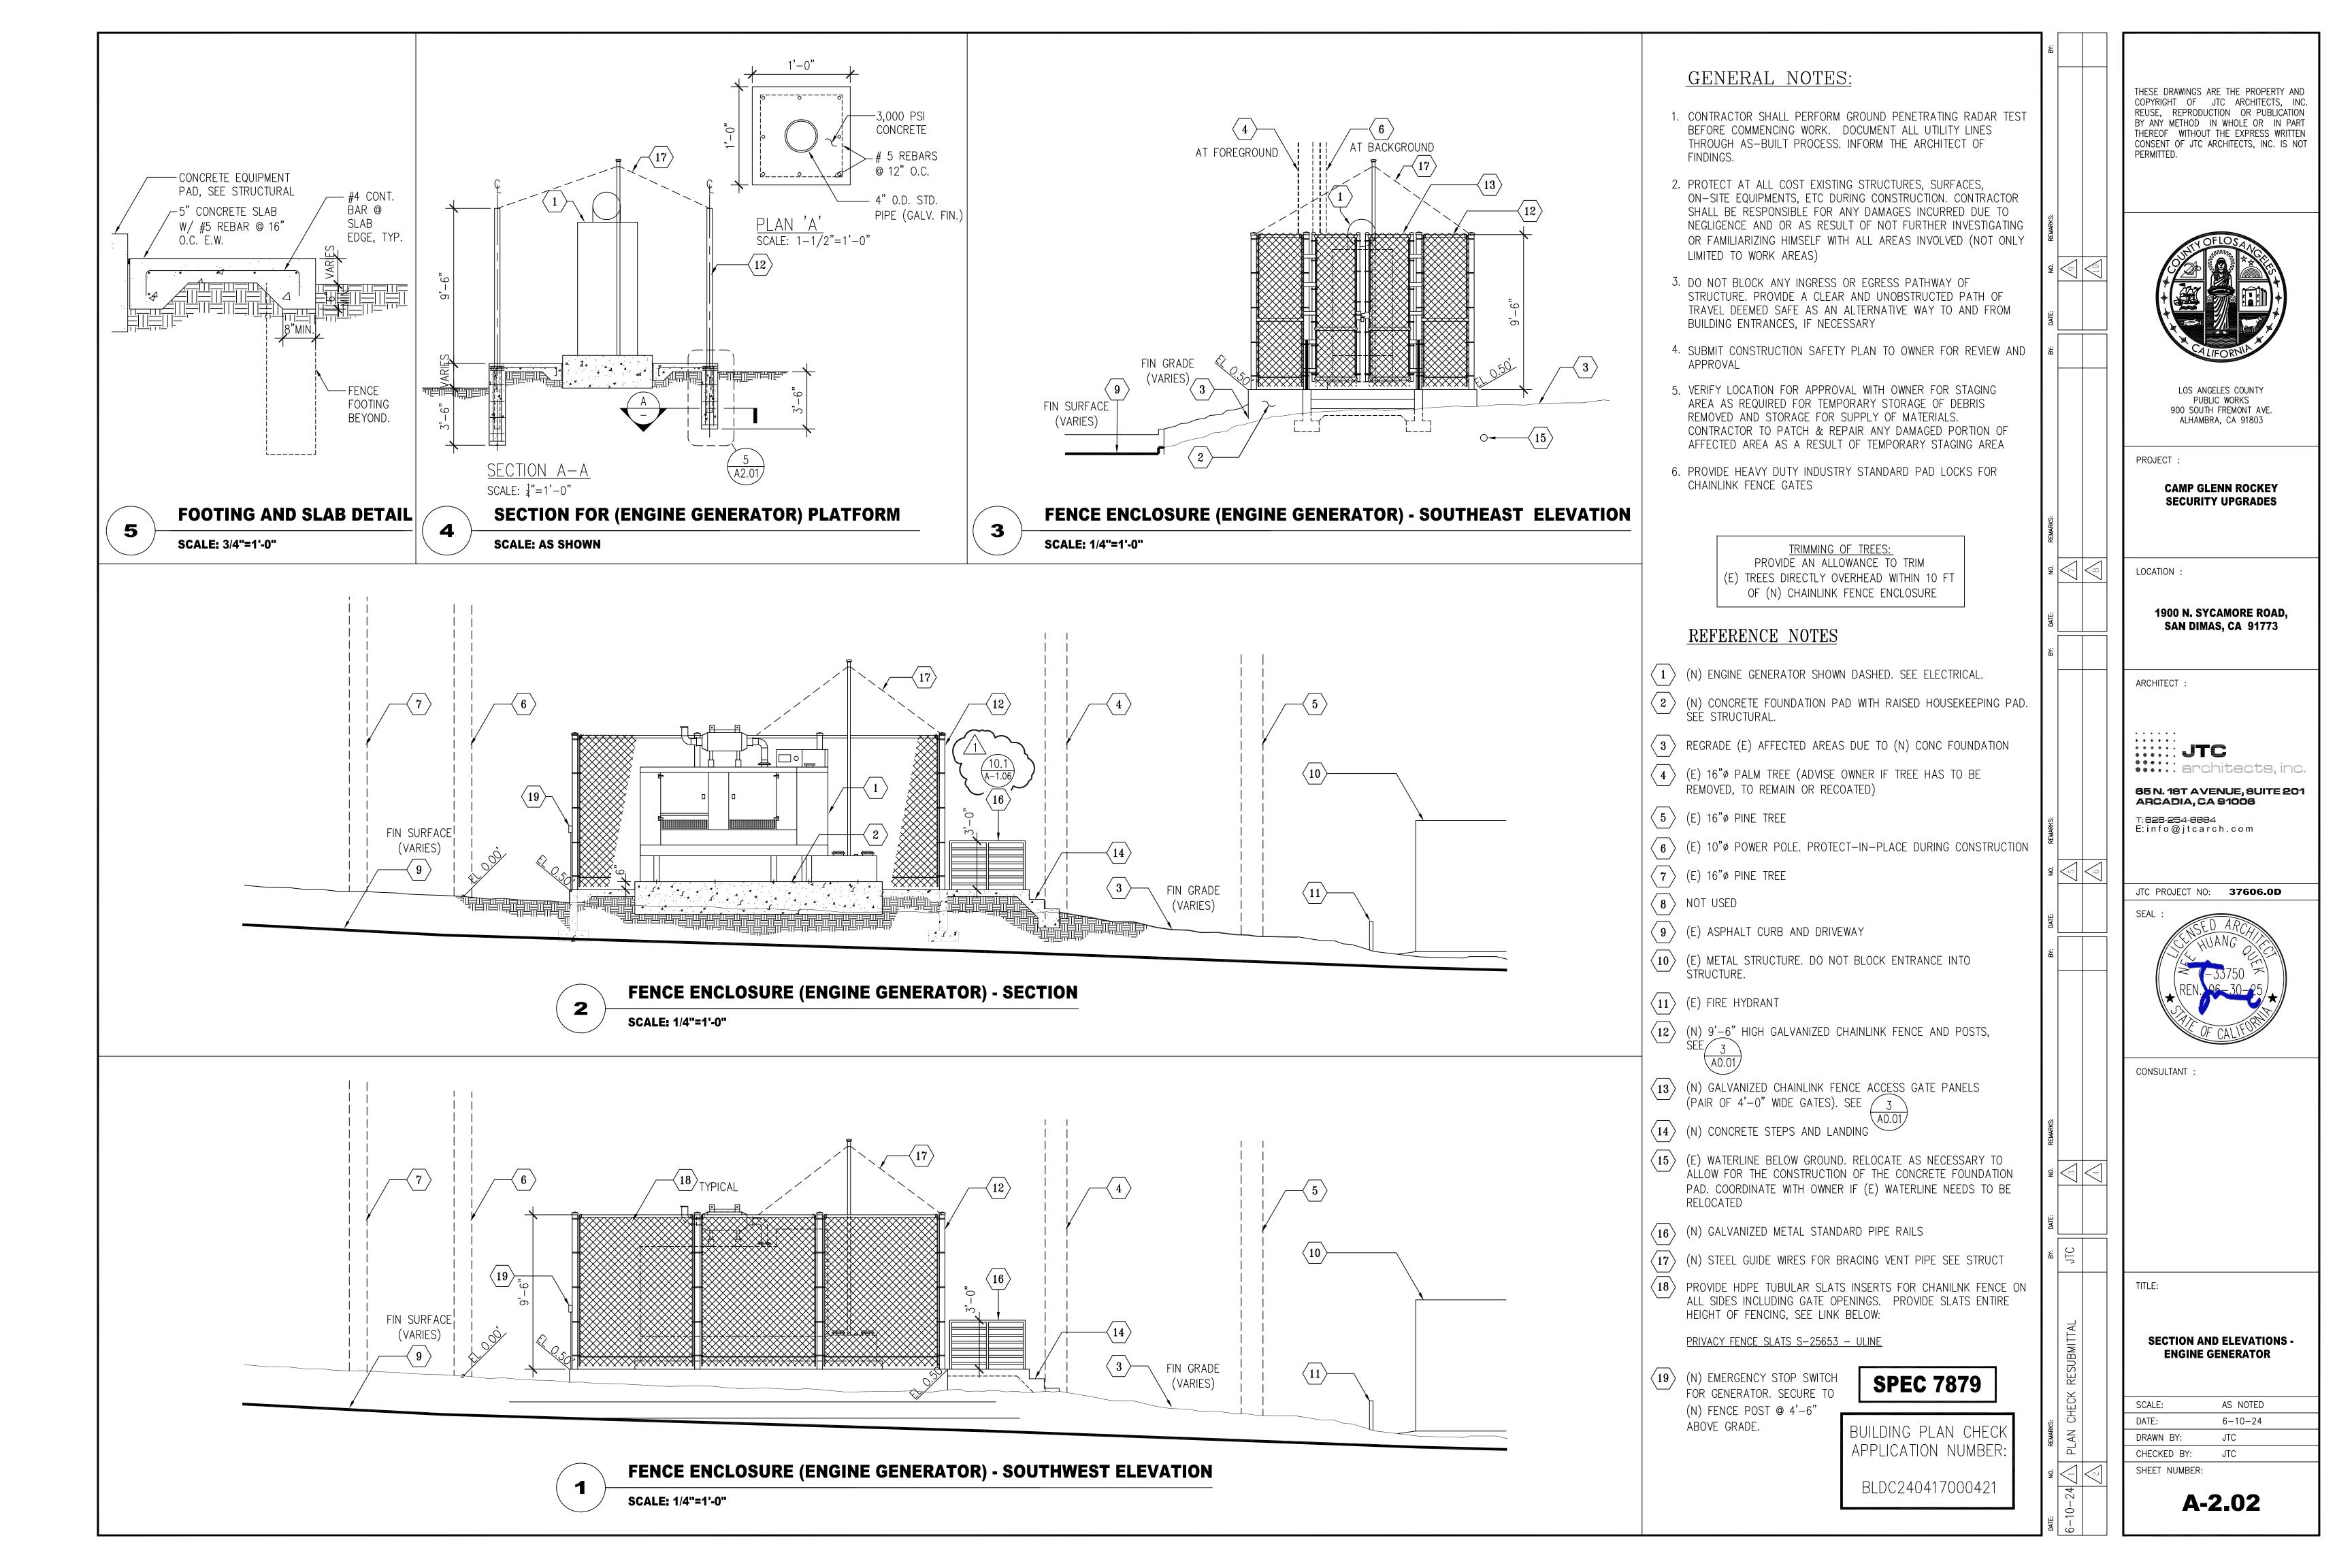

ADDDEW/ATIONS		FOUNDATIONS	
### CONTRACT PROPERTY OF THE CONTRACTOR OF THE C	DISTRICTURE NOTICE TO SECURITY AND ALL PROPERTY OF THE SECURITY OF THE SECURIT	POLICIAMENTOS CONTANEO DE PRESENTA DE PROJECTION CONTRANCA SE SENTE EL CONTRANCA DE	REMORRON STEEL.  1. CETHARS, FORGEROUND AND PURMOR OF ELEPHONOR STEEL, SHALL CONTROL TO STEELING YORKSTON, AND DESCRIPTION CONTROL CONTROL OF CHARGAS PROJECT STEELING YORKSTON, AND DESCRIPTION CONTROL OF CHARGAS PROJECT STEELING YORKSTON, AND DESCR
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LOS ANGELES COUNTY
DEPARTMENT OF PUBLIC WORKS
900 SOUTH FREMONT AVE. 8TH FLOOR
ALHAMBRA, CA 91803

PROJECT :

**CAMP GLENN ROCKEY** SECURITY UPGRADES

LOCATION:

1900 N. SYCAMORE ROAD, SAN DIMAS, CA 91773

ARCHITECT :

JTC architects, inc.

65 N. 18T AVENUE, SUITE 201 ARCADIA, CA 91006

T:**626-254-888**4 E: info@jtcarch.com

JTC PROJECT NO: **37606.0D** 

CONSULTANT :

STRUCTURAL ENGINEERS

LONG BEACH . SAN DIEGO LONG BEACH OFFICE 3900 Cover Street, Long Beach CA 90808 • 562.985.3200 Project: 23-0177-00

TITLE:

STRUCTURAL NOTES AND **ABBREVIATIONS** 

04-17-2024 DRAWN BY: CHECKED BY:

SHEET NUMBER:

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- 1. ALL CONCRETE WORK SHALL CONFORM TO THE STANDARDS OF THE AMERICAN CONCRETE INSTITUTE (ACI), "ACI MANUAL OF CONCRETE PRACTICE" CURRENT EDITION, "SPECIFICATIONS FOR STRUCTURAL CONCRETE" (ACI 301), AND BUILDING CODE REQUIREMENTS FOR STRUCTURAL CONCRETE (ACI 318).
- WHEN SPECIFIED FOR USE, NORMAL WEIGHT (NWT) CONCRETE SHALL HAVE A DRY UNIT WEIGHT OF 150 ± 3 PCF. AGGREGATES FOR NORMAL WEIGHT CONCRETE SHALL CONFORM TO ASTM C33.
- WHEN SPECIFIED FOR USE LIGHTWEIGHT (LWT) CONCRETE SHALL HAVE A DRY UNIT WEIGHT OF 110 ± 3 PCF. AGGREGATES FOR LIGHTWEIGHT CONCRETE SHALL BE EXPANDED SHALE AGGREGATE CONFORMING TO ASTM C330.
- 4. CEMENT SHALL CONFORM TO PORTLAND CEMENT ASTM C-150 (TYPE II) UNLESS NOTED OTHERWISE. WHEN USED IN THE CONCRETE MIX, FLY ASH SHALL CONFORM TO ASTM C618 CLASS F OR N.
- 5. MIXING WATER SHALL CONFORM TO ASTM C1602.
- ADMIXTURES SHALL CONFORM TO THE FOLLOWING: A. WATER REDUCTION AND SETTING TIME MODIFICATION: ASTM C494 B. PRODUCING FLOWING CONCRETE: **ASTM C1017** C. AIR ENTRAINMENT ASTM C260 D. INHIBITING CHLORIDE-INDUCED CORROSION: **ASTM C1582**
- ALL NON-SHRINK GROUT SHALL CONFORM TO ASTM C1107/C1107M AND SHALL BE PRE-MIXED COMPOUND CONSISTING OF NON-METALLIC AGGREGATE, CEMENT AND WATER-REDUCING AND PLASTICIZING AGENTS.

8. CONCRETE SHALL ATTAIN THE FOLLOWING MINIMUM COMPRESSIVE STRENGTH (F'C) AT 28 DAYS AND SHALL MEET THE

- A. MINIMUM COMPRESSIVE STRENGTH AT 48 HOURS:
- B. MINIMUM COMPRESSIVE STRENGTH AT 28 DAYS:
- OTHER REQUIREMENTS INDICATED BELOW: A. FOOTINGS: 3,000 PSI, NWT, 1 1/2" AGGREGATE, 0.45 W/C
- B. SLABS ON GRADE 3,000 PSI, NWT, 1" AGGREGATE, 0.45 W/C
- C. ALL OTHER CONCRETE: 3,000 PSI, NWT, 1" AGGREGATE, 0.45 W/C
- MAXIMUM SLUMP FOR CONCRETE MIXES SHALL BE 5" TYPICALLY AND 4" FOR ALL FLATWORK, WHETHER ON GRADE OR ELEVATED, EXCEPT WHEN A HIGH RANGE WATER REDUCING ADMIXTURE IS SPECIFIED FOR USE IN THE CONCRETE MIX DESIGN, SLUMP SHALL BE A MAXIMUM OF 9".
- 10. CONCRETE MIX DESIGN SHALL BE PREPARED BY AN APPROVED TESTING LAB AND A REGISTERED CIVIL ENGINEER AND SUBMITTED TO THE STRUCTURAL ENGINEER OF RECORD (SEOR) FOR REVIEW. CONCRETE MIX DESIGN SUBMITTALS SHALL BE STAMPED AND SIGNED BY THE LICENSED ENGINEER RESPONSIBLE FOR THE MIX DESIGN.
- 11. WHEN USED, AIR ENTRAINMENT SHALL NOT BE MORE THAN 5%.
- 12. ALL FURNISHED CONCRETE MIX DESIGNS SHALL REFLECT PROVEN CONCRETE SHRINKAGE CHARACTERISTICS OF 0.0004 IN/IN (0.04%) FINAL SHRINKAGE STRAIN OR LESS AT ALL SLABS (INCLUDING TOPPING SLABS WHERE THEY OCCUR), AND 0.0006 IN/IN (0.06%) FINAL SHRINKAGE STRAIN OR LESS AT OTHER CONCRETE ELEMENTS, AS DETERMINED IN ACCORDANCE WITH ASTM C157.
- 13. CONCRETE SHALL BE CONVEYED TO FINAL LOCATION BY METHODS THAT PREVENT SEGREGATION OR LOSS OF CONSTITUENTS AND ENSURE THE REQUIRED CONCRETE QUALITY.
- 14. WATER SHALL NOT BE ADDED TO CONCRETE AT THE SITE.
- 15. LOCATE CONSTRUCTION AND/OR CONTROL JOINTS AS INDICATED IN CONTRACT DOCUMENTS AND/OR SUBMIT INFORMATION FOR ACCEPTANCE OF PROPOSED LOCATION AND TREATMENT OF JOINTS NOT INDICATED IN CONTRACT
- 16. ALL CONSTRUCTION JOINTS SHALL BE ROUGHENED TO 1/4" AMPLITUDE, THOROUGHLY CLEANED AND ALL LAITANCE REMOVED. LONGITUDINAL KEYWAYS, 1 1/2" DEEP, SHALL BE USED WHERE INDICATED IN THE CONTRACT DOCUMENTS. ALL JOINTS SHALL BE THOROUGHLY DAMPENED, BUT WITHOUT STANDING WATER, IMMEDIATELY BEFORE PLACING NEW
- 17. THE CONTRACTOR(S) SHALL BE RESPONSIBLE FOR COORDINATING WITH ALL TRADES TO VERIFY THE LOCATION OF ALL ITEMS SUCH AS, BUT NOT LIMITED TO, SLEEVES, ANCHORS, ANCHOR BOLTS, CONDUITS, EMBED PLATES ETC. TO BE INSTALLED WITHIN CONCRETE ELEMENTS. EMBEDDED ITEMS NOT SPECIFICALLY SHOWN IN THE STRUCTURAL DRAWINGS SHALL BE LOCATED BY THE TRADES/SUB-CONTRACTORS INVOLVED, AND SHALL BE REVIEWED BY THE SEOR PRIOR TO PLACEMENT OF CONCRETE. IN COORDINATING THE LOCATION OF EMBEDDED ITEMS NOT OTHERWISE LOCATED IN THE STRUCTURAL DRAWINGS, PRIORITY SHALL BE GIVEN TO MAINTAIN SPACING AND CONTINUITY OF ALL REINFORCING. EMBEDDED ITEMS SHALL BE WELL DISTRIBUTED TO AVOID CLUSTERING IN SUCH A MANNER AS TO REQUIRE CUTTING OR RELOCATION OF REINFORCING STEEL.
- 18. UNLESS OTHERWISE NOTED, BOLTS EMBEDDED IN CONCRETE SHALL BE ASTM F-1554 GR 36. ALL EMBEDDED ANCHOR BOLTS SHALL BE HEADED-TYPE. DO NOT USE J-TYPE BOLTS.
- 19. UNLESS OTHERWISE NOTED, A 3/4" CHAMFER SHALL BE PROVIDED AT EXPOSED EDGES OF CONCRETE BEAMS AND
- 20. PRIOR TO PLACING CONCRETE, ALL EMBEDDED ITEMS, INCLUDING REINFORCING STEEL, SHALL BE WELL SECURED IN POSITION. CONCRETE SHALL NOT BE POURED UNTIL ALL FORMS AND REINFORCING HAVE BEEN INSPECTED, ALL PREPARATIONS FOR THE PLACEMENT HAVE BEEN COMPLETED, AND THE PREPARATIONS HAVE BEEN REVIEWED BY THE PROJECT INSPECTOR.
- 21. ONLY ONE GRADE OF CONCRETE SHALL BE ALLOWED AT THE JOB SITE AT ANY ONE TIME.
- 22. CONCRETE TO BE PLACED DURING COLD WEATHER SHALL COMPLY WITH ACI 306R, "GUIDE TO COLD WEATHER CONCRETING" AND ACI 306.1, "STANDARD SPECIFICATION FOR COLD WEATHER CONCRETING".
- 23. CONCRETE TO BE PLACED DURING HOT WEATHER SHALL COMPLY WITH ACI 305R, "GUIDE TO HOT WEATHER CONCRETING" AND ACI 305.1, "STANDARD SPECIFICATION FOR HOT WEATHER CONCRETING".
- 24. CONCRETE SHALL BE MAINTAINED IN A CONTINUOUSLY MOIST CONDITION ABOVE 50F FOR A MINIMUM OF SEVEN (7) DAYS AFTER PLACEMENT. THE 7-DAY REQUIREMENT MAY BE REDUCED TO 3 DAYS FOR HIGH-EARLY-STRENGTH CONCRETE. ALTERNATE ACCELERATED CURING METHODS MAY BE APPROVED BY THE SEOR IF SATISFACTORY PERFORMANCE CAN
- 25. EQUIPMENT SHALL NOT BE PLACED ON CONCRETE UNTIL CONCRETE HAS REACHED 75% OF THE MINIMUM REQUIRED COMPRESSIVE STRENGTH AND NO SOONER THAN A MINIMUM OF 72 HOURS AFTER CONCRETE PLACEMENT. IF EQUIPMENT IS TO BE ANCHORED WITH POST-INSTALLED ANCHORS. REFER TO POST-INSTALLED ANCHOR NOTES FOR MINIMUM CONCRETE STRENGTH AND SETTING TIME REQUIREMENTS FOR DRILLING HOLES FOR ANCHORS AND INSTALLATION, TORQUING, AND TESTING OF THE ANCHORS.
- 26. ALL CONCRETE SHALL BE TESTED AND INSPECTED AS REQUIRED PER THE SPECIAL INSPECTION SECTION OF THESE

### POST-INSTALLED ANCHORS:

- 1. POST INSTALLED ANCHOR NOTES IN THIS SECTION SHALL APPLY TO ALL ANCHORS (INCLUDING THREADED ROD OR REINFORCING BARS) INSTALLED INTO HARDENED CONCRETE OR MASONRY EXCEPT FOR POWDER DRIVEN FASTENERS, AS APPLICABLE, SEE POWDER DRIVEN FASTENER GENERAL NOTES FOR MORE INFORMATION.
- 2. INSTALLATION SHALL CONFORM TO THE MANUFACTURER'S INSTRUCTIONS AND THE APPLICABLE EVALUATION REPORT AND SHALL BE INSTALLED BY PERSONNEL TRAINED TO INSTALL THE TYPE OF POST-INSTALLED ANCHOR BEING
- 3. LOCATE EXISTING REINFORCING BY NON-DESTRUCTIVE METHODS PRIOR TO DRILLING. EXISTING REINFORCING SHALL
- 4. CONCRETE SHALL HAVE A MINIMUM COMPRESSIVE STRENGTH OF F'C = 2500 PSI, BE A MINIMUM OF 21 DAYS OLD AND HAVE A MINIMUM TEMPERATURE OF 50 DEGREES FAHRENHEIT WHEN DRILLING OCCURS.
- 5. HOLES FOR INSTALLATION OF THE POST-INSTALLED ANCHOR SHALL BE DRILLED USING A DRILL THAT HAS A CARBIDE-TIPPED BIT THAT COMPLIES WITH ANSI B212.15. A REBAR CUTTING DRILL BIT IS NOT ALLOWED.
- 6. CONTRACTOR SHALL USE APPROPRIATE EQUIPMENT AND METHODS AS REQUIRED TO PROVIDE DRILLED HOLES FOR POST-INSTALLED ANCHORS IN ACCORDANCE WITH APPLICABLE STANDARDS. MANUFACTURER'S RECOMMENDATIONS AND QUALIFYING (ICC) TEST REPORTS. CARE SHALL BE TAKEN TO PREVENT OVERSIZING, OVALING, AND/OR BLOW-OUT THROUGH THE BACK FACE OF THE DRILLED MEMBER. IF OVERSIZING, OVALING, AND/OR BLOW-OUT OCCURS, THE EMPLOYED EQUIPMENT AND METHODS SHALL BE DISCONTINUED. ADDITIONAL DRILLING SHALL NOT BE RESUMED UNTIL THE SEOR HAS PROVIDED APPROVED REPAIR PROCEDURES. THE CONTRACTOR SHALL BE RESPONSIBLE FOR THE COST OF ALL SUCH REPAIRS. WHEN RESUMING DRILLING, THE CONTRACTOR SHALL MODIFY THE PROCEDURES AS NECESSARY TO PREVENT FURTHER DAMAGE.
- 7. HOLES SHALL BE CLEANED OF DUST AND DEBRIS, USING A WIRE BRUSH AND COMPRESSED AIR OR MANUFACTURER'S BLOW-OUT BULB (AS PER MANUFACTURER'S RECOMMENDATIONS) AS REQUIRED TO REMOVE PARTICULATE DEBRIS AND TO ACHIEVE A RELATIVELY DUST-FREE SURFACE.
- 8. OIL, SCALE, AND RUST SHALL BE REMOVED FROM THE POST-INSTALLED ANCHOR AND HOLES SHALL BE DRY, PRIOR TO
- 9. POST-INSTALLED EMBEDMENT DEPTHS NOTED ON THE PLANS OR DETAILS ARE NOMINAL (I.E. MEASURED FROM FACE OF CONCRETE OR MASONRY TO EMBEDDED TIP OF ANCHOR/REBAR). FOR CORRESPONDING HOLE DEPTH, REFER TO APPLICABLE EVALUATION REPORT.
- 10. ANCHORS IN APPROVED ADHESIVE ANCHOR SYSTEMS SHALL HAVE MINIMUM FY = 36 KSI AND SHALL BE ZINC ELECTROPLATED OR HOT-DIP GALVANIZED AS REQUIRED PER ESR.
- 11. APPROVED ADHESIVE ANCHOR SYSTEMS AND EVALUATION REPORTS ARE AS FOLLOWS:
- A. CONCRETE: HILTI HIT-RE 500 V3 HILTI HIT-HY 200 V3 ESR-4868
- B. HORIZONTAL SLAB-ON-GRADE DOWELS: HILTI HIT-RE 100 ESR-3829 HILTI HIT-HY 100 ESR-3574
- 12. WHERE NOTED ON SPECIFIC DETAILS, INSTALLATION OF ADHESIVE ANCHORS SHALL BE BY PERSONNEL CERTIFIED BY AN APPLICABLE CERTIFICATION PROGRAM PER ACI 318 SECTION 17.8.2.2. CERTIFICATION SHALL INCLUDE WRITTEN AND PERFORMANCE TESTS IN ACCORDANCE WITH ACI/CRSI ADHESIVE ANCHOR INSTALLER CERTIFICATION PROGRAM. CERTIFICATION DOCUMENTS SHALL BE SUBMITTED TO THE SEOR AND AHJ FOR REVIEW AND ACCEPTANCE PRIOR TO
- 13. APPROVED EXPANSION ANCHORS AND EVALUATION REPORTS ARE AS FOLLOWS:
- A. CONCRETE NOT EXPOSED TO WEATHER:
- HILTI KWIK BOLT-TZ2 ANCHORS ESR-4266 SIMPSON STRONG-TIE STRONG-BOLT 2
- WEDGE ANCHOR ESR-3037
- B. CONCRETE EXPOSED TO WEATHER: STAINLESS STEEL HILTI KWIK BOLT-TZ2
  - ANCHORS ESR-4266
- DEWALT POWER-STUD+ SD4 OR SD6 ESR-2502
- STAINLESS STEEL SIMPSON STRONG-TIE STRONG-BOLT 2 WEDGE ANCHOR ESR-3037
- 14. WHERE APPLICABLE, EXPANSION ANCHORS SHALL BE INSTALLED WITH THE MINIMUM TORQUE, USING A CALIBRATED TORQUE WRENCH. WEDGE OR SLEEVE TYPE ANCHORS MUST ATTAIN THE SPECIFIED TORQUE WITHIN ONE HALF TURN OF THE NUT, EXCEPT 1/4" AND 3/8" DIAMETER WEDGE OR SLEEVE TYPE ANCHORS MUST ATTAIN SPECIFIED TORQUE WITHIN ONE QUARTER TURN OF THE NUT.
- 15. INSTALLATION TORQUES FOR EXPANSION ANCHORS SHALL BE AS NOTED BELOW:

EXPANSION ANCHOR MAXIMUM INSTALLATION TORQUE LOADS IN CONCRETE (FT-LB)				
NOMINAL ANCHOR DIAMETER	HILTI KWIK BOLT TZ2	SIMPSON STRONG BOLT 2		
1/4"	4CS/6SS	4		
3/8"	30	30		
1/2"	50CS/40SS	60		
5/8"	40CS/60SS	90CS/ 80 SS		
3/4"	110CS/125SS	150		
1"	185	N/A		

- 16. APPROVED SCREW ANCHORS AND EVALUATION REPORTS ARE AS FOLLOWS:
- A. CONCRETE:
- HILTI KH-EZ OR KH-EZ P ANCHORS ESR-3027
- DEWALT SCREW-BOLT+ ESR-3889 DEWALT ULTRACON+
- ESR-3068
- SIMPSON TITEN HD ESR-2713 ITW RED HEAD TAPCON+ ESR-3699

## 17. INSTALLATION TORQUES FOR SCREW ANCHORS SHALL BE AS NOTED BELOW:

NOMINAL ANCHOR DIAMETER HILTI KH-EZ OR KH-EZ P		DEWALT SCREW BOLT+	SIMPSON TITEN HD	ITW RED HEAD TAPCON+
1/4"	18	19 AT 1 5/8" EMBED / 25 AT 2 1/2" EMBED	24	20
3/8"	40 (19 AT EMBED < 1 5/8")	25 AT 2" & 2 1/2" EMBED / 40 AT 3 1/4" EMBED	50	50
1/2"	45	45 AT 2 1/2" & 3" EMBED / 60 AT 4 1/4" EMBED	65	70
5/8"	85	60	100	N/A
3/4"	95	70	150	N/A

SCREW ANCHOR MAYIMIM INSTALL ATION

18. SEE SPECIAL INSPECTION AND TESTING NOTES FOR INSPECTION REQUIREMENTS

### SPECIAL INSPECTIONS:

- 1. THE OWNER, OR THE OWNER'S AUTHORIZED AGENT (OTHER THAN THE CONTRACTOR AS APPLICABLE) SHALL EMPLOY ONE OR MORE SPECIAL INSPECTORS, INCLUDING AS APPLICABLE AN INSPECTOR OF RECORD (IOR), WHO SHALL PROVIDE SPECIAL INSPECTIONS DURING CONSTRUCTION FOR CERTAIN TYPES OF WORK WHEN SO SPECIFIED IN THE CONTRACT DOCUMENTS AND PROJECT SPECIFICATIONS. WHERE AN IOR IS REQUIRED BY THE GOVERNING AGENCY, THE IOR MAY PERFORM SPECIAL INSPECTIONS IF THAT PERSON IS QUALIFIED PER THE GOVERNING AGENCY'S STANDARDS FOR THE SPECIAL INSPECTION REQUIRED. WHERE AN IOR IS NOT REQUIRED, THESE SPECIAL INSPECTIONS SHALL BE IN ADDITION TO AND COMPLEMENTARY WITH THE INSPECTIONS PROVIDED BY THE GOVERNING AGENCY.
- 2. THE SPECIAL INSPECTOR SHALL BE A QUALIFIED PERSON FROM AN APPROVED AGENCY CONFORMING TO ASTM C1077 WHO SHALL DEMONSTRATE COMPETENCE, TO THE SATISFACTION OF THE ARCHITECT, STRUCTURAL ENGINEER OF RECORD AND THE GOVERNING AGENCY, FOR INSPECTION OF THE PARTICULAR TYPE OF CONSTRUCTION OR OPERATION REQUIRING SPECIAL INSPECTION.
- 3. THE SPECIAL INSPECTOR SHALL OBSERVE THE WORK ASSIGNED FOR CONFORMANCE WITH THE DESIGN DRAWINGS. SPECIFICATIONS AND APPLICABLE WORKMANSHIP PROVISIONS OF THE CODE AND OTHER APPLICABLE REGULATIONS IDENTIFIED WITHIN THE CONSTRUCTION DOCUMENTS. ALL DISCREPANCIES SHALL BE BROUGHT TO THE IMMEDIATE ATTENTION OF THE GENERAL CONTRACTOR FOR CORRECTION AND THEN, IF UNCORRECTED, TO THE ATTENTION OF THE ARCHITECT, STRUCTURAL ENGINEER OF RECORD AND THE GOVERNING AGENCY. IT SHALL BE THE GENERAL CONTRACTOR'S RESPONSIBILITY TO COORDINATE WITH THE SPECIAL INSPECTOR AND SCHEDULE THE SPECIAL INSPECTIONS WITH ADEQUATE TIME TO ADDRESS ANY AND ALL POTENTIAL DISCREPANCIES PRIOR TO PROCEEDING WITH SUBSEQUENT WORK THAT COVERS OR OTHERWISE MAKES INACCESSIBLE ANY WORK IDENTIFIED AS DEVIATING FROM THE PROJECT REQUIREMENTS.
- 4. THE SPECIAL INSPECTOR SHALL FURNISH REGULAR INSPECTION REPORTS TO THE ARCHITECT, STRUCTURAL ENGINEER OF RECORD AND THE GOVERNING AGENCY IDENTIFYING THE WORK INSPECTED AND ANY UNCORRECTED DISCREPANCIES FROM THE CONSTRUCTION DOCUMENTS. AT THE CONCLUSION OF THE PROJECT OR THE SPECIAL INSPECTORS ASSIGNED SCOPE OF WORK, THE SPECIAL INSPECTOR SHALL SUBMIT A FINAL SIGNED REPORT STATING WHETHER THE WORK REQUIRING SPECIAL INSPECTION WAS, TO THE BEST OF HIS OR HER KNOWLEDGE, COMPLETED IN CONFORMANCE WITH THE CONSTRUCTION DOCUMENTS AND SPECIFICATIONS (INCLUDING APPROVED RFI'S, ADDENDUMS, ETC.) AND THE APPLICABLE WORKMANSHIP PROVISIONS OF THE CODE AND OTHER APPLICABLE REGULATIONS IDENTIFIED WITHIN THE CONSTRUCTION DOCUMENTS.
- 5. UNLESS NOTED OTHERWISE, SPECIAL INSPECTIONS INDICATED BELOW SHALL BE PROVIDED IN EITHER A CONTINUOUS OR PERIODIC CAPACITY, AS DEFINED BELOW, AS REQUIRED BY THE INDIVIDUAL CODE OR REFERENCED STANDARD.
- 6. CONTINUOUS SPECIAL INSPECTION BY THE SPECIAL INSPECTOR WHO IS PRESENT WHEN AND WHERE THE WORK TO BE INSPECTED IS BEING PERFORMED.
- 7. PERIODIC SPECIAL INSPECTION BY THE SPECIAL INSPECTOR WHO IS INTERMITTENTLY PRESENT WHERE THE WORK TO BE INSPECTED HAS BEEN OR IS BEING PERFORMED. FOR STRUCTURAL STEEL, PERIODIC INSPECTION IS FURTHER DEFINED SUCH THAT ITEMS ARE OBSERVED ON A RANDOM BASIS.
- 8. FOR STRUCTURAL STEEL WELDING AND BOLTING, SPECIAL INSPECTION SHALL BE PROVIDED IN EITHER AN OBSERVE OR PERFORM CAPACITY AS DEFINED BELOW:
- OBSERVE (O) INSPECTOR SHALL OBSERVE THESE ITEMS ON A RANDOM BASIS PERFORM (P) - INSPECTOR SHALL OBSERVE OR PERFORM SPECIFIED TASK FOR EACH WELDED OR BOLTED JOINT
- 9. QUALITY CONTROL (QC) INSPECTION TASKS SHALL BE PERFORMED BY THE FABRICATOR'S OR ERECTOR'S QC INSPECTOR (QCI) AS INDICATED. QUALITY ASSURANCE (QA) INSPECTION TASKS SHALL BE PERFORMED BY THE QA INSPECTOR (QAI) AS INDICATED. WHEN A TASK IS INDICATED TO BE PERFORMED BY BOTH THE QAI AND QCI, COORDINATION IS PERMITTED SO THAT THE INSPECTION FUNCTIONS ARE PERFORMED BY ONLY ONE PARTY. WHEN THE QAI RELIES ON THE QCI, THE APPROVAL OF THE SEOR AND AGENCY HAVING JURISDICTION IS REQUIRED.
- 10. THE FOLLOWING CONSTRUCTION ELEMENTS AND MATERIALS SHALL BE INSPECTED AND EVALUATED BY A SPECIAL INSPECTOR IN ACCORDANCE WITH THE NOTED CBC SECTIONS AND REFERENCED STANDARDS, WHERE ELEMENTS AND MATERIALS ARE PRESENT ON THE PROJECT. SEE GENERAL NOTES FOR EACH MATERIAL FOR ADDITIONAL REQUIREMENTS, IN ADDITION TO TABLES AND NOTES BELOW:

## **FOUNDATION SPECIAL INSPECTION TABLES:**

OR MEMBER

### REQUIRED VERIFICATION AND INSPECTION OF SOILS PER CBC TABLE 1705.6

	VERIFICATION AND INSPECTION	CONTINUOUS DURING TASK LISTED	PERIODICALLY DURING TASK LISTED
1.	VERIFY MATERIALS BELOW SHALLOW FOUNDATIONS ARE ADEQUATE TO ACHIEVE THE DESIGN BEARING CAPACITY		Х
2.	VERIFY EXCAVATIONS ARE EXTENDED TO PROPER DEPTH AND HAVE REACHED PROPER MATERIAL		Х
3.	PERFORM CLASSIFICATION AND TESTING OF COMPACTED FILL MATERIALS		Х
4.	VERIFY USE OF PROPER MATERIALS, DENSITIES AND LIFT THICKNESSES DURING PLACEMENT AND COMPACTION OF COMPACTED FILL	Х	
5.	PRIOR TO PLACEMENT OF COMPACTED FILL, INSPECT SUBGRADE AND VERIFY THAT SITE HAS BEEN PREPARED PROPERLY		Х

FOUNDATION SPECIAL INSPECTION NOTES: 1. FOR STEEL, CONCRETE OR CONCRETE-FILLED ELEMENTS PERFORM ADDITIONAL INSPECTIONS INDICATED BELOW AS APPLICABLE.

## **CONCRETE SPECIAL INSPECTION TABLE:**

### REQUIRED VERIFICATION AND INSPECTION OF CONCRETE CONSTRUCTION PER CBC TABLE 1705.3

CONTINUOUS | PERIODICALLY |

_	NAME OF DELLESS OF LEVE	LISTED	LISTED	MISC. STANDARDS	CBC
1.	INSPECT REINFORCEMENT, INCLUDING PRESTRESSING TENDONS, AND VERIFY PLACEMENT		Х	ACI 318: CH. 20, 25.2, 25.3, 26.5.1-26.5.3	1908.4
2.	REINFORCING BAR WELDING: A. VERIFY WELDABILITY OF REINFORCING BARS OTHER THAN ASTM A706; B. INSPECT SINGLE-PASS FILLET WELDS, MAX. 5/16"; C. INSPECT ALL OTHER WELDS	х	x x	AWS D1.4 ACI 318: CH 26.5.4	
3.	INSPECTION OF ANCHORS CAST IN CONCRETE		Х	ACI 318: CH 17.8.2	
4.	INSPECT ANCHORS POST-INSTALLED IN HARDENED CONCRETE MEMBERS (SEE NOTE 1 BELOW):  A. ADHESIVE ANCHORS INSTALLED IN HORIZONTALLY OR UPWARDLY INCLINED ORIENTATIONS TO RESIST SUSTAINED TENSION LOADS.  B. MECHANICAL ANCHORS AND ADHESIVE ANCHORS NOT DEFINED IN 4A.	х	х	ACI 318: CH 17.8.2.4	
5.	VERIFY USE OF REQUIRED DESIGN MIX		Х	ACI 318: CH. 19, 26.4.3, 26.4.4	1904.1, 1904.2, 1908.2, 1908.3
6.	PRIOR TO CONCRETE PLACEMENT, FABRICATE SPECIMENS FOR STRENGTH TESTS (SEE NOTE 2 BELOW), PERFORM SLUMP AND AIR CONTENT TESTS, AND DETERMINE THE TEMPERATURE OF THE CONCRETE	х		ASTM C 172 ASTM C 31 ACI 318: CH 26.4.5, 26.12	1908.10
7.	INSPECT CONCRETE AND SHOTCRETE PLACEMENT FOR PROPER APPLICATION TECHNIQUES	Х		ACI 318: CH 26.4.5	1908.6, 1908.7, 1910.8
8.	INSPECTION FOR MAINTENANCE OF SPECIFIED CURING TEMPERATURE AND TECHNIQUES		Х	ACI 318: CH 5.11-5.13	1908.9
9.	INSPECT PRESTRESSED CONCRETE FOR:  A. APPLICATION OF PRESTRESSING FORCES B. GROUTING OF BONDED PRESTRESSING TENDONS	x x		ACI 318: CH 26.9.2.1, 26.9.2.3	-
10.	INSPECT ERECTION OF PRECAST CONCRETE MEMBERS		Х	ACI 318: CH. 26.8	
11.	VERIFICATION OF IN-SITU CONCRETE STRENGTH, PRIOR TO STRESSING OF TENDONS IN POST- TENSIONED CONCRETE AND PRIOR TO REMOVAL OF SHORES AND FORMS FROM BEAMS AND STRUCTURAL SLABS		х	ACI 318: CH 26.10.2	
12.	INSPECT FORMWORK FOR SHAPE, LOCATION AND DIMENSIONS OF THE CONCRETE MEMBER BEING FORMED		Х	ACI 318: CH 26.10.1(B)	

SPECIFIC REQUIREMENTS FOR SPECIAL INSPECTION ARE INCLUDED IN THE RESEARCH REPORT FOR EACH POST-INSTALLED ANCHOR ISSUED BY AN APPROVED SOURCE. THESE SPECIAL INSPECTION REQUIREMENTS SHOULD BE FOLLOWED. WHERE SPECIFIC REQUIREMENTS ARE NOT PROVIDED, CONTACT STRUCTURAL ENGINEER FOR SPECIAL INSPECTION REQUIREMENTS PRIOR TO PROCEEDING WITH THE WORK. PROJECT SPECIFIC SPECIAL INSPECTION MEASURES SHALL BE APPROVED BY THE GOVERNING AGENCY PRIOR TO THE COMMENCEMENT OF THE WORK.

- 2. A STRENGTH TEST SHALL BE THE AVERAGE OF, AT A MINIMUM, TWO 6x12 CYLINDERS OR THREE 4x8 CYLINDERS MADE FROM THE SAME SAMPLE OF CONCRETE. A TESTING CONCRETE BUT NOT LESS THAN ONE SAMPLE SET FOR EACH 5,000 SQFT OF SURFACE AREA FOR SLABS OR WALLS. IF TOTAL VOLUME OF CONCRETE IS SUCH THAT FREQUENCY OF TESTING WOULD PRODUCE FEWER THAN 5 STRENGTH TESTS FOR A GIVEN CONCRETE MIXTURE, THEN STRENGTH TEST SPECIMENS SHALL BE MADE FROM AT LEAST 5 RANDOMLY SELECTED BATCHES OR FROM EACH BATCH IF FEWER THAN 5 BATCHES ARE USED.
- 3. CONTINUOUS INSPECTION IS REQUIRED DURING THE FABRICATION AND SUBSEQUENT INSPECTION OF SHOTCRETE PRE-CONSTRUCTION TEST PANELS.

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**DEPARTMENT OF PUBLIC WORKS** 900 SOUTH FREMONT AVE. 8TH FLOOR ALHAMBRA, CA 91803

PROJECT

CAMP GLENN ROCKEY SECURITY UPGRADES

LOCATION :

1900 N. SYCAMORE ROAD. SAN DIMAS, CA 91773

ARCHITECT



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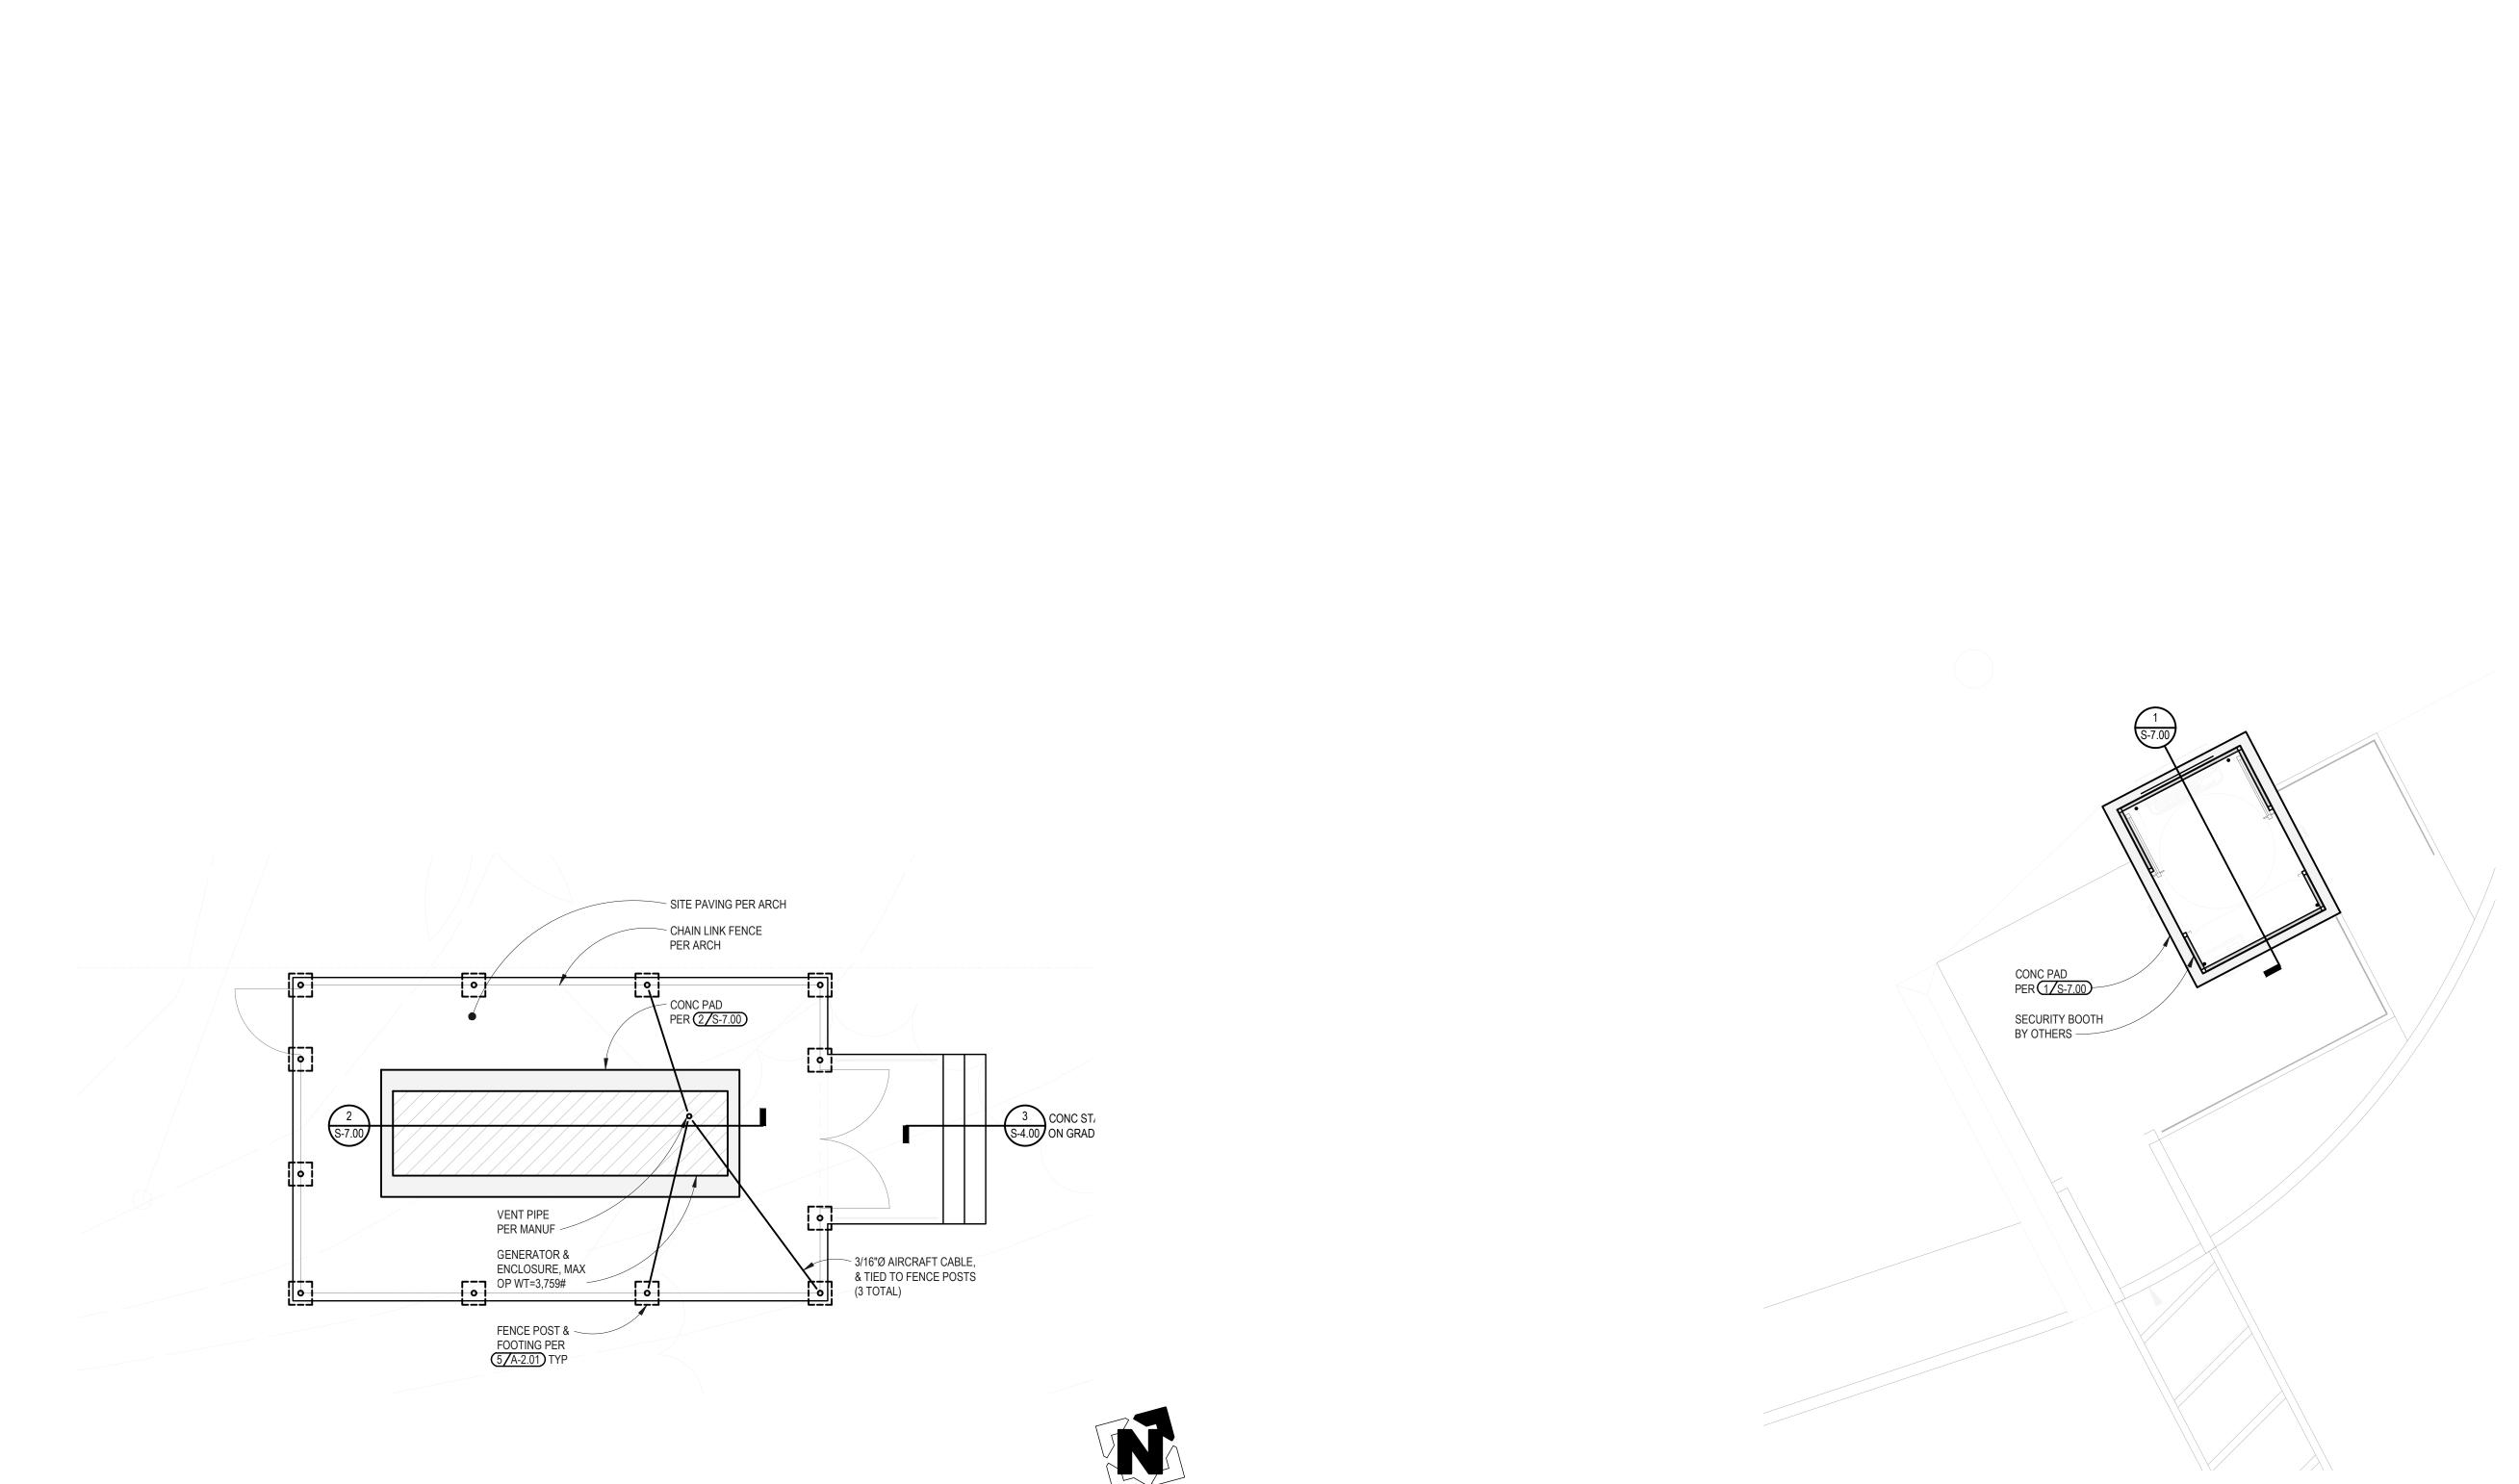
LONG BEACH OFFICE 3900 Cover Street, Long Beach CA 90808 • 562.985.3200 Project: 23-0177-00

STRUCTURAL NOTES

04-17-2024 DRAWN BY: CHECKED BY: GM/SH

SHEET NUMBER:

**S-1.01** 



**PLAN NOTES** 

SEE GENERAL NOTES SHEET(S) FOR APPLICABLE NOTES AND ABBREVIATIONS.

EXISTING CONSTRUCTION IS SHOWN FADED AND IS LABELED AS EXISTING OR (E). NEW CONSTRUCTION IS SHOWN DARK AND IS SPECIFICALLY REFERENCED BY DETAILS AND NOTES.

EXISTING CONDITIONS ARE SHOWN TO THE BEST OF OUR KNOWLEDGE. CONTRACTOR IS RESPONSIBLE FOR VERIFYING ACTUAL CONDITIONS. DISCREPANCIES BETWEEN ACTUAL FIELD CONDITIONS AND THOSE SHOWN ON THESE DRAWINGS SHALL BE BROUGHT TO THE ATTENTION OF THE ENGINEER PRIOR TO PROCEEDING.

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**CAMP GLENN ROCKEY SECURITY UPGRADES** 

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TITLE:

PARTIAL SITE PLAN

SCALE:	AS NOTED
DATE:	04-17-2024
DRAWN BY:	JA
CHECKED BY:	GM/SH

SHEET NUMBER: **S-2.00** 

PARTIAL SITE PLAN - NEW SECURITY BOOTH

SCALE: 1/4" = 1'-0"

PARTIAL SITE PLAN - NEW GENERATOR

SCALE: 1/4" = 1'-0"

